

PROJECT LOCATION PLAN
SCALE: 1" = 1000'

TOWN OF LEDYARD, CT

COLONEL LEDYARD HIGHWAY MULTI-USE PATHWAY PRELIMINARY PLANNING AND DESIGN IMPROVEMENTS




FRED ALLYN, III
MAYOR

STEVE MASALIN, P.E.
DIRECTOR OF PUBLIC WORKS

JOSEPH TILLMANN
HIGHWAY SUPERINTENDENT

COLONEL LEDYARD HIGHWAY MULTI-USE PATHWAY (STA: 10+00 TO 66+32)

FOR PERMITTING ONLY

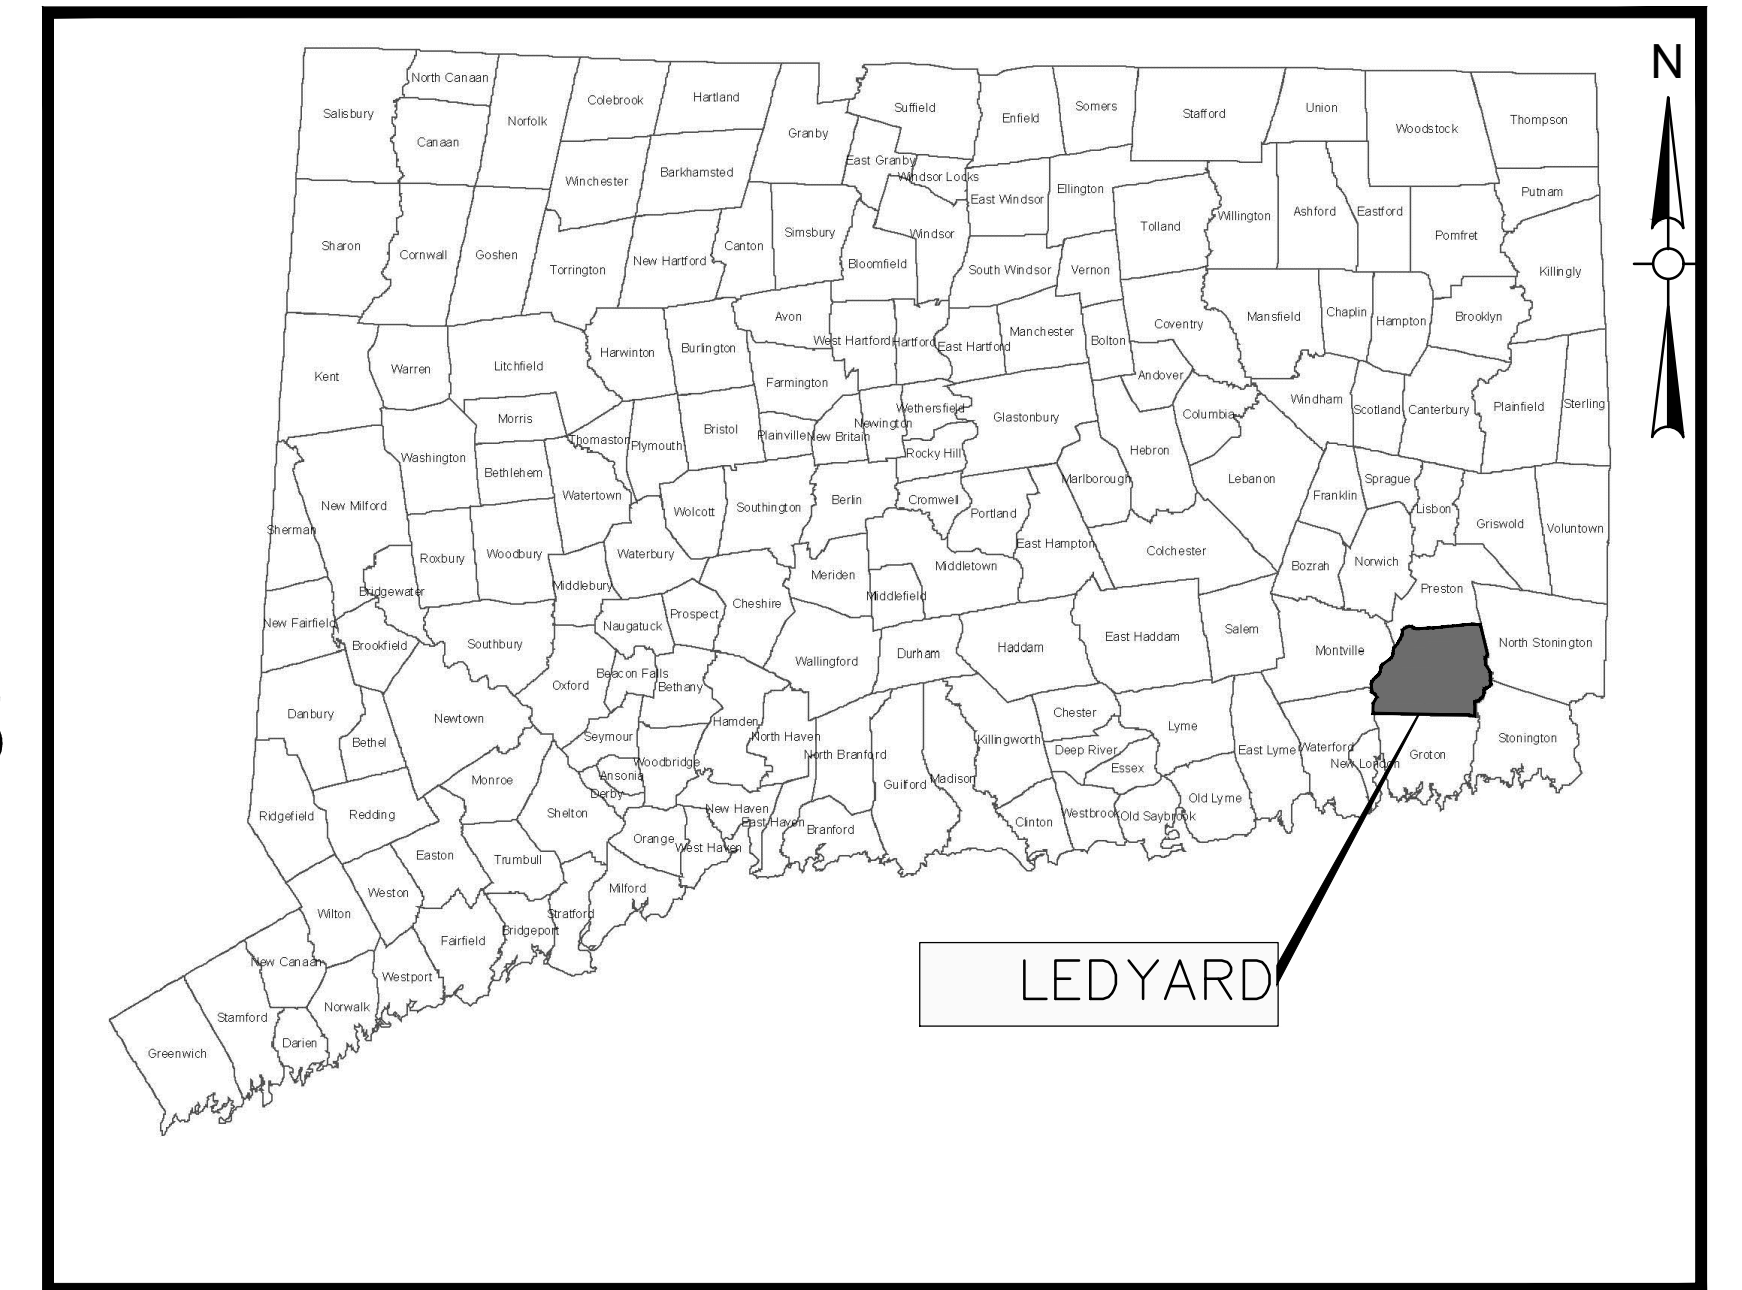

TOWN LOCATION MAP
SCALE: N.T.S.

PROJECT SPECIFICATIONS:
CONNECTICUT DEPARTMENT OF
TRANSPORTATION, STANDARD SPECIFICATIONS
FOR ROADS, BRIDGES, FACILITIES AND
INCIDENTAL CONSTRUCTION, FORM 818, DATED
2020; AND SPECIAL PROVISIONS

SURVEY INFORMATION DERIVED FROM:
WESTON & SAMPSON LAND SURVEYORS, INC.

VERTICAL DATUM - NAVD88
HORIZONTAL DATUM - NAD83

DESIGNED BY:
WESTON & SAMPSON ENGINEERS, INC.
712 BROOK STREET, SUITE 103
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CT. LIC. NO. XXXXX

MARCH 15, 2019

Issued Date:

JUNE 2022

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Know what's below.
Call before you dig.

Issued For:

NOT RELEASED FOR CONSTRUCTION

CONSTRUCTION NOTES:

GENERAL:

- 1. SYMBOLS AND LEGENDS OF PROJECT FEATURES ARE GRAPHIC REPRESENTATIONS AND ARE NOT NECESSARILY SHOWN ON THE DRAWINGS TO SCALE OR TO THEIR ACTUAL DIMENSIONS OR LOCATION. COORDINATE DETAIL SHEET DIMENSIONS, MANUFACTURERS' LITERATURE, SHOP DRAWINGS AND FIELD MEASUREMENTS OF SUPPLIED PRODUCTS FOR LAYOUT OF THE PROJECT FEATURES.
2. DO NOT RELY SOLELY ON ELECTRONIC VERSIONS OF THESE DRAWINGS, SPECIFICATIONS, AND DATA FILES THAT ARE PROVIDED BY THE ENGINEER. FIELD VERIFY LOCATION OF PROJECT FEATURES.
3. THE CONTRACTOR SHALL PERFORM NECESSARY CONSTRUCTION NOTIFICATIONS, APPLY FOR AND OBTAIN NECESSARY PERMITS, PAY FEES, AND POST BONDS ASSOCIATED WITH THE WORK AS REQUIRED BY THE CONTRACT DOCUMENTS.
4. FENCES, MAIL BOXES, ETC. SHALL BE REMOVED AND REPLACED AS NECESSARY TO PERFORM THE WORK. UNLESS OTHERWISE INDICATED, ALL SUCH WORK SHALL BE PAID FOR UNDER CLEARING AND GRUBBING.
5. ALL AREAS DISTURBED BY THE CONTRACTOR BEYOND PAYMENT LIMITS SHALL BE RESTORED AT NO ADDITIONAL COST TO THE TOWN. PAVEMENT SHALL BE REPLACED IN ACCORDANCE WITH THE SPECIFICATIONS AND AS SHOWN ON THE DRAWINGS.
6. THE CONTRACTOR SHALL MAINTAIN SIDE SLOPES AND DRAINAGE SWALES DURING CONSTRUCTION TO PREVENT PONDING AND EROSION.
7. THE CONTRACTOR SHALL NOT STORE ANY APPARATUS, MATERIALS, SUPPLIES OR EQUIPMENT ON DRAINAGE STRUCTURES OR WITHIN 100 FEET OF WETLANDS.
8. THE CONTRACTOR SHALL GRADE PROPOSED SLOPES TO MEET EXISTING SLOPES WHERE SHOWN ON PLANS, IN ACCORDANCE WITH THE MINIMUM AND MAXIMUM SLOPES SPECIFIED.
9. ALL STREET EXCAVATIONS SHALL BE COMPLETELY CLOSED AT THE END OF EACH WORKING DAY BY BACKFILLING. COVERING WITH STEEL PLATES MAY BE ALLOWED IF APPROVED BY THE ENGINEER.
10. WHERE ENCOUNTERED, UNSUITABLE MATERIAL SHALL BE REMOVED TO A DEPTH OF AT LEAST 12-INCHES BELOW THE BOTTOM OF TRENCH EXCAVATIONS AND REPLACED WITH GRANULAR FILL, UNLESS OTHERWISE SPECIFIED.
11. DURING THE PROCESS OF WORK, THE CONTRACTOR SHALL CONDUCT OPERATIONS AND MAINTAIN THE AREA OF CONSTRUCTION ACTIVITIES, INCLUDING SWEEPING AND WATER FOR DUST CONTROL AS NECESSARY, TO MINIMIZE CREATION AND DISPERSION OF DUST.
12. WHERE EXISTING FENCES ARE TO BE REMOVED AND RESET, A TEMPORARY CONSTRUCTION FENCE SHALL BE ERECTED AFTER REMOVAL FOR THE PROTECTION OF THE RESIDENTS. TEMPORARY CONSTRUCTION FENCES SHALL BE PAID FOR UNDER CLEARING AND GRUBBING.
13. ALL HIGHWAY LINE MONUMENTATION WITHIN THE PROJECT LIMITS MUST BE DELINEATED AND PROTECTED FROM DAMAGE OR MOVEMENT. ANY COST ASSOCIATED WITH RESETTING OF THE MONUMENTATION SHALL BE AT THE CONTRACTOR'S EXPENSE IF DISTURBED BY CONTRACTOR.
14. THE CONTRACTOR SHALL COMPLETE ALL LAYOUTS, SURVEYS, ETC. REQUIRED FOR CONSTRUCTION OF THE PROJECT AS SHOWN AND AS SPECIFIED.
15. THE CONTRACTOR IS RESPONSIBLE TO ENSURE THAT THE PROPER STORM DRAINAGE AND SANITARY FLOWS ARE MAINTAINED THROUGHOUT THE CONSTRUCTION DURATION.
16. ALL PROPOSED MANHOLES, MANHOLE COVERS AND FRAMES, CATCH

BASINS, AND CATCH BASIN GRATES AND FRAMES SHALL CONFORM TO THE REQUIREMENTS AS SHOWN IN THE CONTRACT PLANS AND DOCUMENTS.

- 17. REMOVAL OF ALL TREES WITHIN THE EXCAVATION LINES SHALL BE PAID FOR BY CLEARING AND GRUBBING.
18. ALL GUIDE RAIL SHALL BE CONSTRUCTED IN ACCORDANCE WITH THE LATEST EDITION OF THE DEPARTMENT OF TRANSPORTATION'S STANDARD SPECIFICATIONS AND ISSUED REVISIONS/SUPPLEMENTS, AND STANDARD DETAILS.

WORK RESTRICTIONS:

- 1. DO NOT CLOSE OR OBSTRUCT ROADWAYS, SIDEWALKS, FIRE HYDRANTS, AND UTILITIES WITHOUT APPROPRIATE PERMITS.
2. NO WORK WILL BE ALLOWED TO BE PERFORMED ON SUNDAY AND ON ALL TOWN HOLIDAYS WITHOUT TOWN AUTHORIZATION.
3. ALL CONSTRUCTION ACTIVITIES, INCLUDING THE LOADING AND UNLOADING OF MATERIALS AND EQUIPMENT, SHALL BE LIMITED TO MONDAY THROUGH FRIDAY FROM 7:00 AM TO 6:00 PM AND SATURDAY FROM 9:00 AM TO 5:00 PM UNLESS OTHERWISE AUTHORIZED BY THE TOWN. TOWN MUST BE NOTIFIED AT LEAST 24-HOURS IN ADVANCE OF ANY WORK ON SATURDAY.

REGULATORY REQUIREMENTS:

- 1. WITHIN LOCAL RIGHTS-OF-WAY, PERFORM THE WORK IN ACCORDANCE WITH THE LATEST EDITION OF THE DEPARTMENT OF TRANSPORTATION'S STANDARD SPECIFICATIONS AND ISSUED REVISIONS AS SUPPLEMENTED BY THE TECHNICAL SPECIFICATIONS INCLUDED IN THIS CONTRACT.
2. WITHIN STATE RIGHTS-OF-WAY, PERFORM THE WORK IN ACCORDANCE WITH THE LATEST EDITION OF THE DEPARTMENT OF TRANSPORTATION'S STANDARD SPECIFICATIONS AND ISSUED REVISIONS/SUPPLEMENTS.
3. PROVIDE TRAFFIC SIGNAGE AND PAVEMENT MARKINGS IN CONFORMANCE WITH THE LATEST EDITION OF THE MANUAL ON UNIFORM TRAFFIC CONTROL DEVICES.
4. BE RESPONSIBLE FOR SITE SECURITY AND JOB SAFETY, PERFORM CONSTRUCTION ACTIVITIES IN ACCORDANCE WITH OSHA STANDARDS AND LOCAL REQUIREMENTS.
5. DISPOSE OF DEMOLITION DEBRIS IN ACCORDANCE WITH APPLICABLE FEDERAL, STATE AND LOCAL REGULATIONS, ORDINANCES AND LOCAL REQUIREMENTS.

EROSION AND SEDIMENT CONTROL:

- 1. THE CONTRACTOR SHALL INSTALL SPECIFIED EROSION AND CONTROL DEVICES BEFORE BEGINNING OTHER WORK ON SITE AND MAINTAIN THEM FOR THE DURATION OF THE PROJECT.
2. CONSTRUCT ALL EROSION AND SEDIMENT CONTROL MEASURES, INCLUDING INLET PROTECTION FOR EXISTING AND PROPOSED CATCH BASINS, IN ACCORDANCE WITH THE STANDARDS AND SPECIFICATIONS OF THE MOST RECENT EDITION OF THE "CONNECTICUT GUIDELINES FOR SOIL EROSION AND SEDIMENT CONTROL" (CT DEEP BULLETIN 34). ALL MEASURES SHALL BE MAINTAINED AND UPGRADED TO ACHIEVE PROPER SEDIMENT CONTROL DURING CONSTRUCTION.
3. REFER TO THE DRAWINGS FOR EROSION AND SEDIMENT CONTROL LOCATIONS AND DETAILS.
4. IMPLEMENT ALL NECESSARY MEASURES REQUIRED TO CONTROL STORMWATER RUNOFF, DUST, SEDIMENT, AND DEBRIS FROM EXITING THE SITE. PERFORM CORRECTIVE ACTION AS NEEDED FOR EROSION CLEAN-UP AND REPAIRS TO OFF SITE AREAS, IF ANY, AT NO COST TO OWNER.
5. EXISTING DRAINAGE STRUCTURES AND PIPES ARE TO BE CLEANED AND FLUSHED WHERE INDICATED ON THE PLANS AND SHALL BE PAID FOR BY

"CLEAN EXISTING DRAINAGE SYSTEM".

- 6. INSPECT AND MAINTAIN EROSION CONTROL MEASURES WEEKLY AND AFTER MAJOR RAINFALL EVENTS, DISPOSE OF SEDIMENT IN AN UPLAND AREA. DO NOT ENCUMBER OTHER DRAINAGE STRUCTURES AND PROTECTED AREAS.
7. UPON COMPLETION OF CONSTRUCTION AND ESTABLISHMENT OF PERMANENT GROUND COVER, REMOVE AND DISPOSE OF TEMPORARY EROSION CONTROL MEASURES. CLEAN SEDIMENT AND DEBRIS FROM TEMPORARY MEASURES AND FROM PERMANENT STORM DRAIN AND SANITARY SEWER SYSTEMS.

UTILITIES:

- 1. THE CONTRACTOR SHALL NOTIFY "CALL BEFORE YOU DIG" AT 1-800-922-4455 AND THE TOWN AT LEAST 72 SATURDAYS, SUNDAYS, AND HOLIDAYS EXCLUDED, PRIOR TO EXCAVATING AT ANY LOCATION. A COPY OF THE CBYD PROJECT REFERENCE NUMBER(S) SHALL BE PROVIDED WHEN COMPLETING THE HIGHWAY PERMIT APPLICATION. EXCAVATION SHALL COMMENCE ONCE A HIGHWAY PERMIT IS RECEIVED BY THE CONTRACTOR.
2. LOCATIONS OF EXISTING PIPES, CONDUITS, UTILITIES, FOUNDATIONS AND OTHER UNDERGROUND OBJECTS ARE NOT WARRANTED TO BE CORRECT AND THE CONTRACTOR SHALL HAVE NO CLAIM ON THAT ACCOUNT SHOULD THEY BE OTHER THAN SHOWN.
3. TEST PITS TO LOCATE EXISTING UTILITIES MAY BE ORDERED BY THE ENGINEER AND SHALL BE PAID FOR UNDER ITEM "TEST PIT".
4. TERMINATE EXISTING UTILITIES IN CONFORMANCE WITH LOCAL, STATE AND INDIVIDUAL UTILITY COMPANY STANDARD SPECIFICATIONS AND DETAILS. COORDINATE UTILITY SERVICE DISCONNECTS WITH UTILITY REPRESENTATIVES.
5. THE CONTRACTOR SHALL COORDINATE THE WORK AND WORK SCHEDULE WITH UTILITY COMPANIES. PROVIDE ADEQUATE NOTICE TO UTILITIES TO PREVENT DELAYS IN CONSTRUCTION.
6. THE CONTRACTOR SHALL BE RESPONSIBLE FOR RESETTING OF FRAMES, GRATES, GATES, VALVE BOXES ETC., WHICH SHALL BE DONE IN ACCORDANCE WITH INDIVIDUAL UTILITY COMPANY REQUIREMENTS.
7. RIM ELEVATIONS FOR MANHOLES, VALVE COVERS, GATE AND PULL BOXES, AND OTHER STRUCTURES SHALL BE SET OR RESET FLUSH WITH FINAL GRADES.
8. EXISTING STRUCTURES SHALL BE CORED PRIOR TO INSTALLING PIPE.

SURVEY NOTES:

- 1. THIS SURVEY AND MAP HAS BEEN PREPARED IN ACCORDANCE WITH THE REGULATIONS OF CONNECTICUT STATE AGENCIES, SECTIONS 20-300b-1 THRU 20-300b-20 AS AMENDED, AND THE "STANDARDS FOR SURVEYS AND MAPS IN THE STATE OF CONNECTICUT" ADOPTED BY THE CONNECTICUT ASSOCIATION OF LAND SURVEYORS, INC. THE TYPE OF SURVEY IS AN EXISTING CONDITIONS SURVEY, NO BOUNDARY DETERMINATION / OPINION HAS BEEN DEVELOPED. THIS SURVEY CONFORMS TO THE FOLLOWING ACCURACY CLASSES: HORIZONTAL CLASS A-2, TOPOGRAPHIC CLASS T-3, AND VERTICAL CLASS V-3.
2. PROPERTY LINES AND RIGHT OF WAY LINES DEPICTED, WERE DEVELOPED VIA GIS AND TAX MAPS AND ARE APPROXIMATE ONLY.
3. ELEVATIONS AND CONTOURS AS DEPICTED HEREON REFER TO THE NORTH AMERICAN VERTICAL DATUM OF 1988 (NAVD) AS ESTABLISHED USING GPS SURVEY METHODS IN MARCH, 2021.
4. SURVEY PERFORMED BY WESTON & SAMPSON LAND SURVEYORS, INC. IN MARCH, 2021.
5. THE UTILITIES AS DEPICTED HEREON ARE BASED UPON OBSERVED EVIDENCE AT THE TIME OF THE FIELD SURVEY. NO ATTEMPT WAS MADE TO VERIFY THE LOCATIONS AND NO MAPPING WAS OBTAINED FROM THE RESPECTIVE UTILITY COMPANIES, GOVERNMENTAL AGENCIES AND/OR OTHER SOURCES. THESE LOCATIONS MUST BE CONSIDERED APPROXIMATE IN NATURE. ADDITIONALLY, OTHER SUCH FEATURES MAY EXIST ON THE SITE, THE EXISTENCE OF WHICH ARE UNKNOWN TO WESTON & SAMPSON. THE EXISTENCE, SIZE AND LOCATION OF ALL SUCH FEATURES MUST BE DETERMINED AND VERIFIED IN THE FIELD BY THE APPROPRIATE AUTHORITIES PRIOR TO CONSTRUCTION. CALL BEFORE YOU DIG.


LEGEND

Table with columns: DESCRIPTION, EXISTING, PROPOSED, DESCRIPTION, EXISTING, PROPOSED. Includes items like SANITARY SEWER (8" PVC SAN), WATER MAIN, STORM DRAIN, ELECTRIC, TELEPHONE, etc.

ITEMS SHOWN IN THE LEGEND MAY NOT BE PRESENT IN THESE PLANS

ABBREVIATIONS

Table with columns: ABBREVIATION, DESCRIPTION, ABBREVIATION, DESCRIPTION. Includes AC ASBESTOS CEMENT PIPE, BC BITUMINOUS CONCRETE, BOTTOM OF CURB, LF LINEAR FEET, etc.

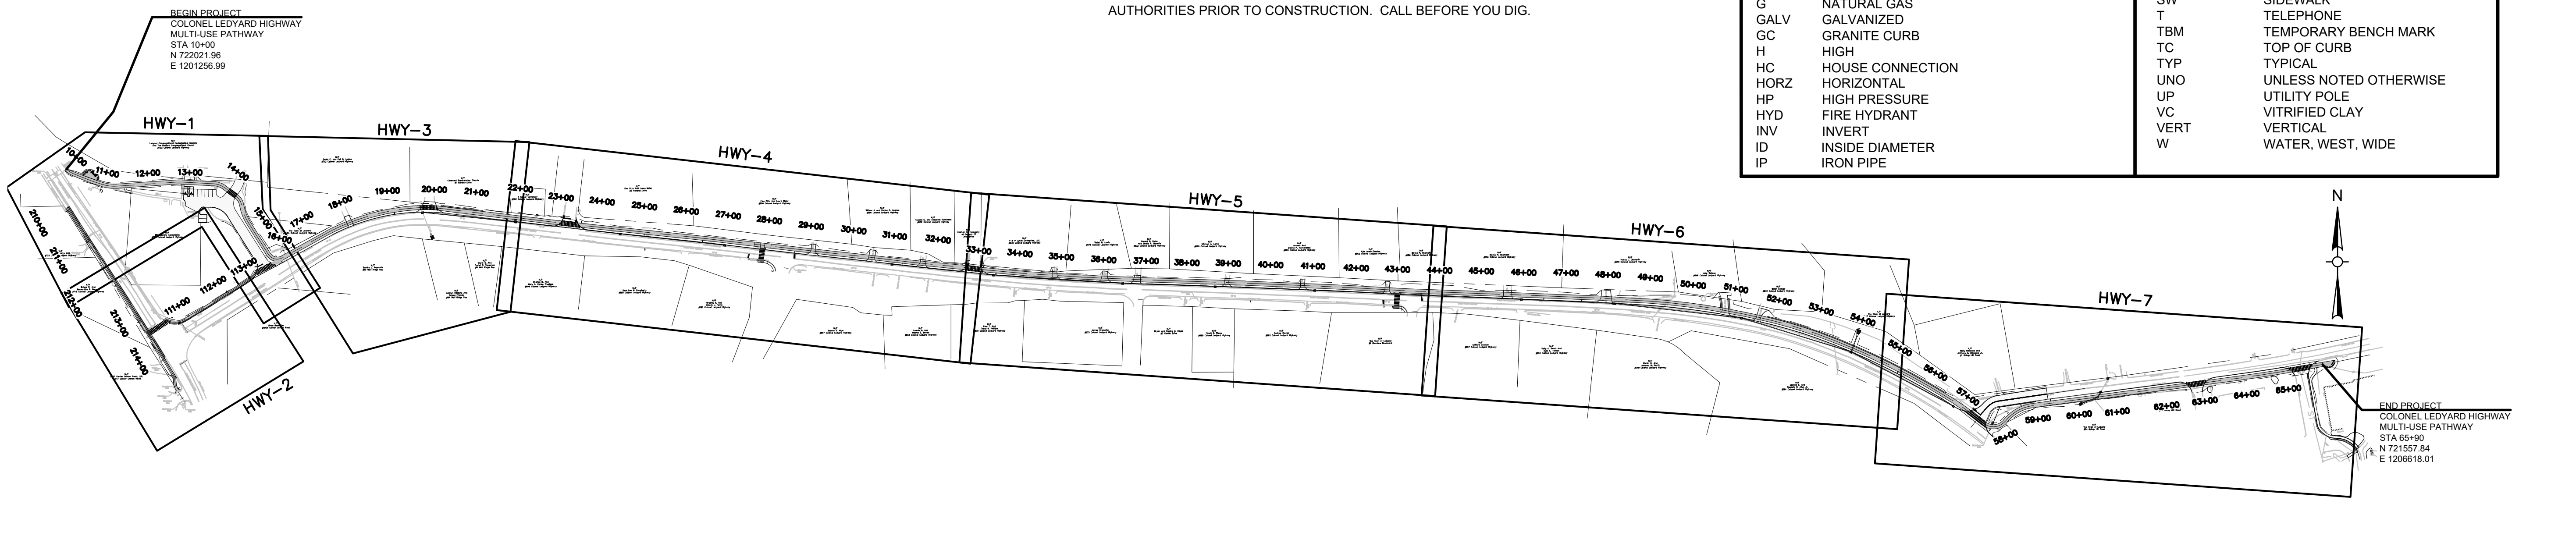

INDEX PLAN - COLONEL LEDYARD HIGHWAY MULTI-USE PATHWAY SCALE 1"=200'

Project: TOWN OF LEDYARD, CT. Ledyard High School Multi-Use Pathway & Sidewalk Extension. 741 Colonel Ledyard Highway, Ledyard, CT 06339.

Weston & Sampson. Weston & Sampson Engineers, Inc. 712 Brook Street, Suite 103, Rocky Hill, CT 06067. 978.532.1900 800.SAMPSON www.westonandsampson.com

Consultants: (Empty field)

Revisions table with columns: No., Date, Description. (Empty table)

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Reviewed By: RC
Approved By: LAS
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Drawing Title: INDEX PLAN, LEGEND, AND GENERAL NOTES

Sheet Number: GEN-01

SEDIMENTATION AND EROSION CONTROL PLAN

GENERAL
 THIS PLAN PROPOSES EROSION CONTROL MEASURES TO ADEQUATELY CONTROL ACCELERATED EROSION AND SEDIMENTATION AND REDUCE THE DANGER FROM STORM WATER RUNOFF AT THE SITE. THE RUNOFF SHALL BE CONTROLLED BY THE INTERCEPTION, DIVERSION, AND SAFE DISPOSAL OF PRECIPITATION. RUNOFF SHALL ALSO BE CONTROLLED BY STAGING CONSTRUCTION ACTIVITY AND PRESERVING NATURAL VEGETATION WHENEVER POSSIBLE.

EXISTING VEGETATION SHALL BE PROTECTED AND ONLY THAT CLEARING AND GRUBBING ABSOLUTELY NECESSARY FOR THE PROPOSED CONSTRUCTION SHALL BE PERFORMED. ALL DISTURBED AREAS SHALL BE RESTORED TO THEIR ORIGINAL CONDITION AND CONTOUR, UNLESS OTHERWISE INDICATED ON THE PLANS. THE CONTRACTOR SHALL TAKE SPECIAL CARE WITH HIS CONSTRUCTION METHODS AND SHALL COMPLY WITH THE FOLLOWING GUIDELINES.

REFERENCE IS MADE TO THE "CONNECTICUT GUIDELINES FOR SOIL EROSION AND SEDIMENT CONTROL" (2002), AS AMENDED. THE GUIDELINES ARE OBTAINABLE ONLINE FROM THE CONNECTICUT DEPARTMENT OF ENVIRONMENTAL PROTECTION AT WWW.CT.GOV/DEEP AND SHOULD BE USED AS A REFERENCE IN CONSTRUCTING THE EROSION AND SEDIMENT CONTROLS INDICATED ON THESE PLANS.

SEDIMENTATION CONTROL

ALL AREAS SHALL BE PROTECTED FROM SEDIMENTATION DURING AND AFTER CONSTRUCTION, PARTICULARLY THE STORAGE OF EXCAVATED OR STOCKPILED MATERIAL. THE CONTRACTOR SHALL CAREFULLY STRIP ALL TOPSOIL, LOAM, OR ORGANIC MATTER PRIOR TO TRENCHING OR OTHER OPERATIONS AND SHALL STORE THEM SEPARATELY FROM ALL OTHER MATERIALS DURING EXCAVATION. EACH STOCKPILE MUST BE ADEQUATELY RINGED WITH SEDIMENT CONTROL MATERIAL (I.E. SILT FENCE).

STABILIZING OF SLOPES SHALL BE DONE IMMEDIATELY AFTER CONSTRUCTION OF SLOPES. SLOPES THAT ARE 2:1 OR STEEPER SHALL BE PROTECTED WITH EROSION CONTROL MATTING TYPE H. ALL OTHER AREAS SHALL BE MULCHED WITH HAY OR STRAW AS REQUIRED.

EROSION AND SEDIMENTATION CONTROL PLAN

SEDIMENTATION CONTROL SYSTEM – THE SEDIMENTATION CONTROL SYSTEM SHALL CONSIST OF SILT FENCE.

GEOTEXTILE BARRIER FENCE – THE SEDIMENTATION CONTROL SYSTEM SHALL BE INSTALLED IMMEDIATELY AFTER A CUT SLOPE HAS BEEN GRADED, BEFORE A FILL SLOPE HAS BEEN CREATED AND AS INDICATED ON THE PLANS. THE SYSTEM IS DESIGNED TO INTERCEPT SILT AND SEDIMENT BEFORE IT REACHES THE WETLAND AREAS, OR WATERCOURSES. DEPOSITS OF SEDIMENT AND SILT ARE TO BE PERIODICALLY REMOVED FROM THE UPSTREAM SIDE OF THE FENCE. THIS MATERIAL IS TO BE SPREAD AND STABILIZED IN AREAS NOT SUBJECT TO EROSION, OR IN AREAS WHICH ARE NOT TO BE PAVED OR BUILT ON. THE SEDIMENTATION CONTROL SYSTEM IS TO BE REPLACED AS NECESSARY TO PROVIDE PROPER FILTERING ACTION. THE SYSTEM IS TO REMAIN IN PLACE AND BE MAINTAINED TO INSURE EFFICIENT SILTATION CONTROL UNTIL ALL AREAS ABOVE THE FENCE ARE STABILIZED AND VEGETATION HAS BEEN ESTABLISHED.

RIPRAP – RIPRAP, IF REQUIRED OR SPECIFIED, IS TO BE INSTALLED AS ENERGY DISSIPATION STRUCTURES. THE RIPRAP IS TO BE INSTALLED BEFORE OUTLET STRUCTURES ARE ACTIVATED, AND ALL ADJACENT AREAS ARE TO BE IMMEDIATELY SEEDED IF IN SEASON OTHERWISE THE SOIL IS TO BE STABILIZED BY OTHER METHODS.

IN ALL AREAS, REMOVAL OF TREES, BUSHES AND OTHER VEGETATION, AND DISTURBANCE OF THE SOIL, IS TO BE KEPT TO AN ABSOLUTE MINIMUM WHILE ALLOWING PROPER DEVELOPMENT OF THE SITE.

DURING CONSTRUCTION, AS SMALL AN AREA OF SOIL AS POSSIBLE SHOULD BE EXPOSED FOR AS SHORT A TIME AS POSSIBLE. AFTER CONSTRUCTION, GRADE, RESPREAD TOPSOIL, AND STABILIZE SOIL BY SEEDING AND MULCHING SO AS TO PREVENT EROSION.

SEDIMENTATION AND EROSION CONTROL MAINTENANCE PROCEDURES

ALL SEDIMENTATION AND EROSION CONTROL DEVICES SHALL BE INSPECTED DURING CONSTRUCTION ON A WEEKLY BASIS, AND FOLLOWING ALL STORMS, BY THE RESIDENT ENGINEER. THE CONTRACTOR SHALL MAINTAIN AND MAKE REPAIRS AND REMOVE SEDIMENT AS REQUESTED BY THE RESIDENT ENGINEER. THIS WORK SHALL BE PERFORMED WITHIN 24 HOURS OF THE REQUEST AND THERE SHALL BE NO SEPARATE PAYMENT FOR THIS WORK.

THE CONTRACTOR SHALL PROVIDE ROUTINE SWEEPING OF ALL PAVED SURFACES SUBJECT TO SEDIMENT ACCUMULATION DURING CONSTRUCTION ACTIVITIES.

THE CONTRACTOR SHALL CLEAN SEDIMENT AND DEBRIS FROM ALL DRAINAGE STRUCTURES, AND PIPES AT THE COMPLETION OF CONSTRUCTION, AND AS REQUESTED BY THE RESIDENT ENGINEER TO KEEP THE SYSTEM FUNCTIONING PROPERLY DURING CONSTRUCTION.

FOLLOWING COMPLETION OF CONSTRUCTION, THE CONTRACTOR SHALL REPAIR ALL ERODED AREAS AND ENSURE A GOOD STAND OF TURF IS ESTABLISHED THROUGHOUT. THE CONTRACTOR SHALL REPAIR ALL ERODED OR DISPLACED RIPRAP, AND CLEAN SEDIMENT COVERED STONES.

TYPICAL CONSTRUCTION SEQUENCE


PRIOR TO COMMENCEMENT OF WORK, EROSION AND SEDIMENT CONTROL STRUCTURES SHALL BE INSTALLED. A TYPICAL SEQUENCE OF CONSTRUCTION IS:

1. OBTAIN APPROPRIATE PERMITS, NOTIFY TOWN OFFICIALS OF CONSTRUCTION COMMENCEMENT, AND SUBMIT CONSTRUCTION TIMETABLE.
2. ON-SITE CONSTRUCTION SEQUENCE SHALL START WITH THE MINIMUM AMOUNT OF CLEARING REQUIRED TO INSTALL EROSION CONTROL MEASURES AS SHOWN ON PLAN. THIS INCLUDES SILTATION FENCING, SILT CURTAIN, AND OTHER MEASURES NOTED ON THE PLAN. NO WORK SHALL TAKE PLACE UNTIL THE ENGINEER AND WETLAND ENFORCEMENT OFFICER HAVE INSPECTED AND APPROVED INSTALLED MEASURES.

DURING CONSTRUCTION ALL EROSION AND SEDIMENT STRUCTURES SHALL BE MAINTAINED IN PROPER WORKING ORDER. DISTURBED AREAS SHALL BE KEPT TO A MINIMUM AND SHALL ONLY TAKE PLACE WHERE IMMEDIATELY REQUIRED TO FURTHER CONSTRUCTION. IT IS DESIRABLE FROM AN EROSION PREVENTION CONCERN TO MINIMIZE DISTURBED AREAS. FINAL GRADING AND SEEDING SHALL TAKE PLACE AS SOON AS PRACTICAL.

A RAIN GAUGE SHALL BE PLACED AT THE PROJECT SITE IN A WORKABLE LOCATION AND MONITORED DURING RAINFALL PERIODS UNTIL ALL DISTURBED AREAS ARE STABILIZED. IN THE EVENT THERE IS A RAINFALL GREATER THAN 1/2" IN A 12 HOUR PERIOD, ALL EROSION CONTROL MEASURES SHALL BE CHECKED AND REPAIRED AS REQUIRED. IF NO RAIN GAUGE IS USED, ALL EROSION CONTROL MEASURES SHALL BE CHECKED AFTER ALL RAINFALL EVENTS.


A CHECK LIST PROVIDED BY THE ENGINEER SHALL BE FILLED OUT EVERY WEEK OR AFTER EACH RAINFALL EVENT OF 1/2" OR GREATER.

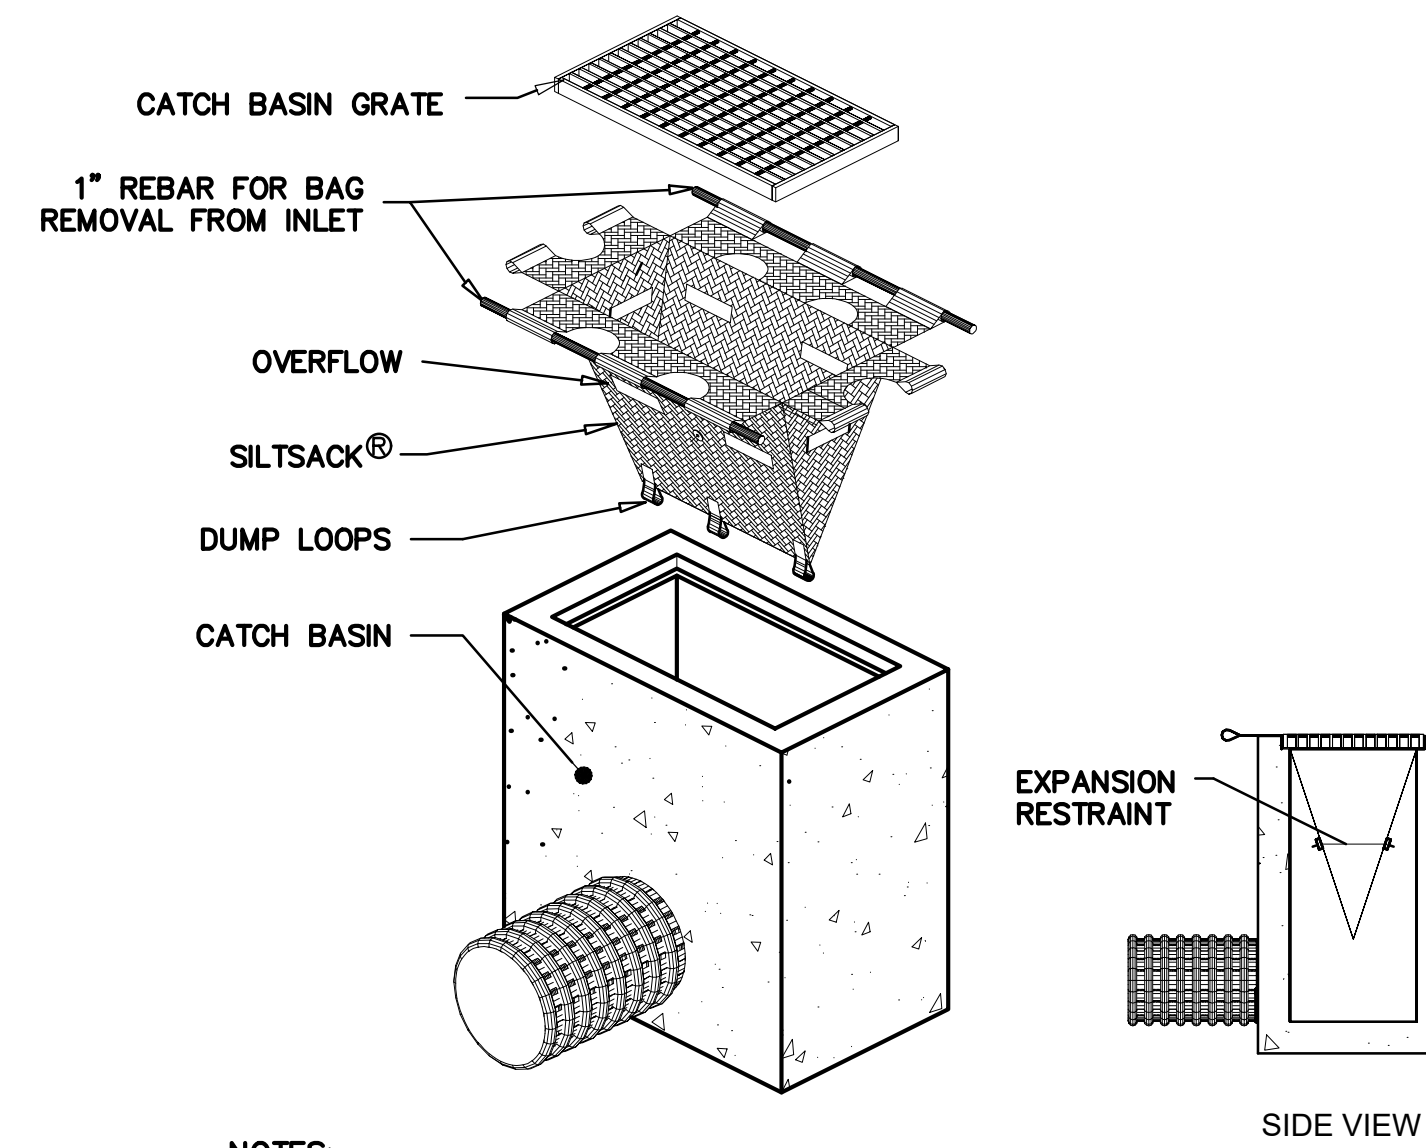

- NOTES:**
 1. PROVIDE HI-FLOW SILT SACK TYPE A FOR TYPE "C-L" CATCH BASIN TOPS AND TYPE B WITH CURB DEFLECTOR FOR TYPE "C" CATCH BASIN TOPS OR OTHER STRUCTURES WITH CURB INLET.

CATCH BASIN INLET PROTECTION


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SEDIMENTATION AND EROSION CONTROL DETAIL

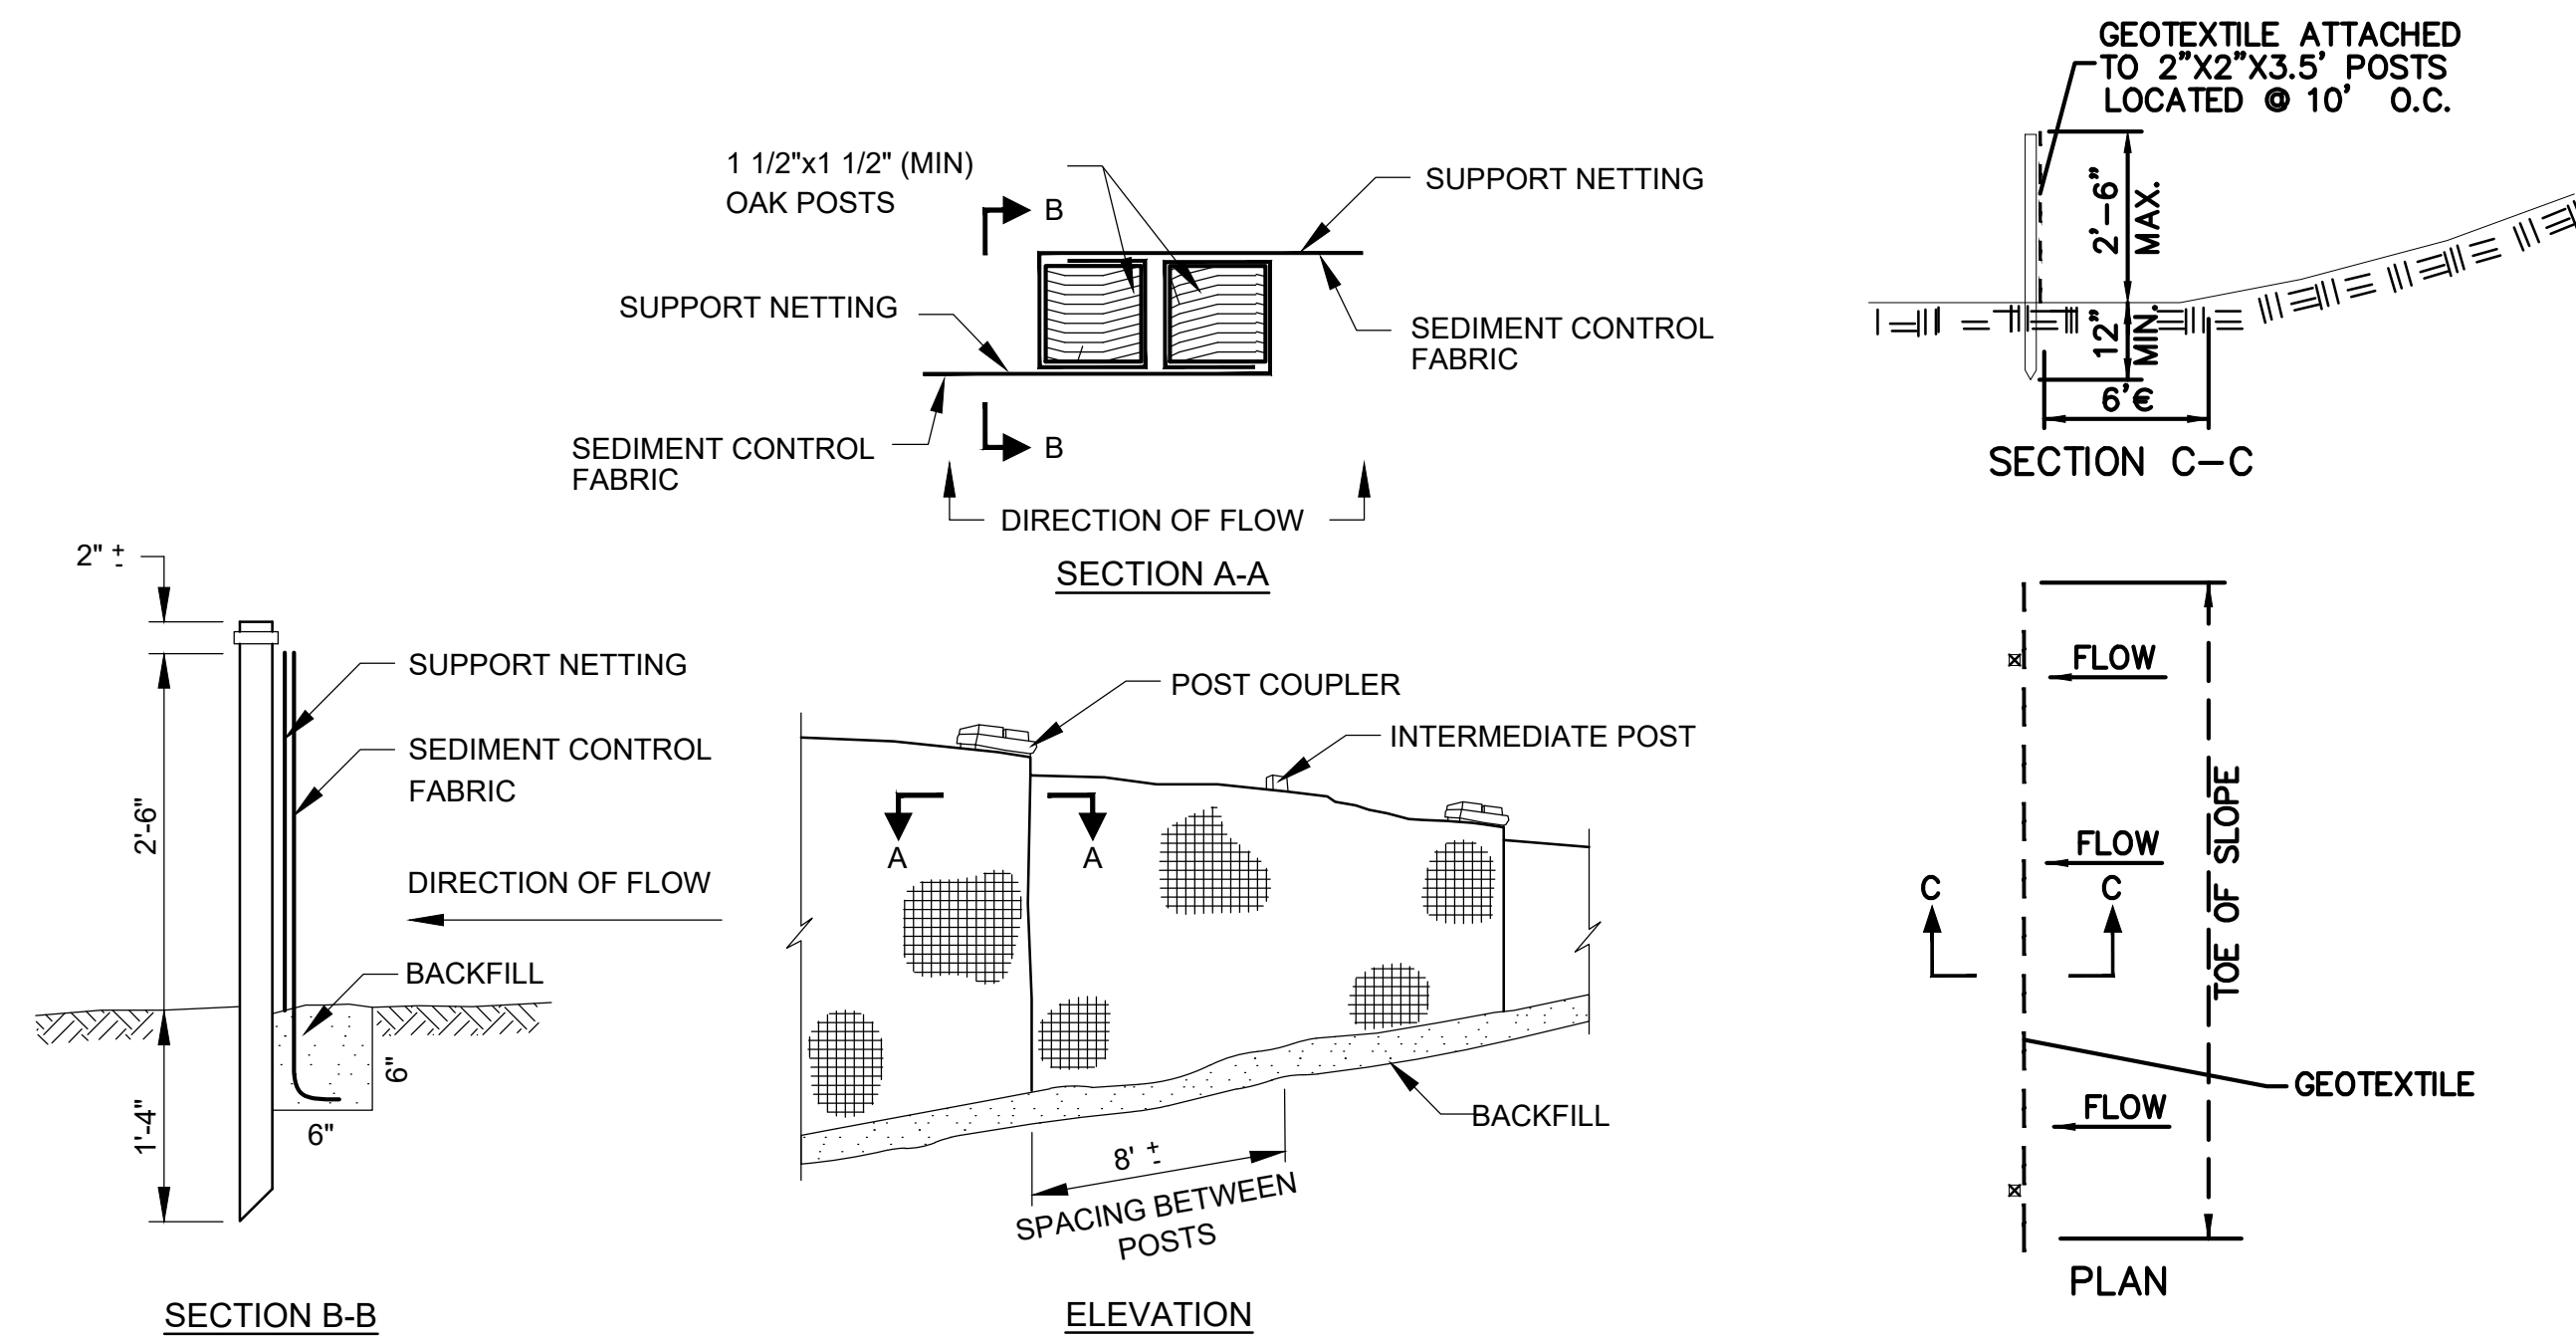(SILT FENCE)

N.T.S.



EXISTING TREE PROTECTION

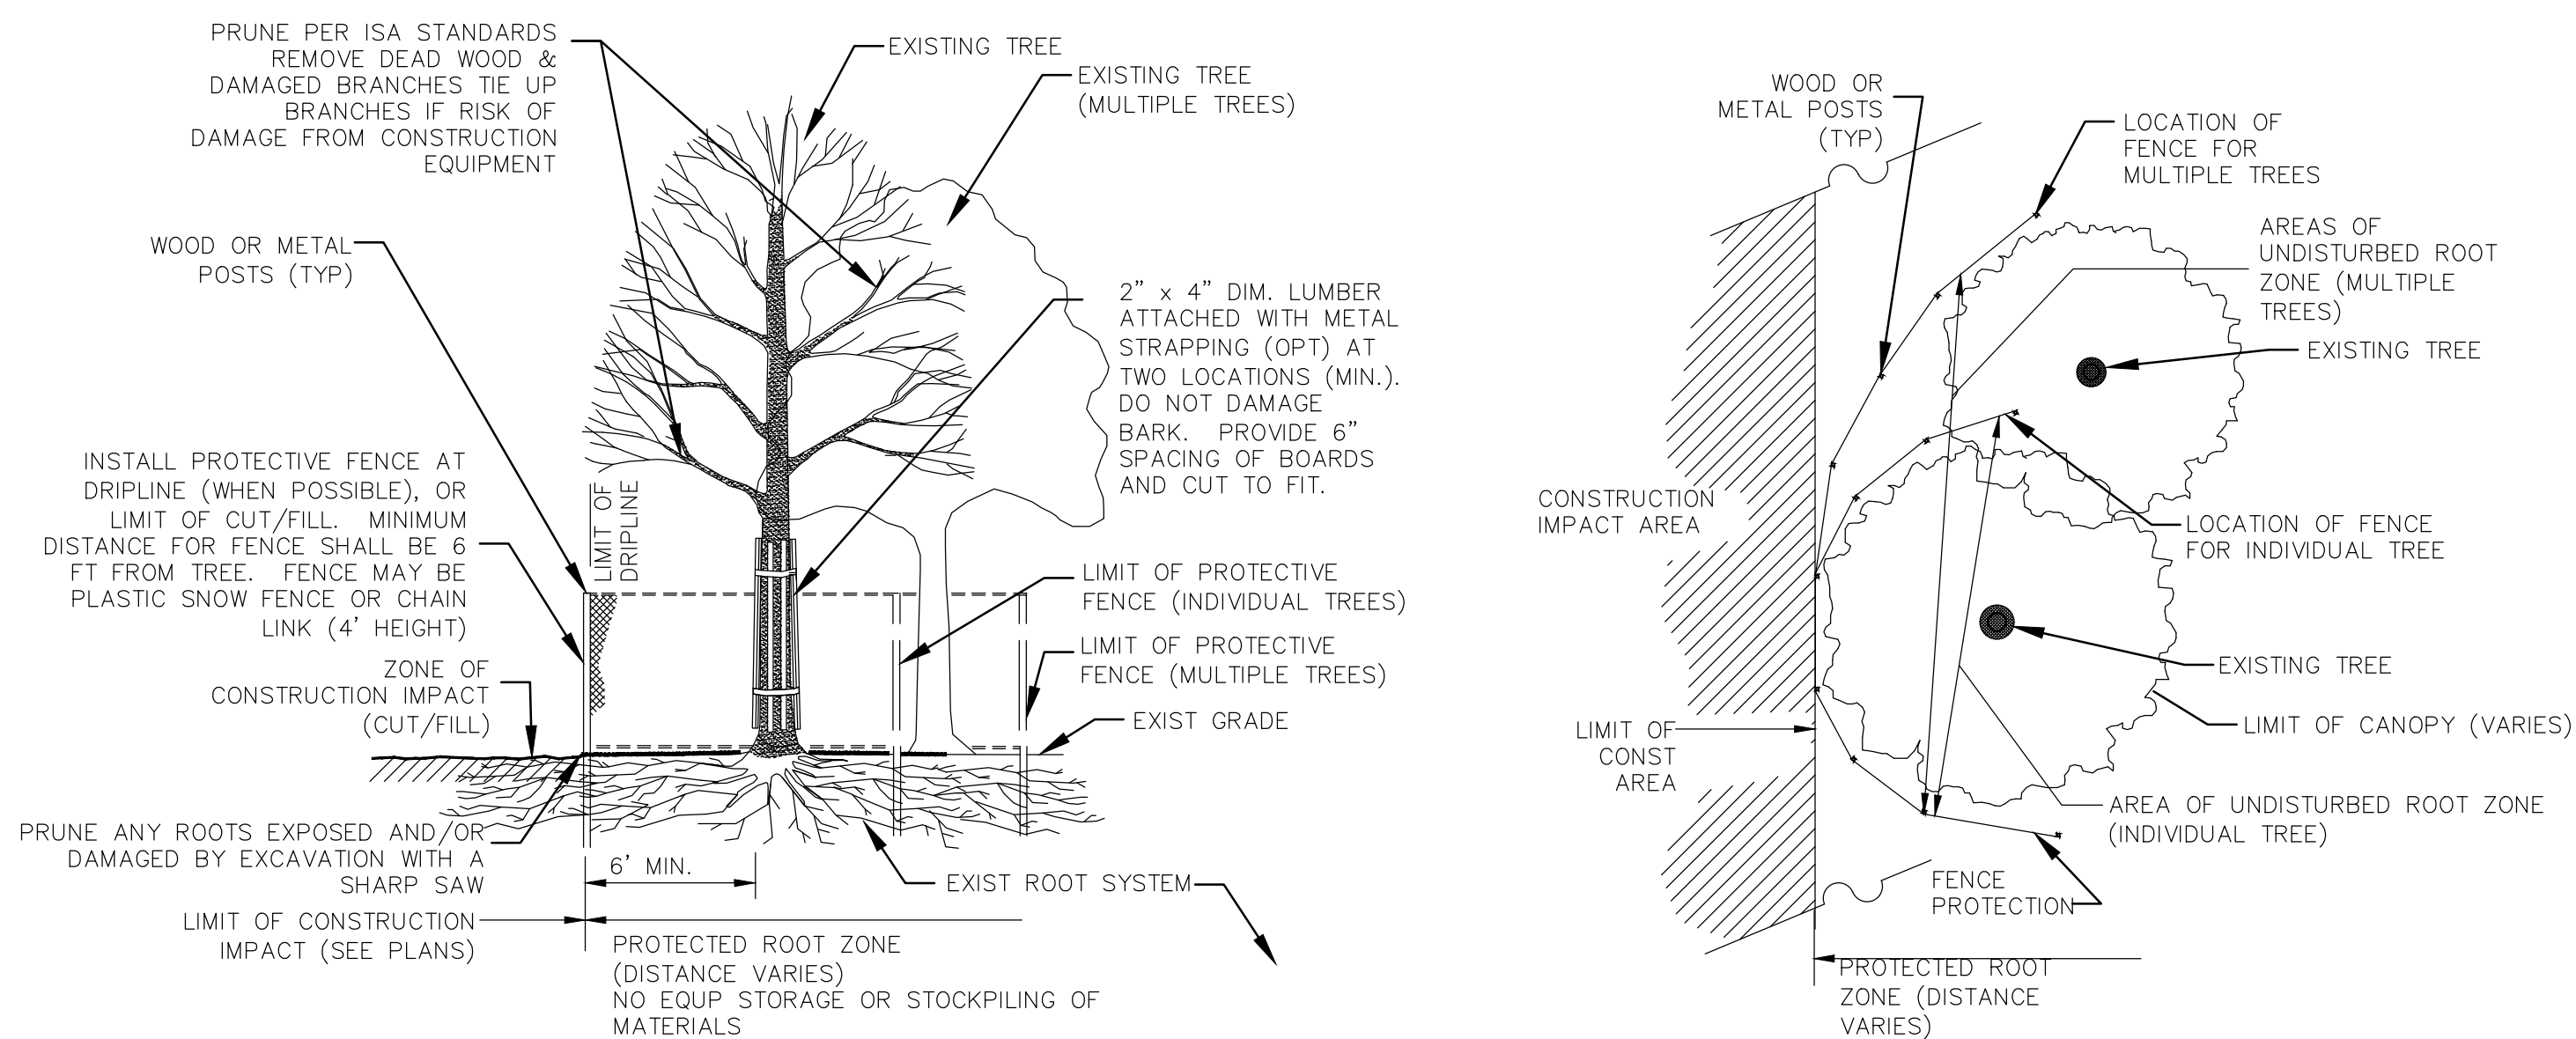N.T.S.

Project: TOWN OF LEDYARD, CT



LEDYARD HIGH SCHOOL
 MULTI-USE PATHWAY &
 SIDEWALK EXTENSION
 741 COLONEL LEDYARD HIGHWAY
 LEDYARD, CT 06339

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Consultants:

Revisions:

No.	Date	Description

Seal:

CON:
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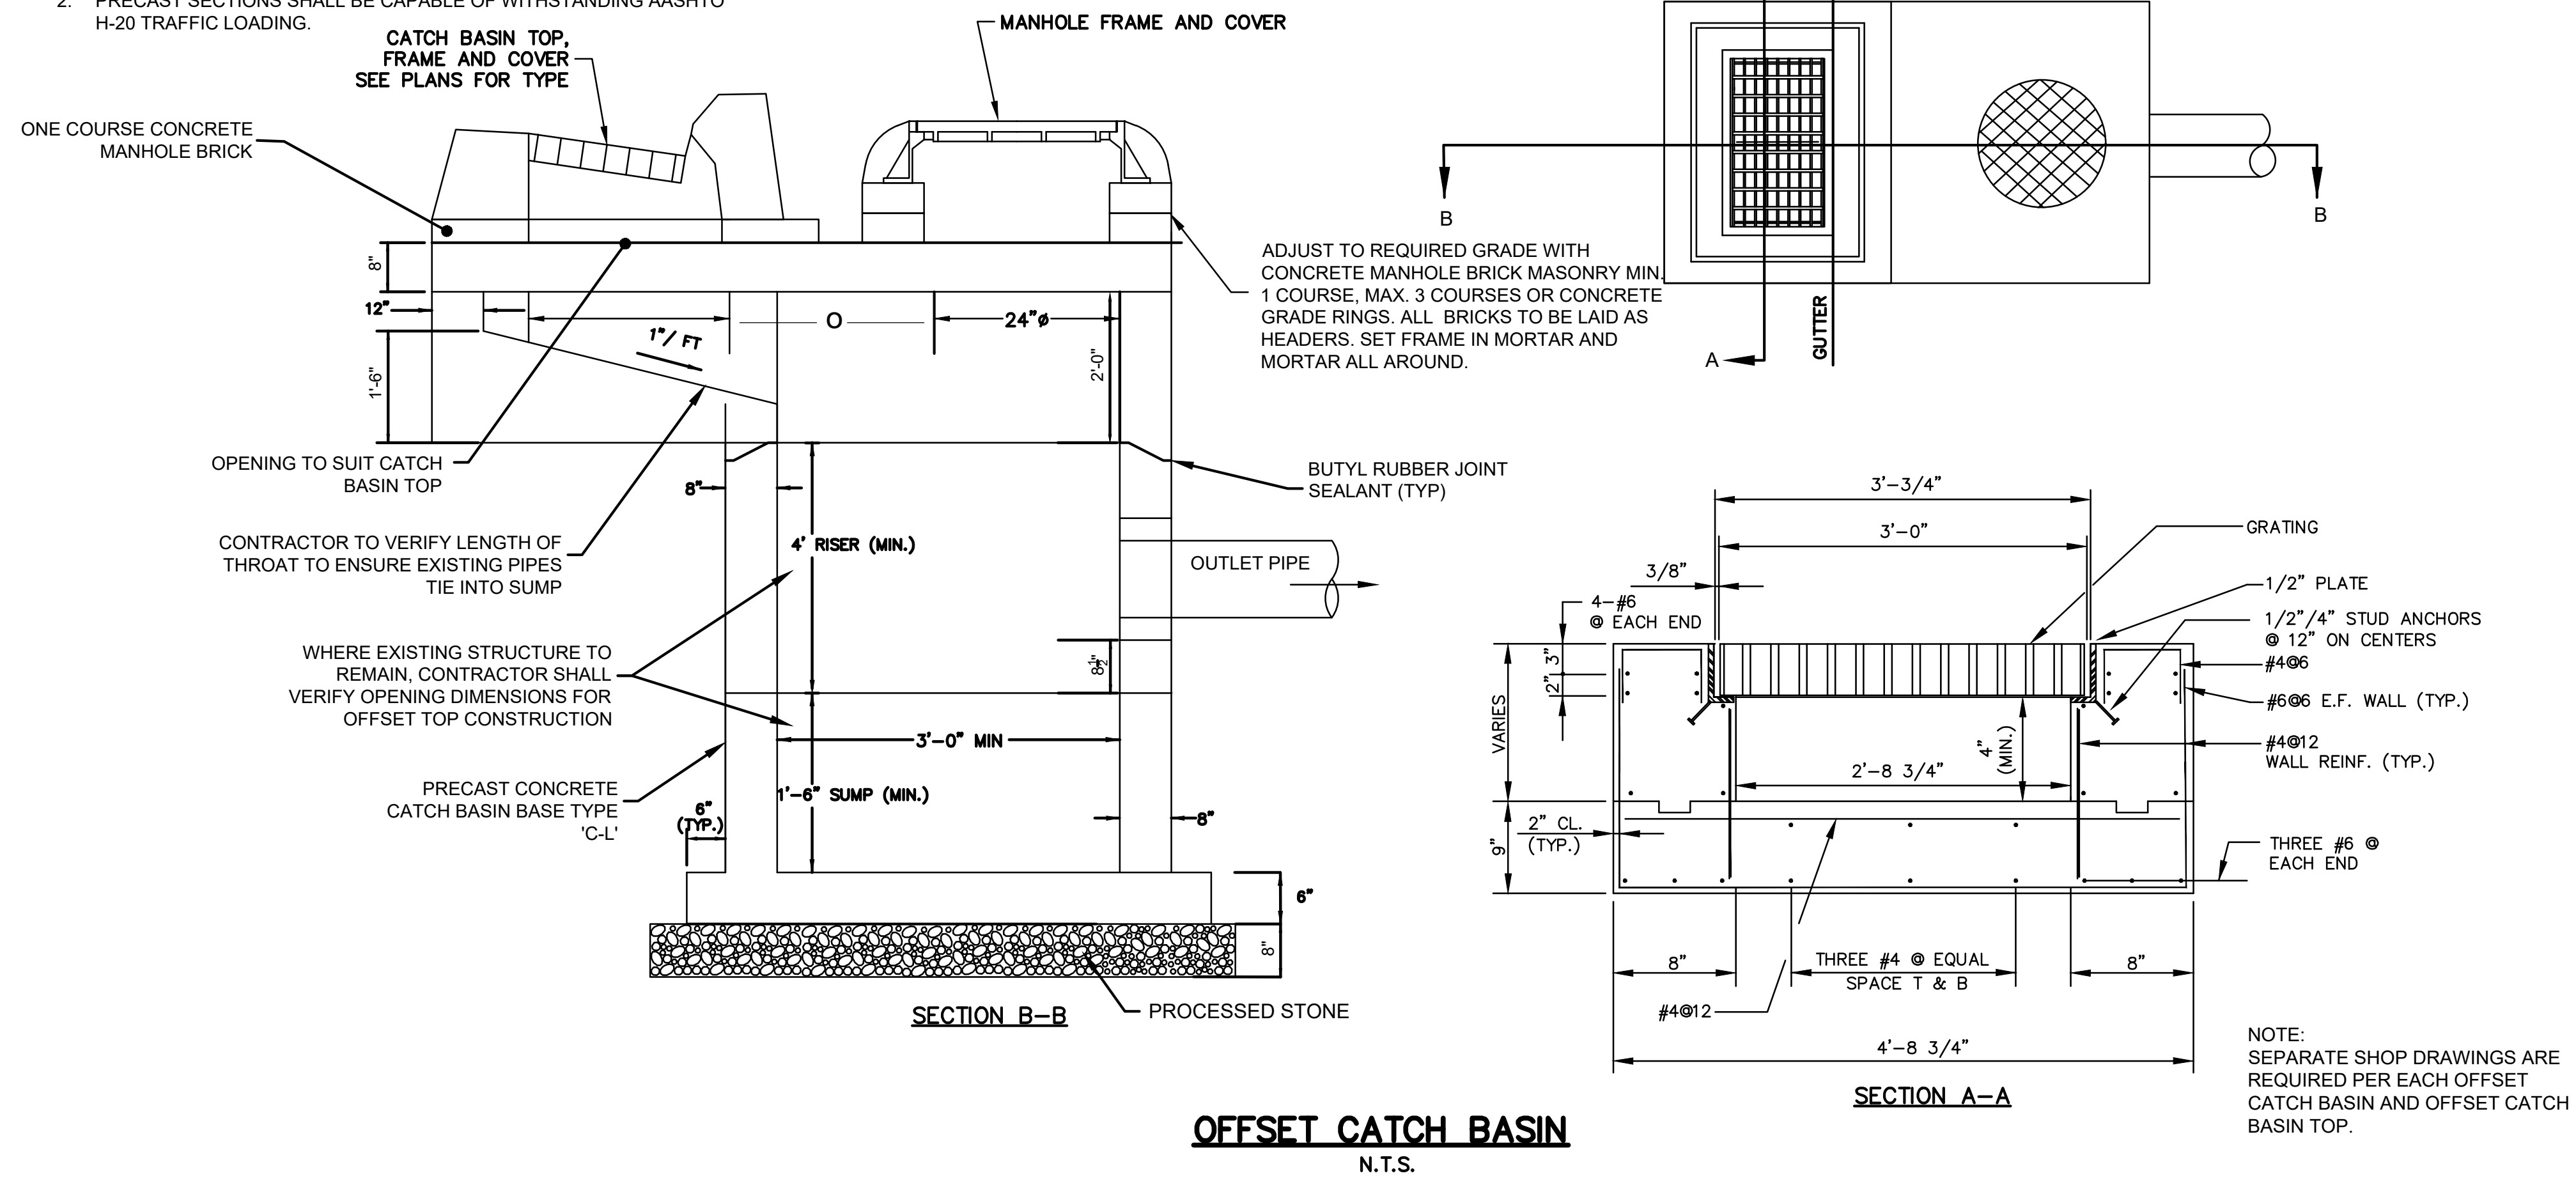
Drawing Title:

SEDIMENTATION AND EROSION CONTROL DETAILS


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DET-01


- NOTES
- SET TOP SLAB TO MEET EXIST. SLOPE OF CURB LINE AND CROSS SLOPE OF SIDEWALK. ADJUST DIMENSIONS OF CAST-IN-PLACE SECTION.
 - PRECAST SECTIONS SHALL BE CAPABLE OF WITHSTANDING AASHTO H-20 TRAFFIC LOADING.



OFFSET CATCH BASIN
N.T.S.

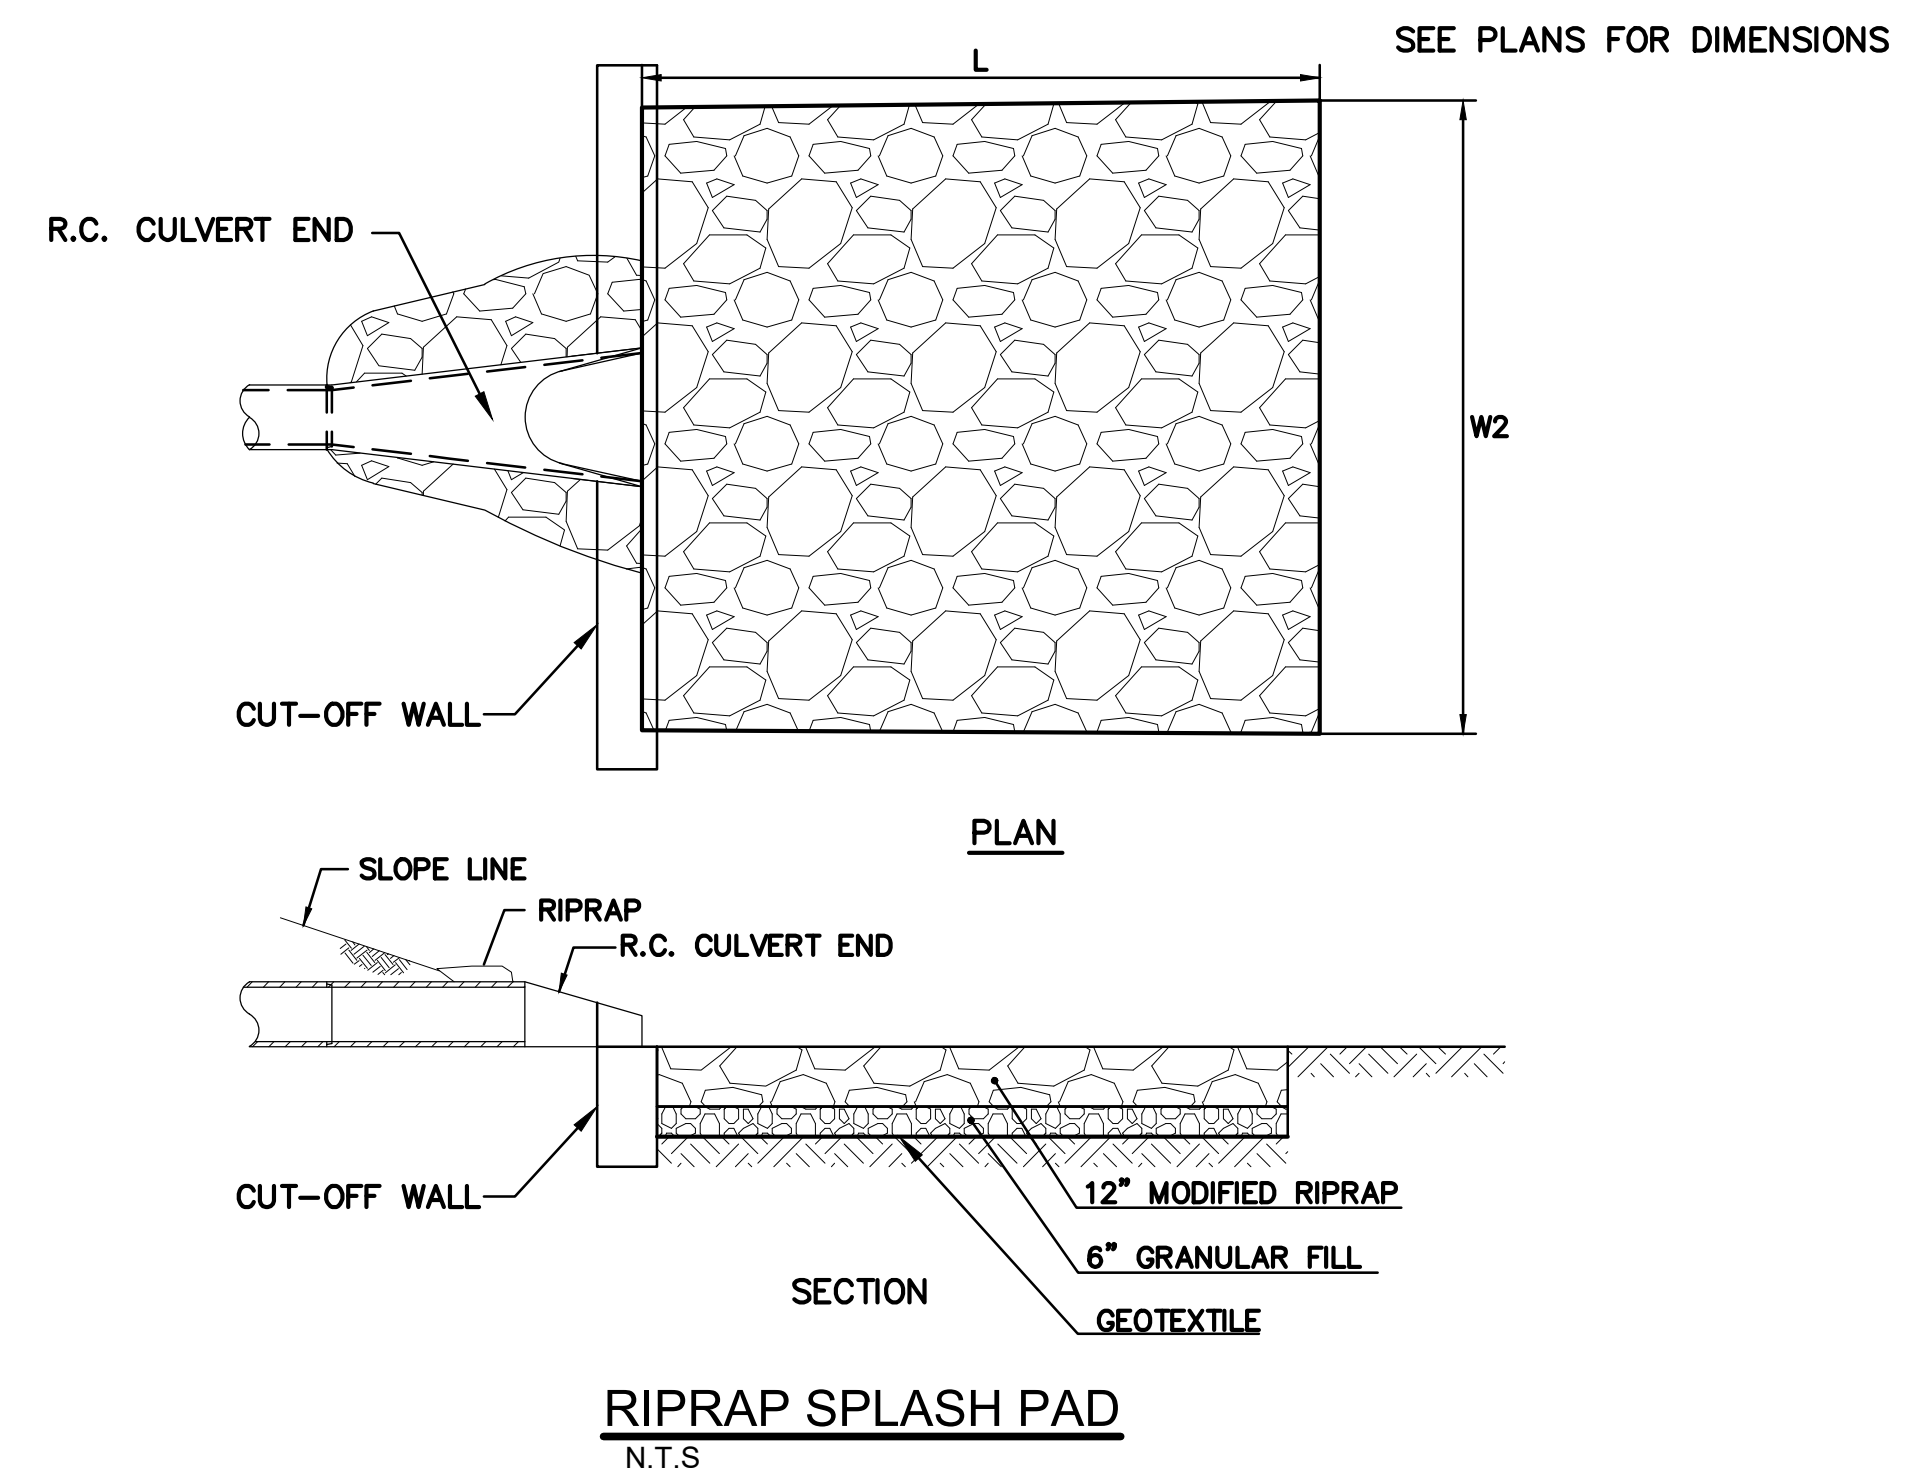

RIPRAP SPLASH PAD
N.T.S.

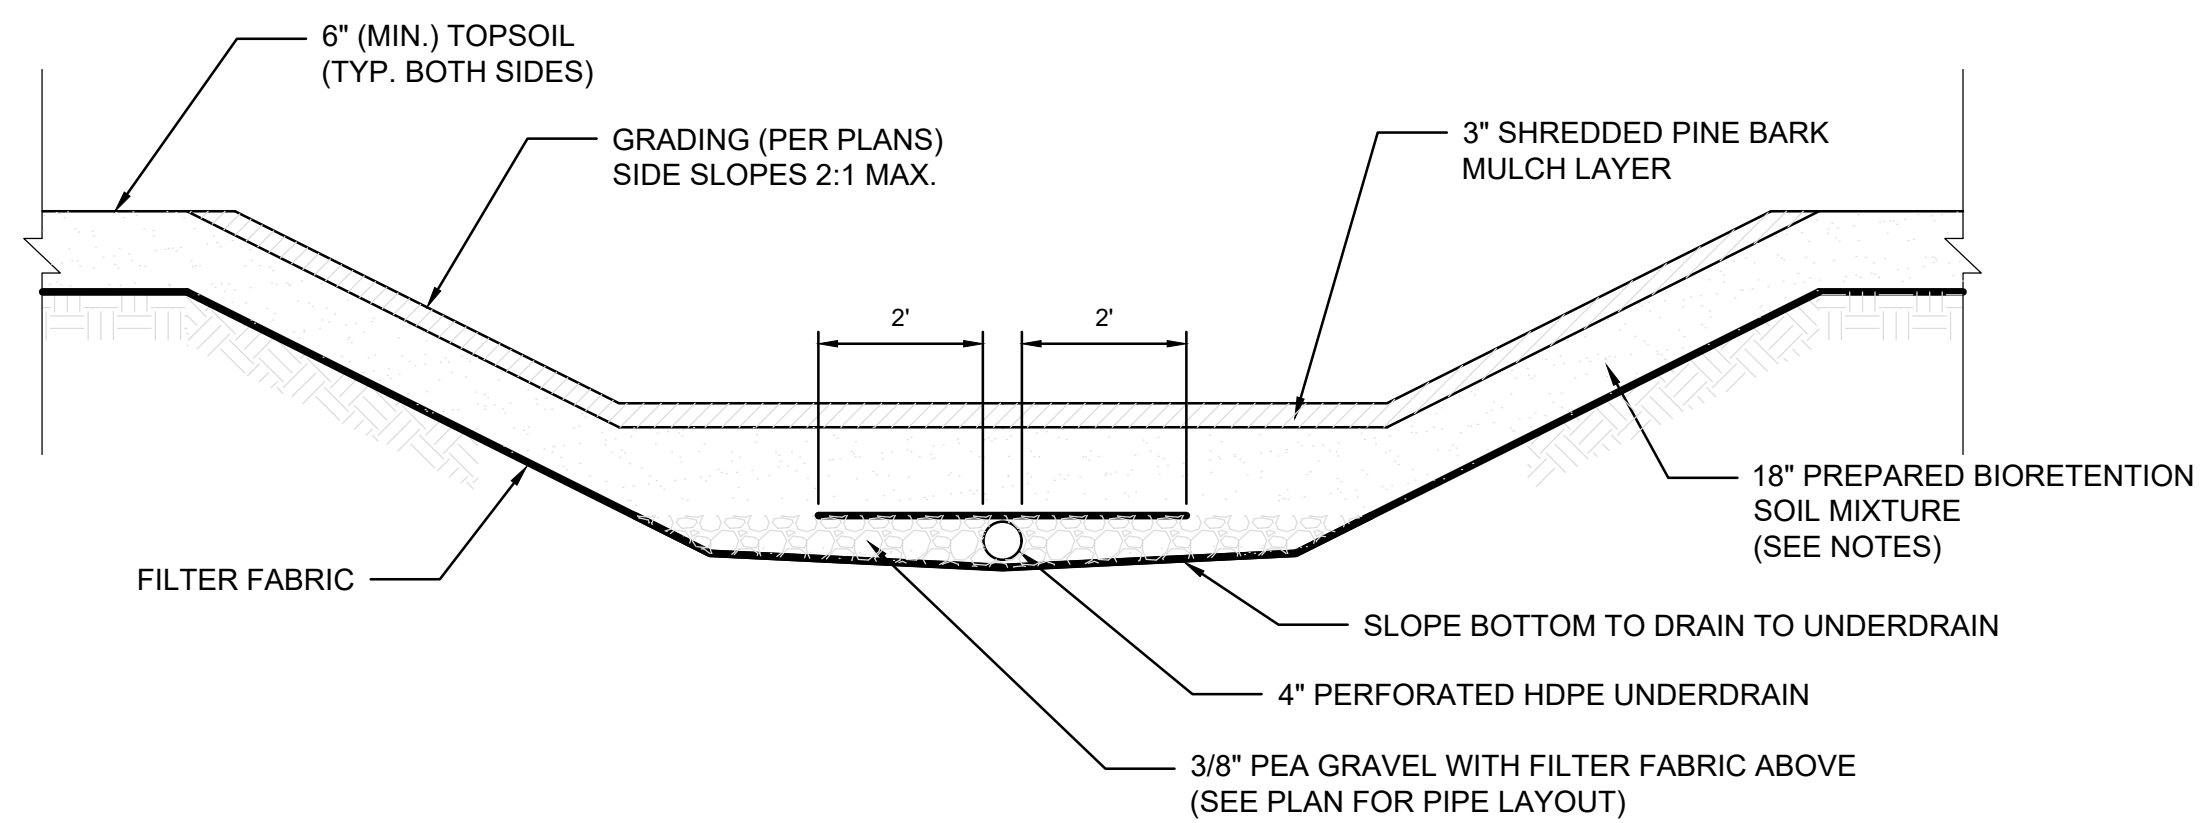

BIORETENTION SOIL MIXTURE SHALL BE A MIXTURE OF SAND COMPOST AND SOIL

50% SAND
30% TOPSOIL, AND
20% COMPOST.


THE SOIL MIX MUST BE UNIFORM, FREE OF STONES, STUMPS, ROOTS, OR SIMILAR OBJECTS LARGER THAN 2 INCHES. CLAY CONTENT SHOULD NOT EXCEED 5%. SOIL PH SHOULD GENERALLY BE BETWEEN 5.5-6.5, A RANGE THAT IS OPTIMAL FOR MICROBIAL ACTIVITY AND ADSORPTION OF NITROGEN, PHOSPHORUS, AND OTHER POLLUTANTS. USE SOILS WITH 1.5% TO 3% ORGANIC CONTENT AND MAXIMUM 500-PPM SOLUBLE SALTS.

THE SAND COMPONENT SHOULD BE GRAVELLY SAND THAT MEETS ASTM D 422.


SIEVE SIZE	PERCENT PASSING
2-INCH	100
3/4-INCH	70-100
1/2-INCH	50-80
U.S. NO. 40	15-40
U.S. NO. 20	0-3

THE TOPSOIL COMPONENT SHALL BE A SANDY LOAM, LOAMY SAND OR LOAM MIXTURE.

BIO-RETENTION DETAIL
N.T.S.

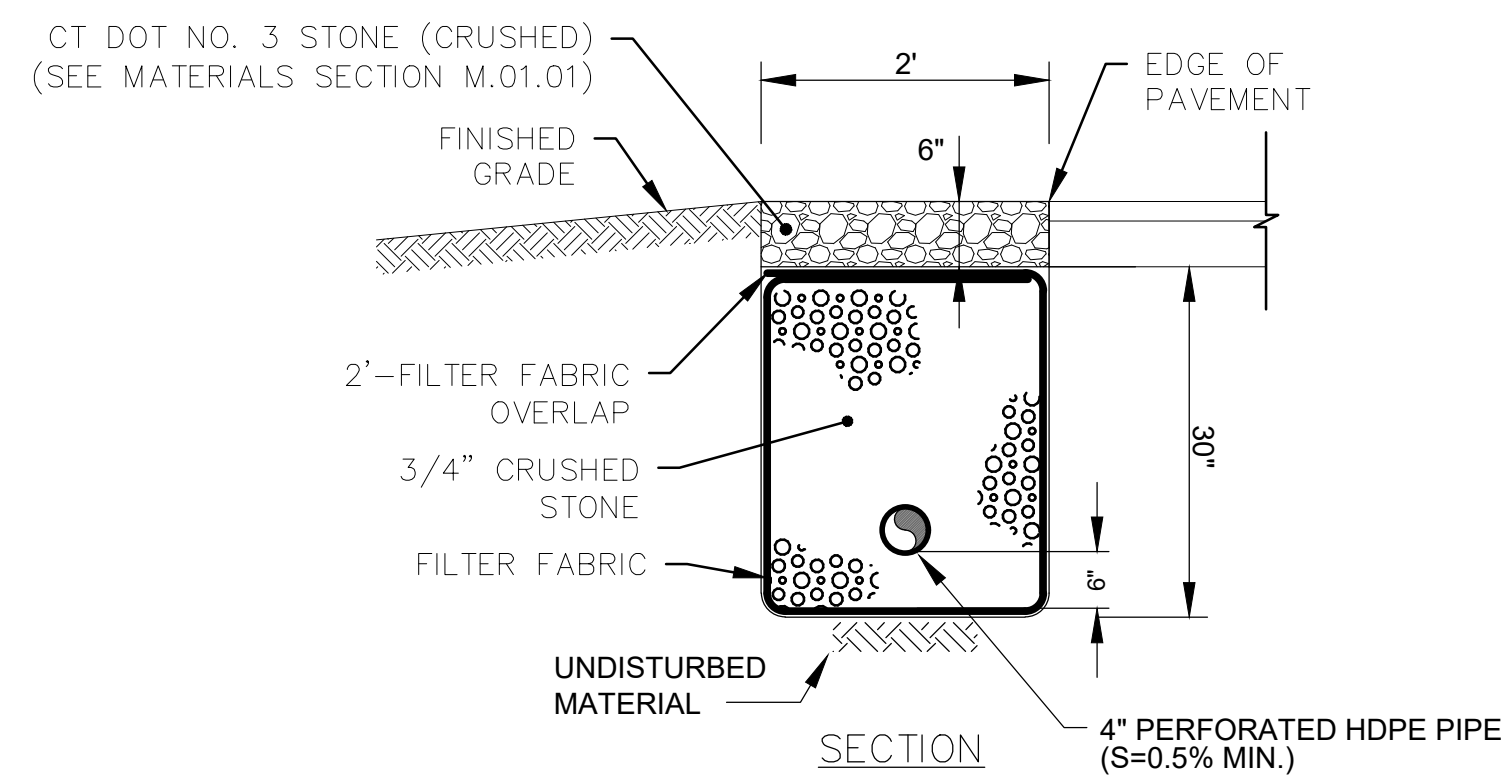

STONE TRENCH (PRE-TREATMENT)
NOT TO SCALE

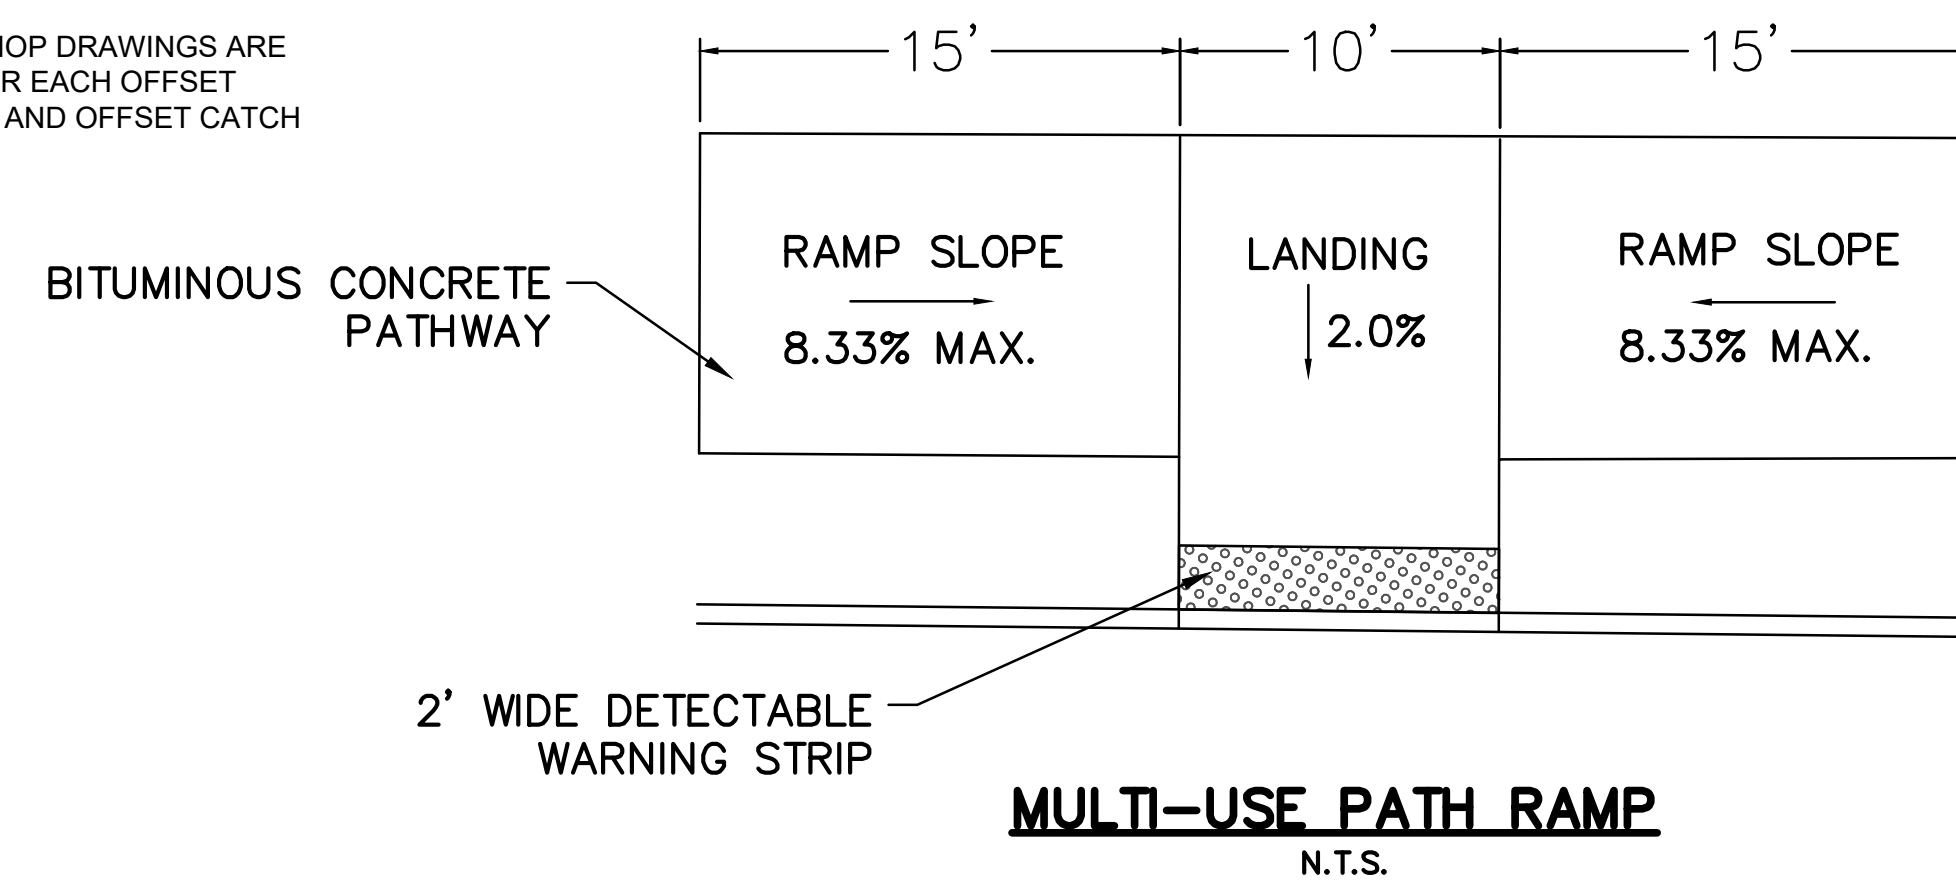

MULTI-USE PATH RAMP
N.T.S.

Project:
TOWN OF LEDYARD, CT

LEDYARD HIGH SCHOOL
MULTI-USE PATHWAY &
SIDEWALK EXTENSION
741 COLONEL LEDYARD HIGHWAY
LEDYARD, CT 06339

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Approved By: LAS
W&S Project No.: ENG20-1119
W&S File No.:

Drawing Title:
**MISCELLANEOUS
DETAILS**

Sheet Number:
DET-02

I:\projects\2020\1119 LEDYARD CT\1119 LEDYARD CT\1119 LEDYARD CT\1119 LEDYARD CT\1119 LEDYARD CT\DET-02.dwg

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Drawing Title:
**HYDRODYNAMIC
SEPARATOR
DETAILS**

Sheet Number:
DET-03

CASCADE SEPARATOR DESIGN NOTES


THE STANDARD CS-3 CONFIGURATION IS SHOWN. ALTERNATE CONFIGURATIONS ARE AVAILABLE AND ARE LISTED BELOW. SOME CONFIGURATIONS MAY BE COMBINED TO SUIT SITE REQUIREMENTS.

CONFIGURATION DESCRIPTION


GRATED INLET ONLY (NO INLET PIPE)	
GRATED INLET WITH INLET PIPE OR PIPES	<u>CHOSEN CONFIGURATION</u>
CURB INLET ONLY (NO INLET PIPE)	
CURB INLET WITH INLET PIPE OR PIPES	

**SITE SPECIFIC
DATA REQUIREMENTS**


STRUCTURE ID	STA. 54+00		
WATER QUALITY FLOW RATE (cfs [L/s])	0.08 cfs		
PEAK FLOW RATE (cfs [L/s])	5.28 cfs		
RETURN PERIOD OF PEAK FLOW (yrs)	10-YR.		
RIM ELEVATION	244.13		
PIPE DATA:	INVERT	MATERIAL	DIAMETER
INLET PIPE 1	239.88	RCP	15"
INLET PIPE 2	239.88	RCP	15"
OUTLET PIPE	228.97	RCP	18"

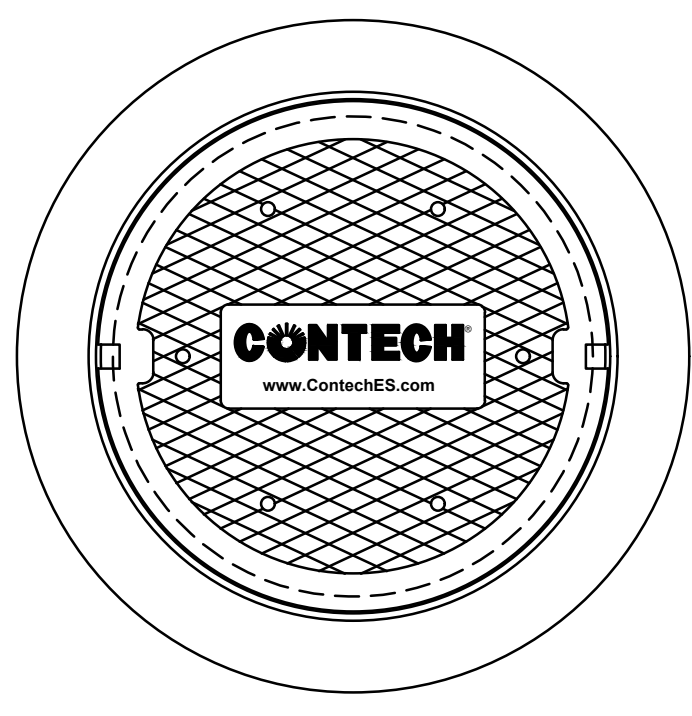

FRAME AND COVER
(DIAMETER VARIES)
NOT TO SCALE

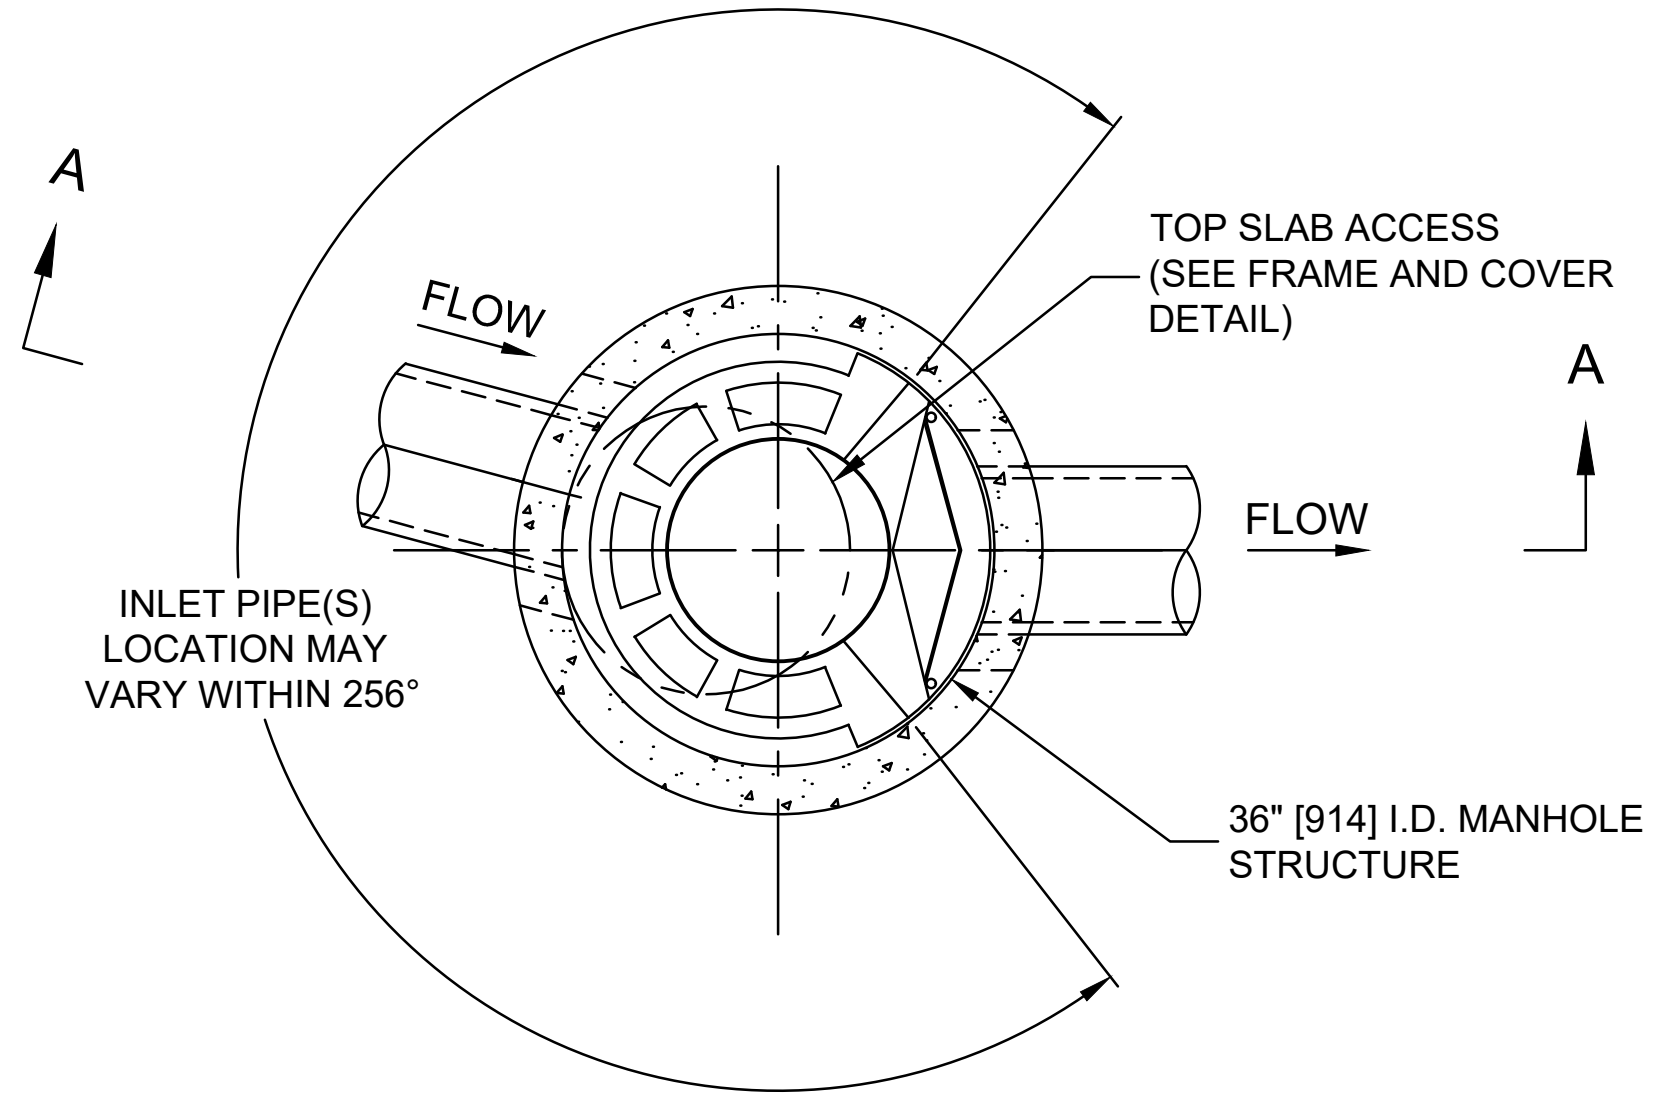

PLAN VIEW B-B
NOT TO SCALE

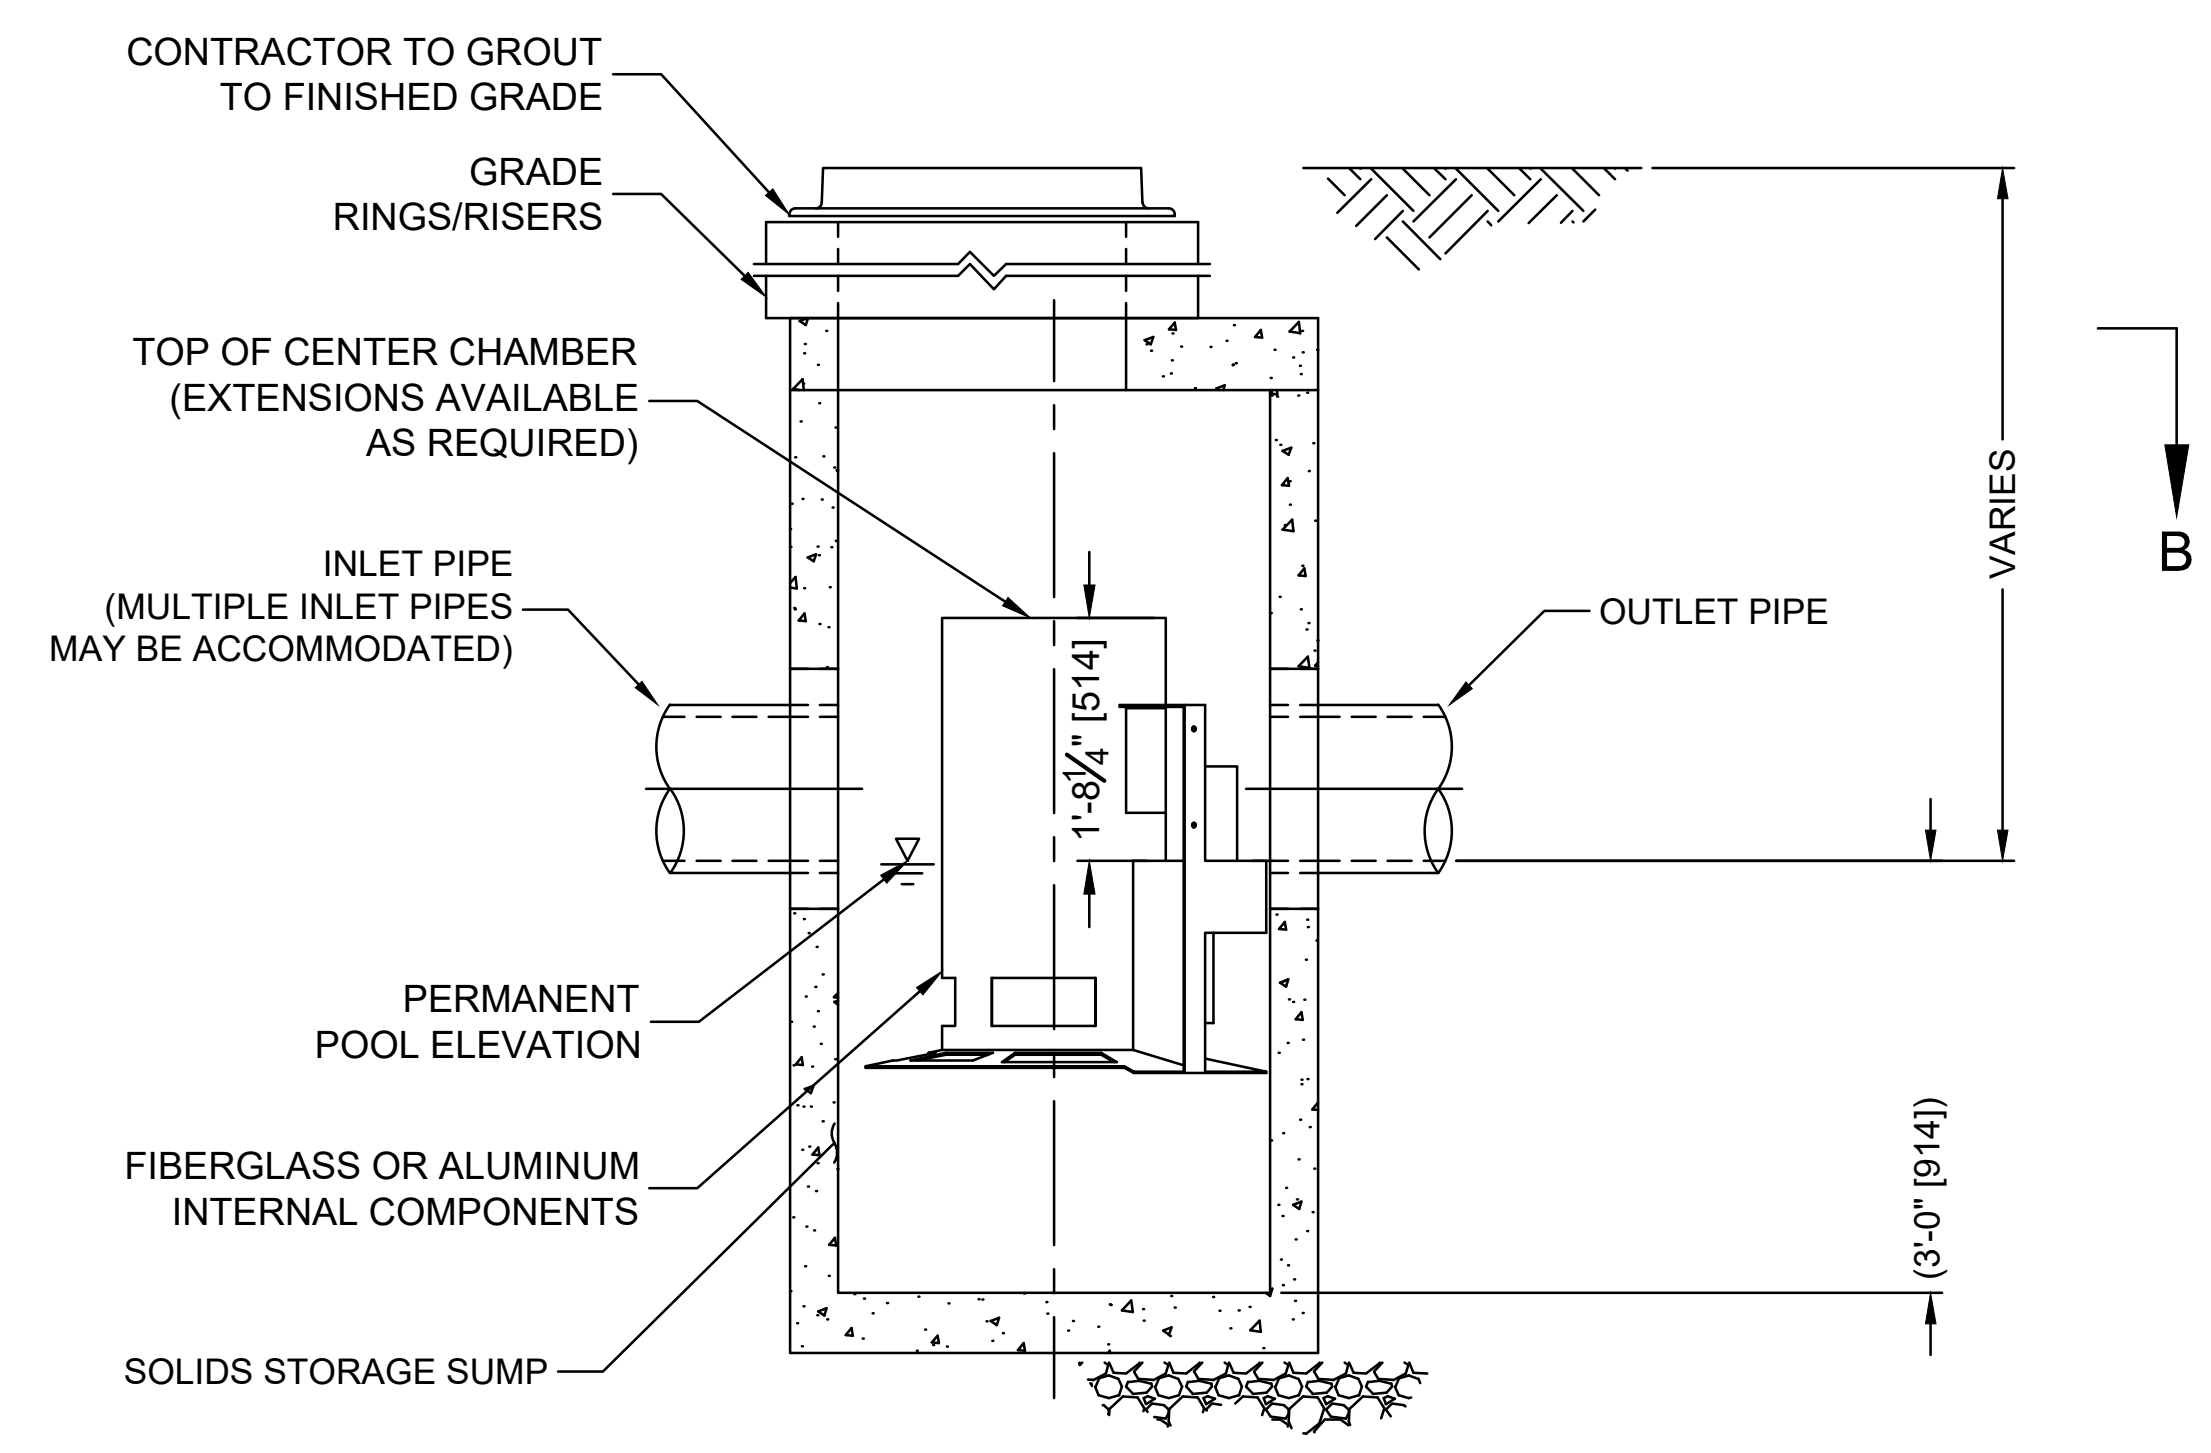

ELEVATION A-A
NOT TO SCALE

**CASCADE
separator™**

GENERAL NOTES

- CONTECH TO PROVIDE ALL MATERIALS UNLESS NOTED OTHERWISE.
- FOR SITE SPECIFIC DRAWINGS WITH DETAILED STRUCTURE DIMENSIONS AND WEIGHT, PLEASE CONTACT YOUR CONTECH ENGINEERED SOLUTIONS LLC REPRESENTATIVE. www.contechES.com
- CASCADE SEPARATOR WATER QUALITY STRUCTURE SHALL BE IN ACCORDANCE WITH ALL DESIGN DATA AND INFORMATION CONTAINED IN THIS DRAWING. CONTRACTOR TO CONFIRM STRUCTURE MEETS REQUIREMENTS OF PROJECT.
- CASCADE SEPARATOR STRUCTURE SHALL MEET AASHTO HS20 LOAD RATING, ASSUMING EARTH COVER OF 0' - 2' [610], AND GROUNDWATER ELEVATION AT, OR BELOW, THE OUTLET PIPE INVERT ELEVATION. ENGINEER OF RECORD TO CONFIRM ACTUAL GROUNDWATER ELEVATION. CASTINGS SHALL MEET AASHTO M306 AND BE CAST WITH THE CONTECH LOGO.
- CASCADE SEPARATOR STRUCTURE SHALL BE PRECAST CONCRETE CONFORMING TO ASTM C478 AND AASHTO LOAD FACTOR DESIGN METHOD.
- ALTERNATE UNITS ARE SHOWN IN MILLIMETERS [mm].

INSTALLATION NOTES

- ANY SUB-BASE, BACKFILL DEPTH, AND/OR ANTI-FLOTATION PROVISIONS ARE SITE-SPECIFIC DESIGN CONSIDERATIONS AND SHALL BE SPECIFIED BY ENGINEER OF RECORD.
- CONTRACTOR TO PROVIDE EQUIPMENT WITH SUFFICIENT LIFTING AND REACH CAPACITY TO LIFT AND SET THE CASCADE SEPARATOR MANHOLE STRUCTURE.
- CONTRACTOR TO INSTALL JOINT SEALANT BETWEEN ALL STRUCTURE SECTIONS AND ASSEMBLE STRUCTURE.
- CONTRACTOR TO PROVIDE, INSTALL, AND GROUT INLET AND OUTLET PIPE(S). MATCH PIPE INVERTS WITH ELEVATIONS SHOWN. ALL PIPE CENTERLINES TO MATCH PIPE OPENING CENTERLINES.
- CONTRACTOR TO TAKE APPROPRIATE MEASURES TO ASSURE UNIT IS WATER TIGHT, HOLDING WATER TO FLOWLINE INVERT MINIMUM. IT IS SUGGESTED THAT ALL JOINTS BELOW PIPE INVERTS ARE GROUTED.

CONTECH
ENGINEERED SOLUTIONS LLC
www.contechES.com
9025 Centre Pointe Dr., Suite 400, West Chester, OH 45069
800-338-1122 513-645-7000 513-645-7993 FAX

CS-3
CASCADE SEPARATOR
STANDARD DETAIL



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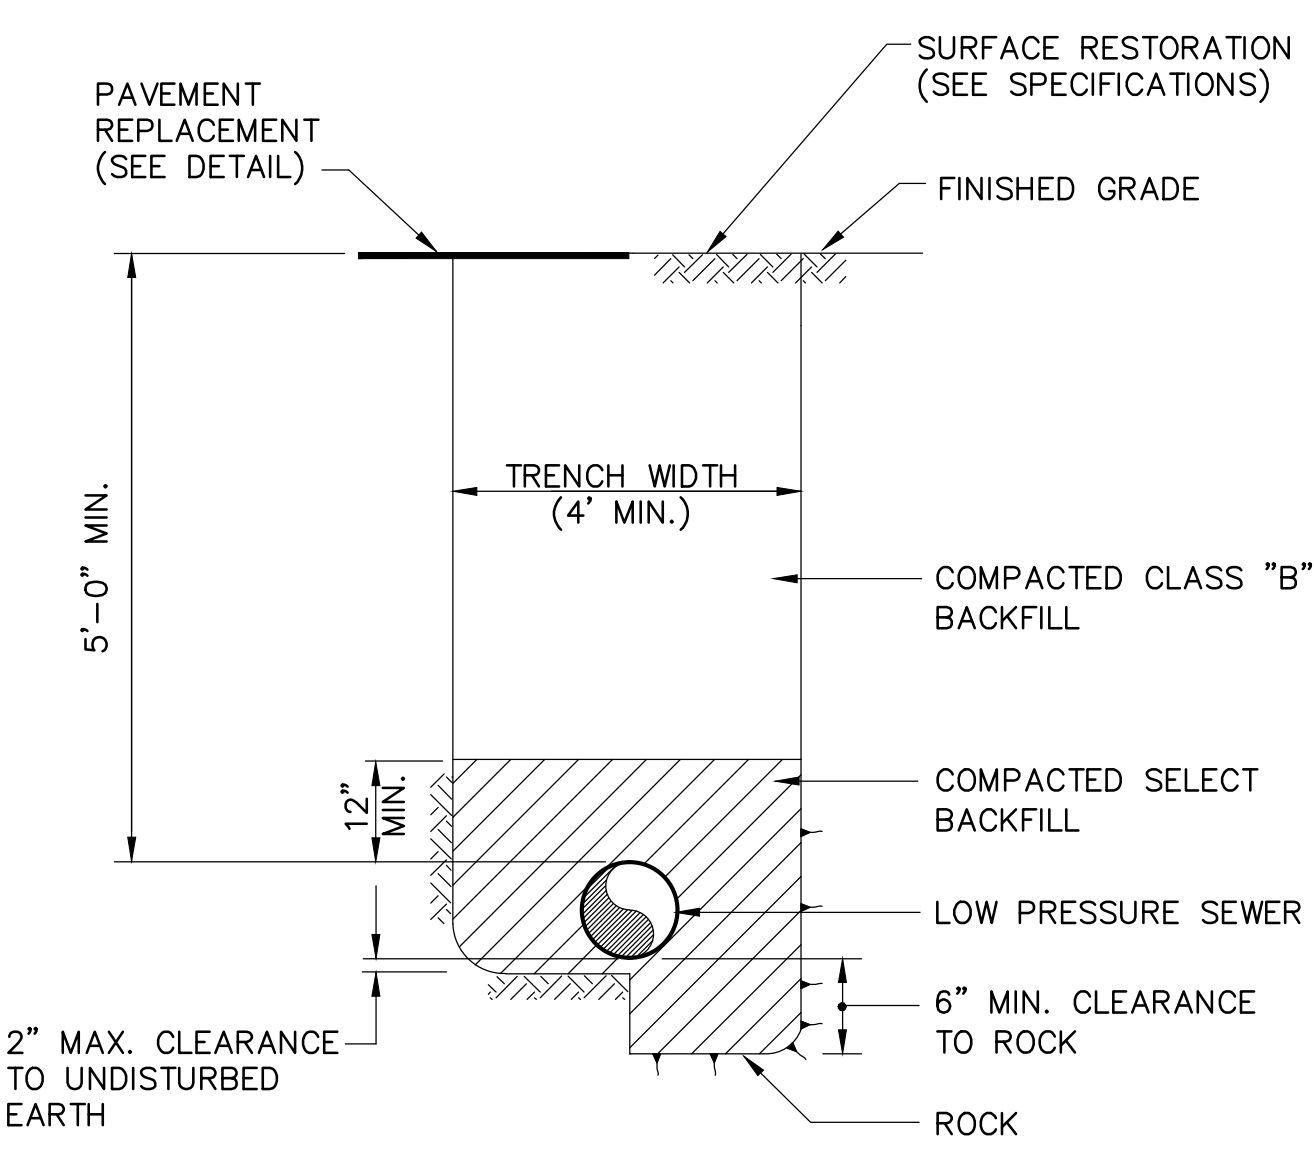
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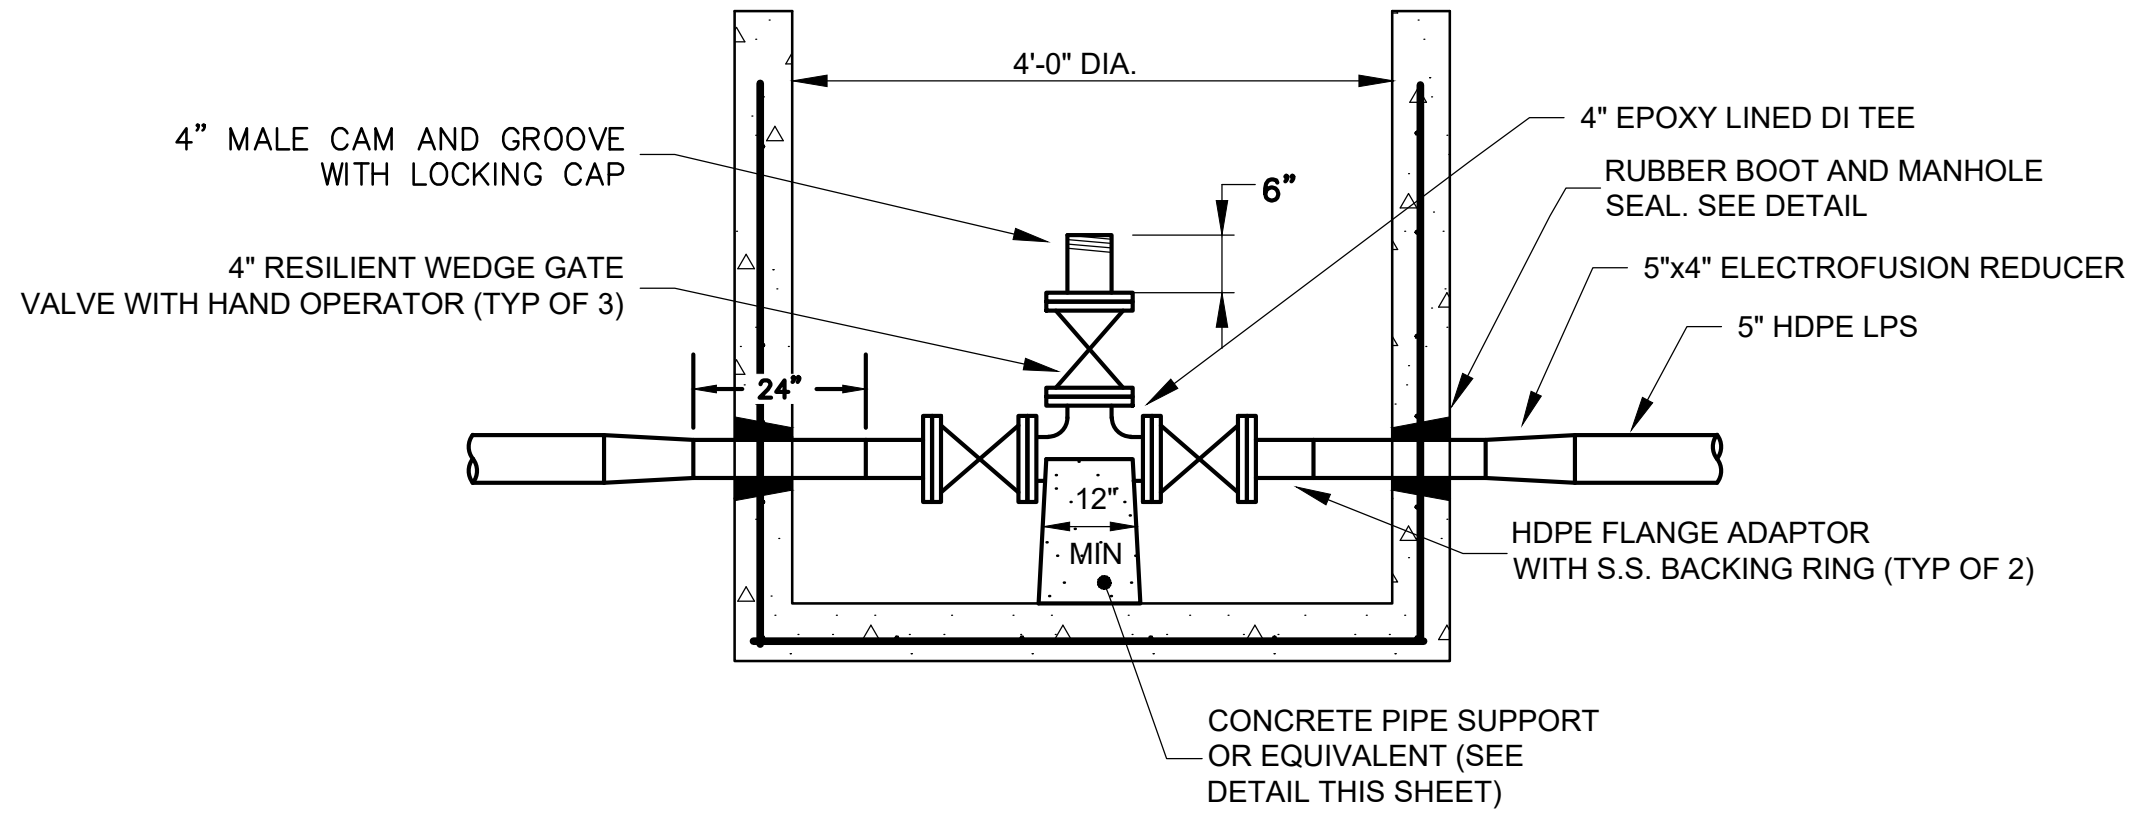
**LOW PRESSURE
SEWER DETAILS**

Sheet Number:

DET-04




LOW PRESSURE SEWERTRENCH DETAIL
N.T.S.




NOTE: ALL MANHOLE MATERIALS TO BE AS SHOWN ON TYPICAL PRECAST MANHOLE DETAIL.

LPS CLEANOUT MANHOLE DETAIL
N.T.S.

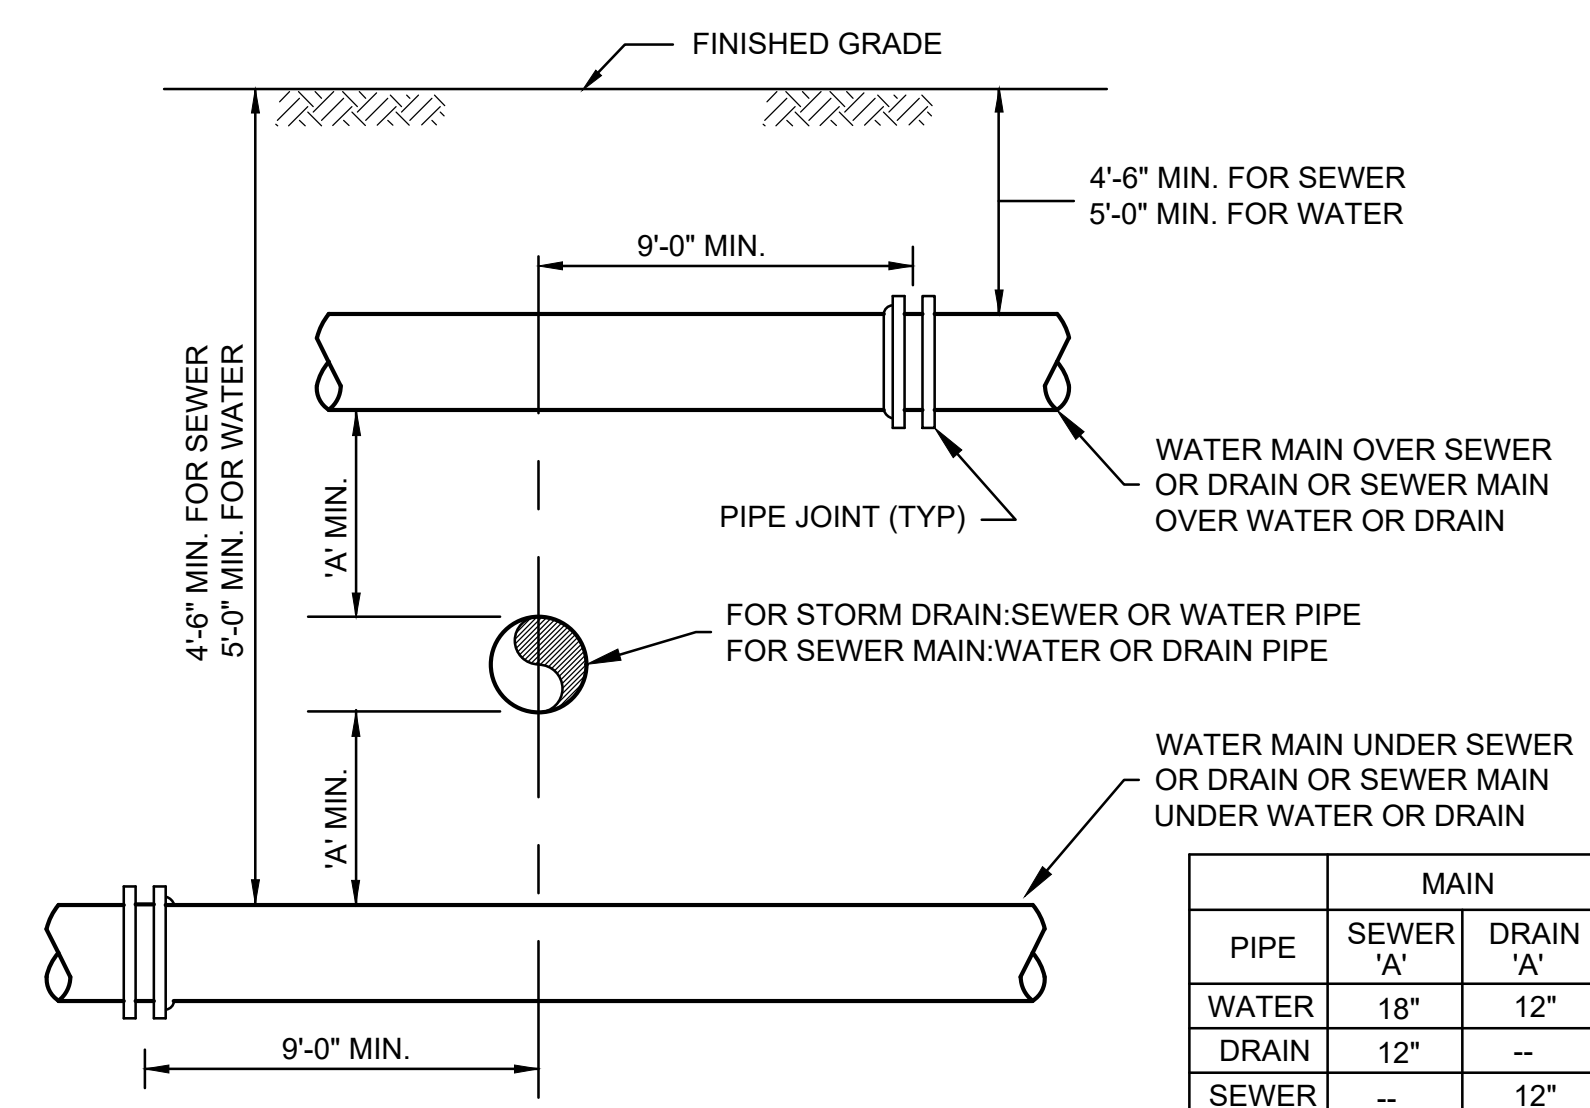


WATER, SEWER OR DRAIN CROSSING DETAIL
N.T.S.


PIPE	MAIN	
	SEWER 'A'	DRAIN 'A'
WATER	18"	12"
DRAIN	12"	--
SEWER	--	12"

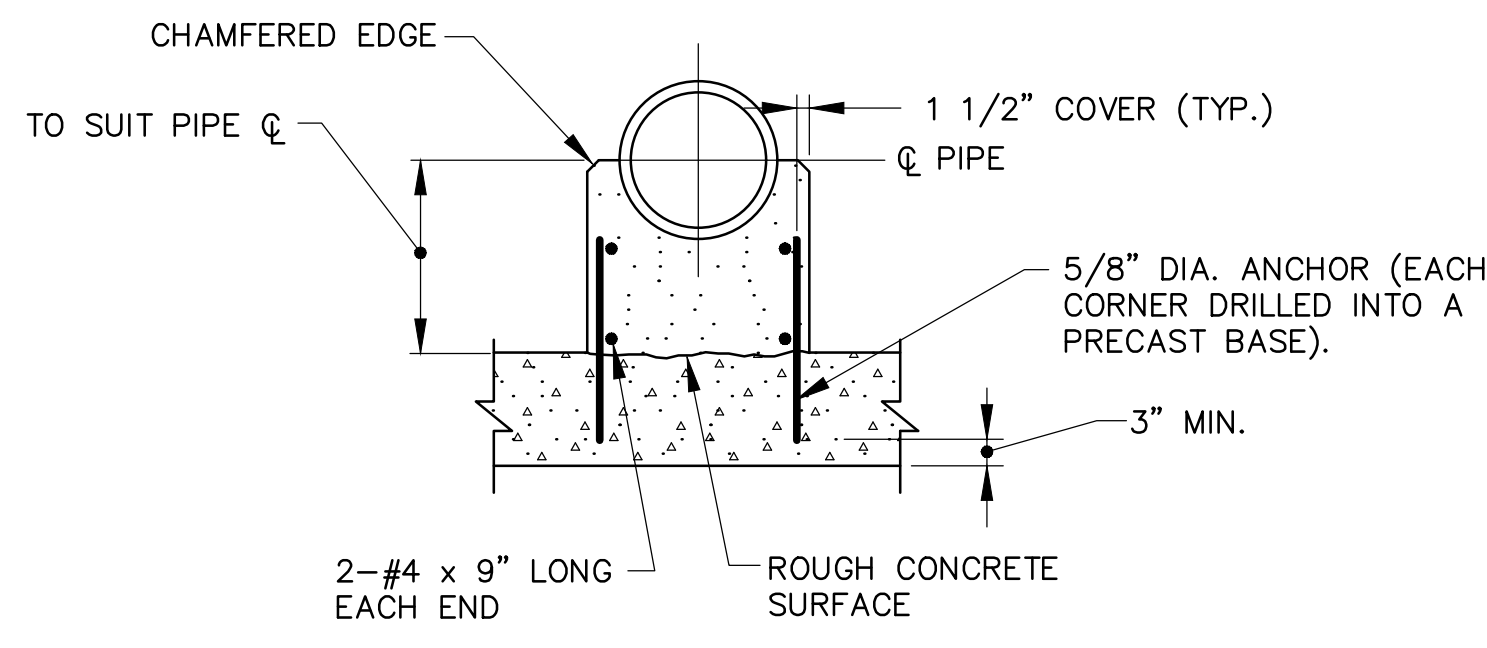

CONCRETE PIPE SUPPORT
N.T.S.

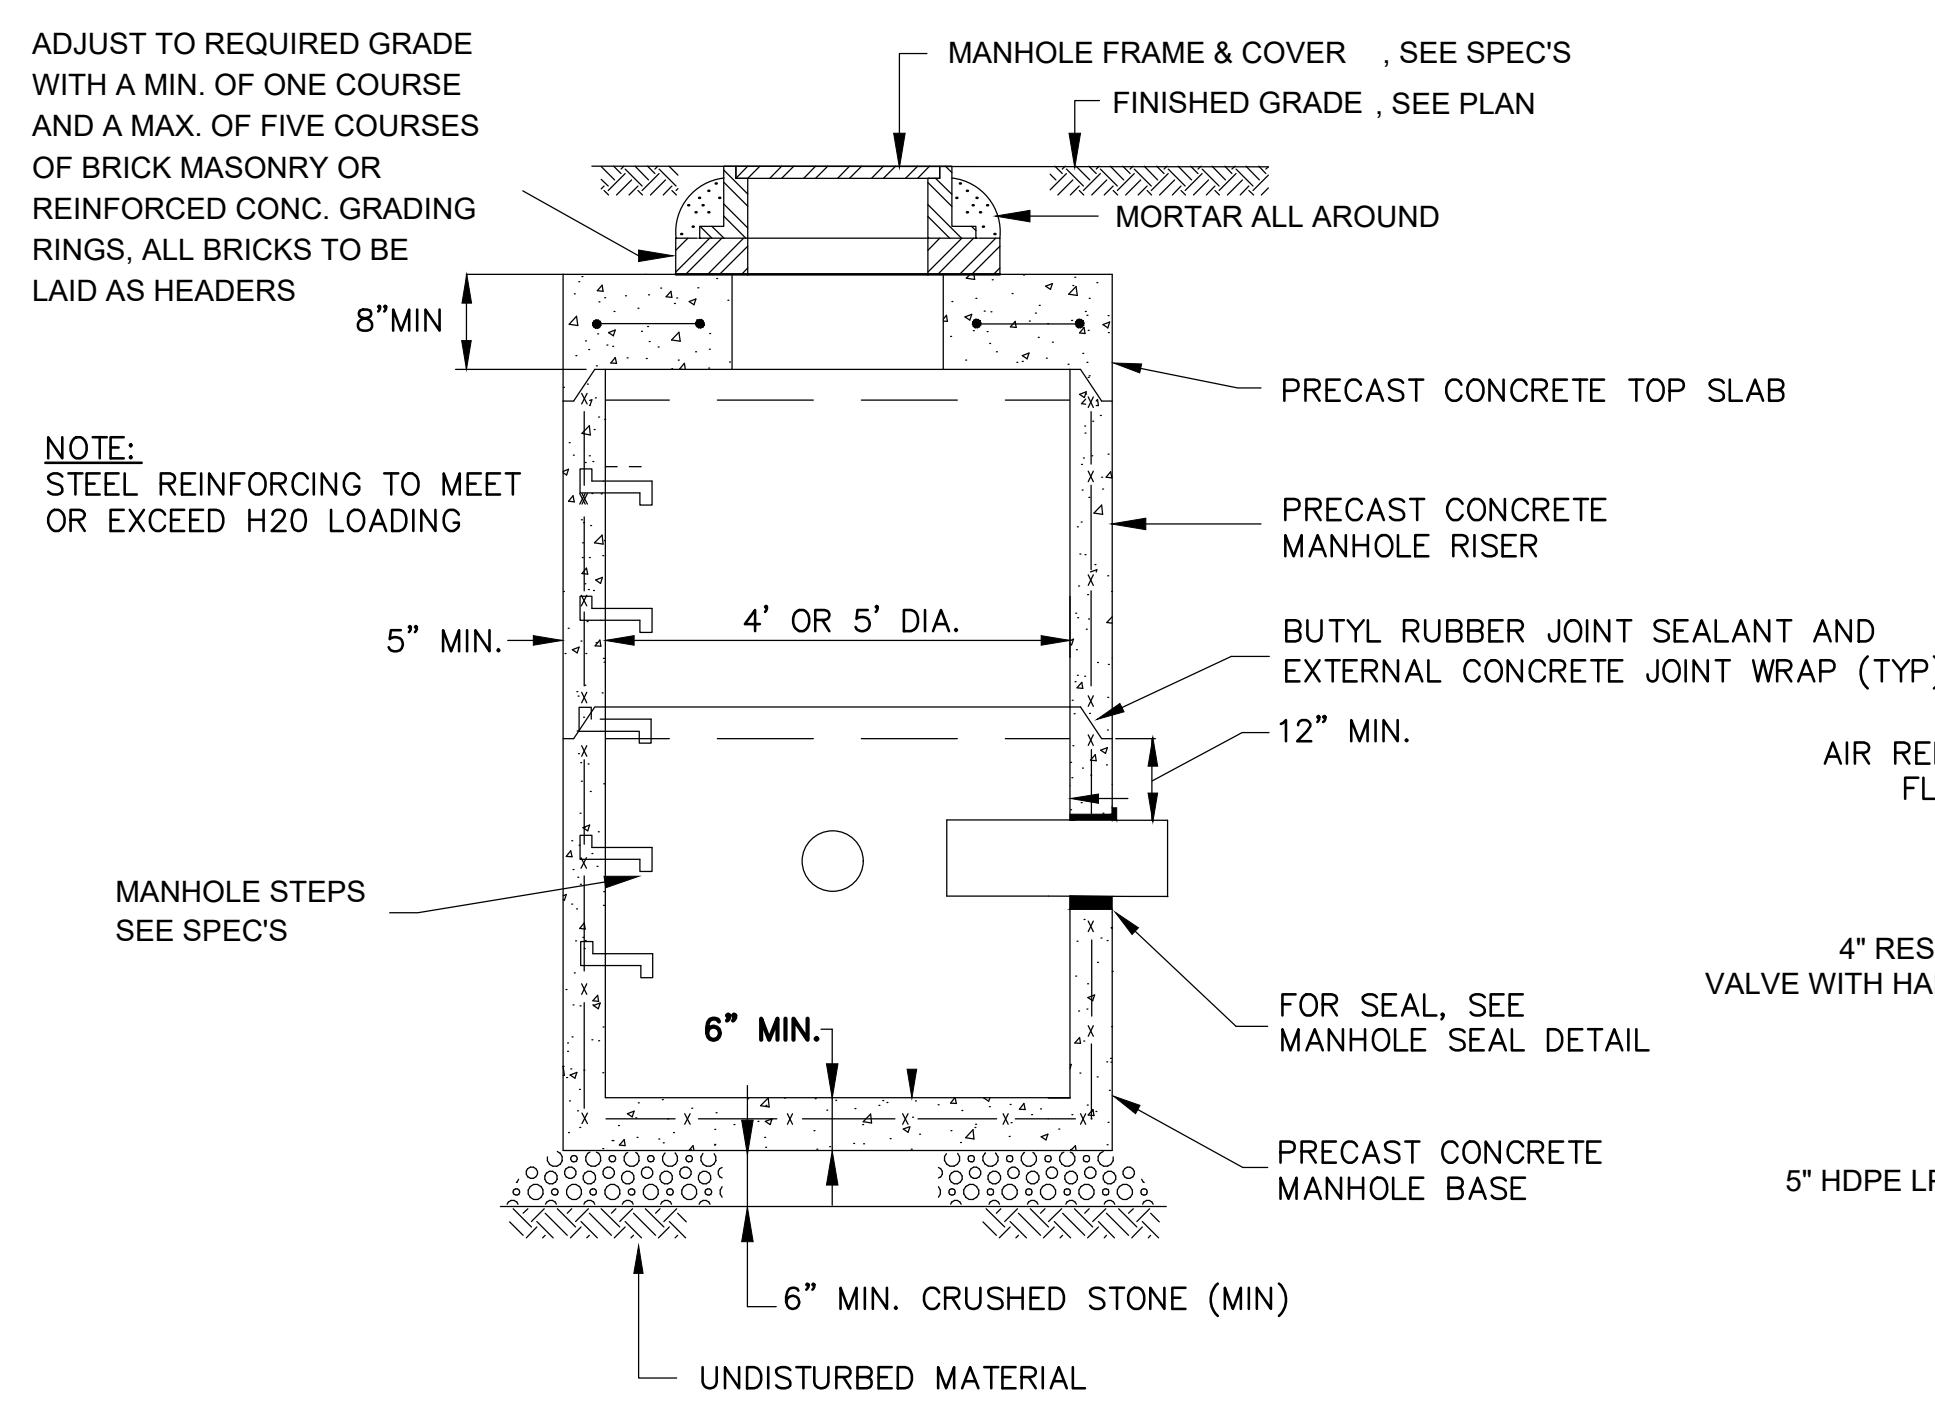


PRECAST CONCRETE MANHOLE DETAIL
N.T.S.

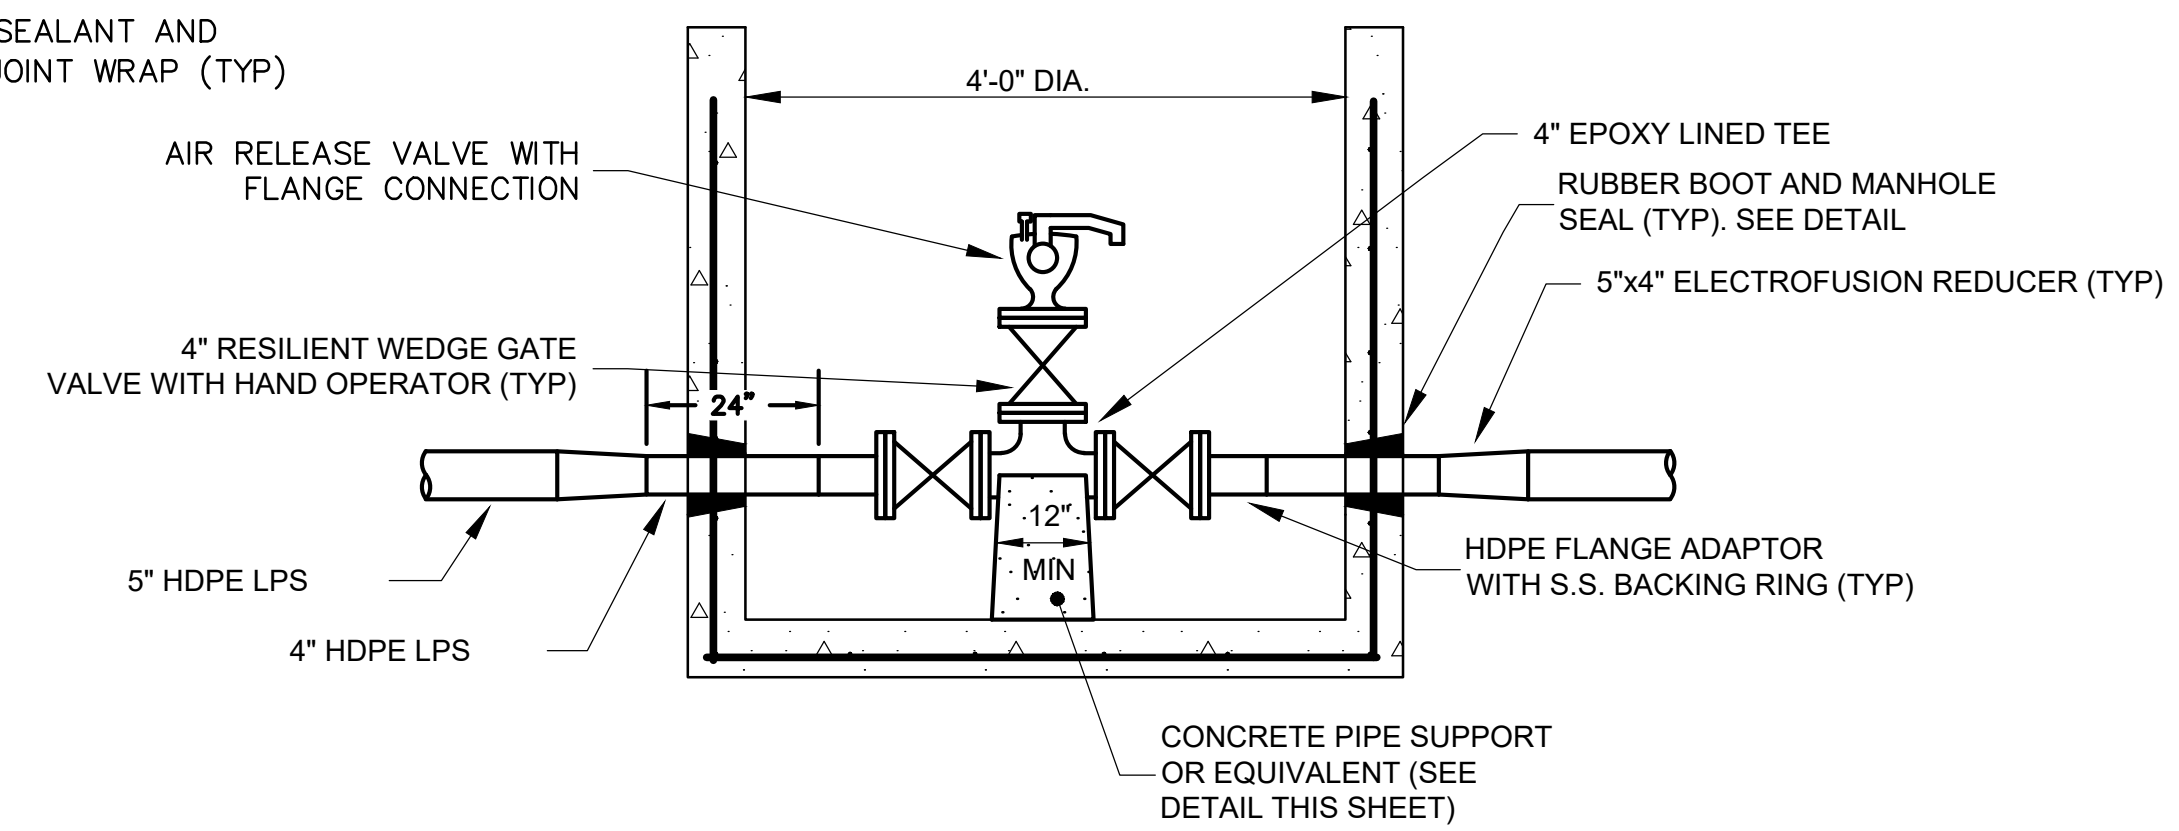


NOTE: ALL MANHOLE MATERIALS TO BE AS SHOWN ON TYPICAL PRECAST MANHOLE DETAIL.

LPS AIR RELEASE MANHOLE DETAIL
N.T.S.

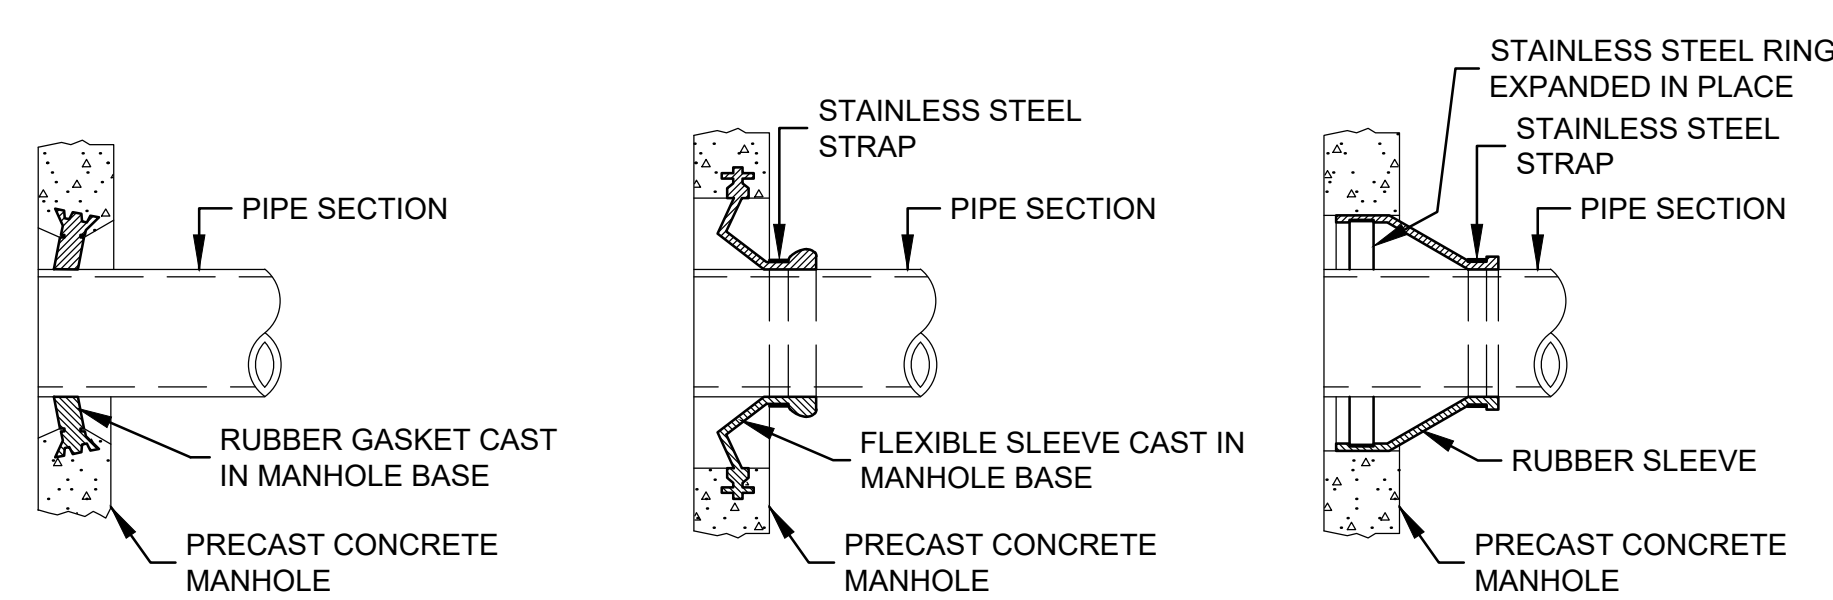

MANHOLE SEAL DETAILS
N.T.S.

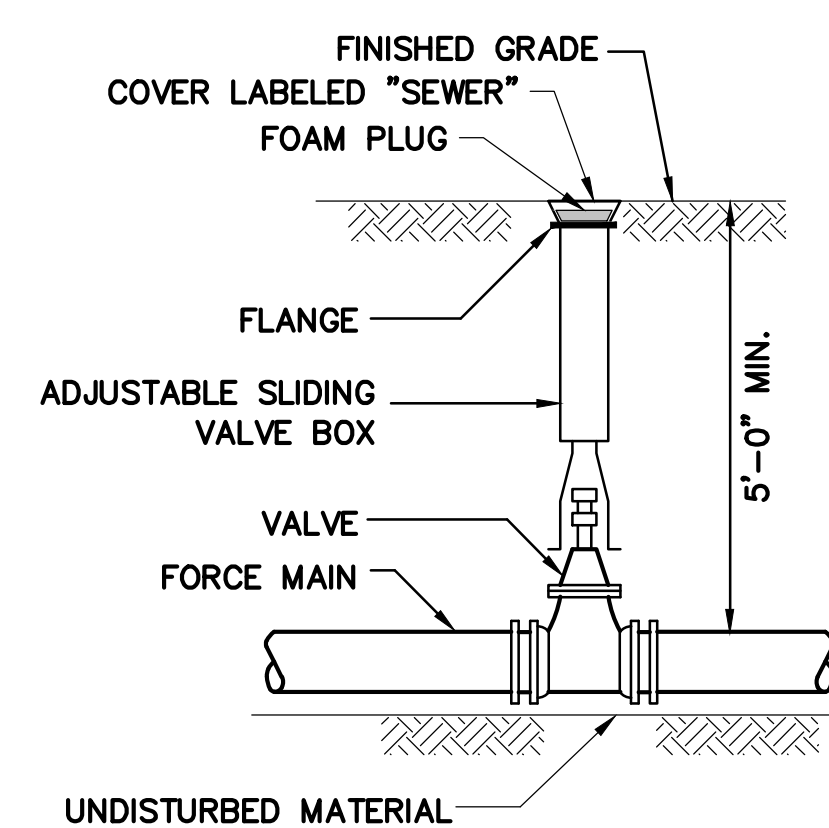

VALVE AND BOX DETAIL
N.T.S.

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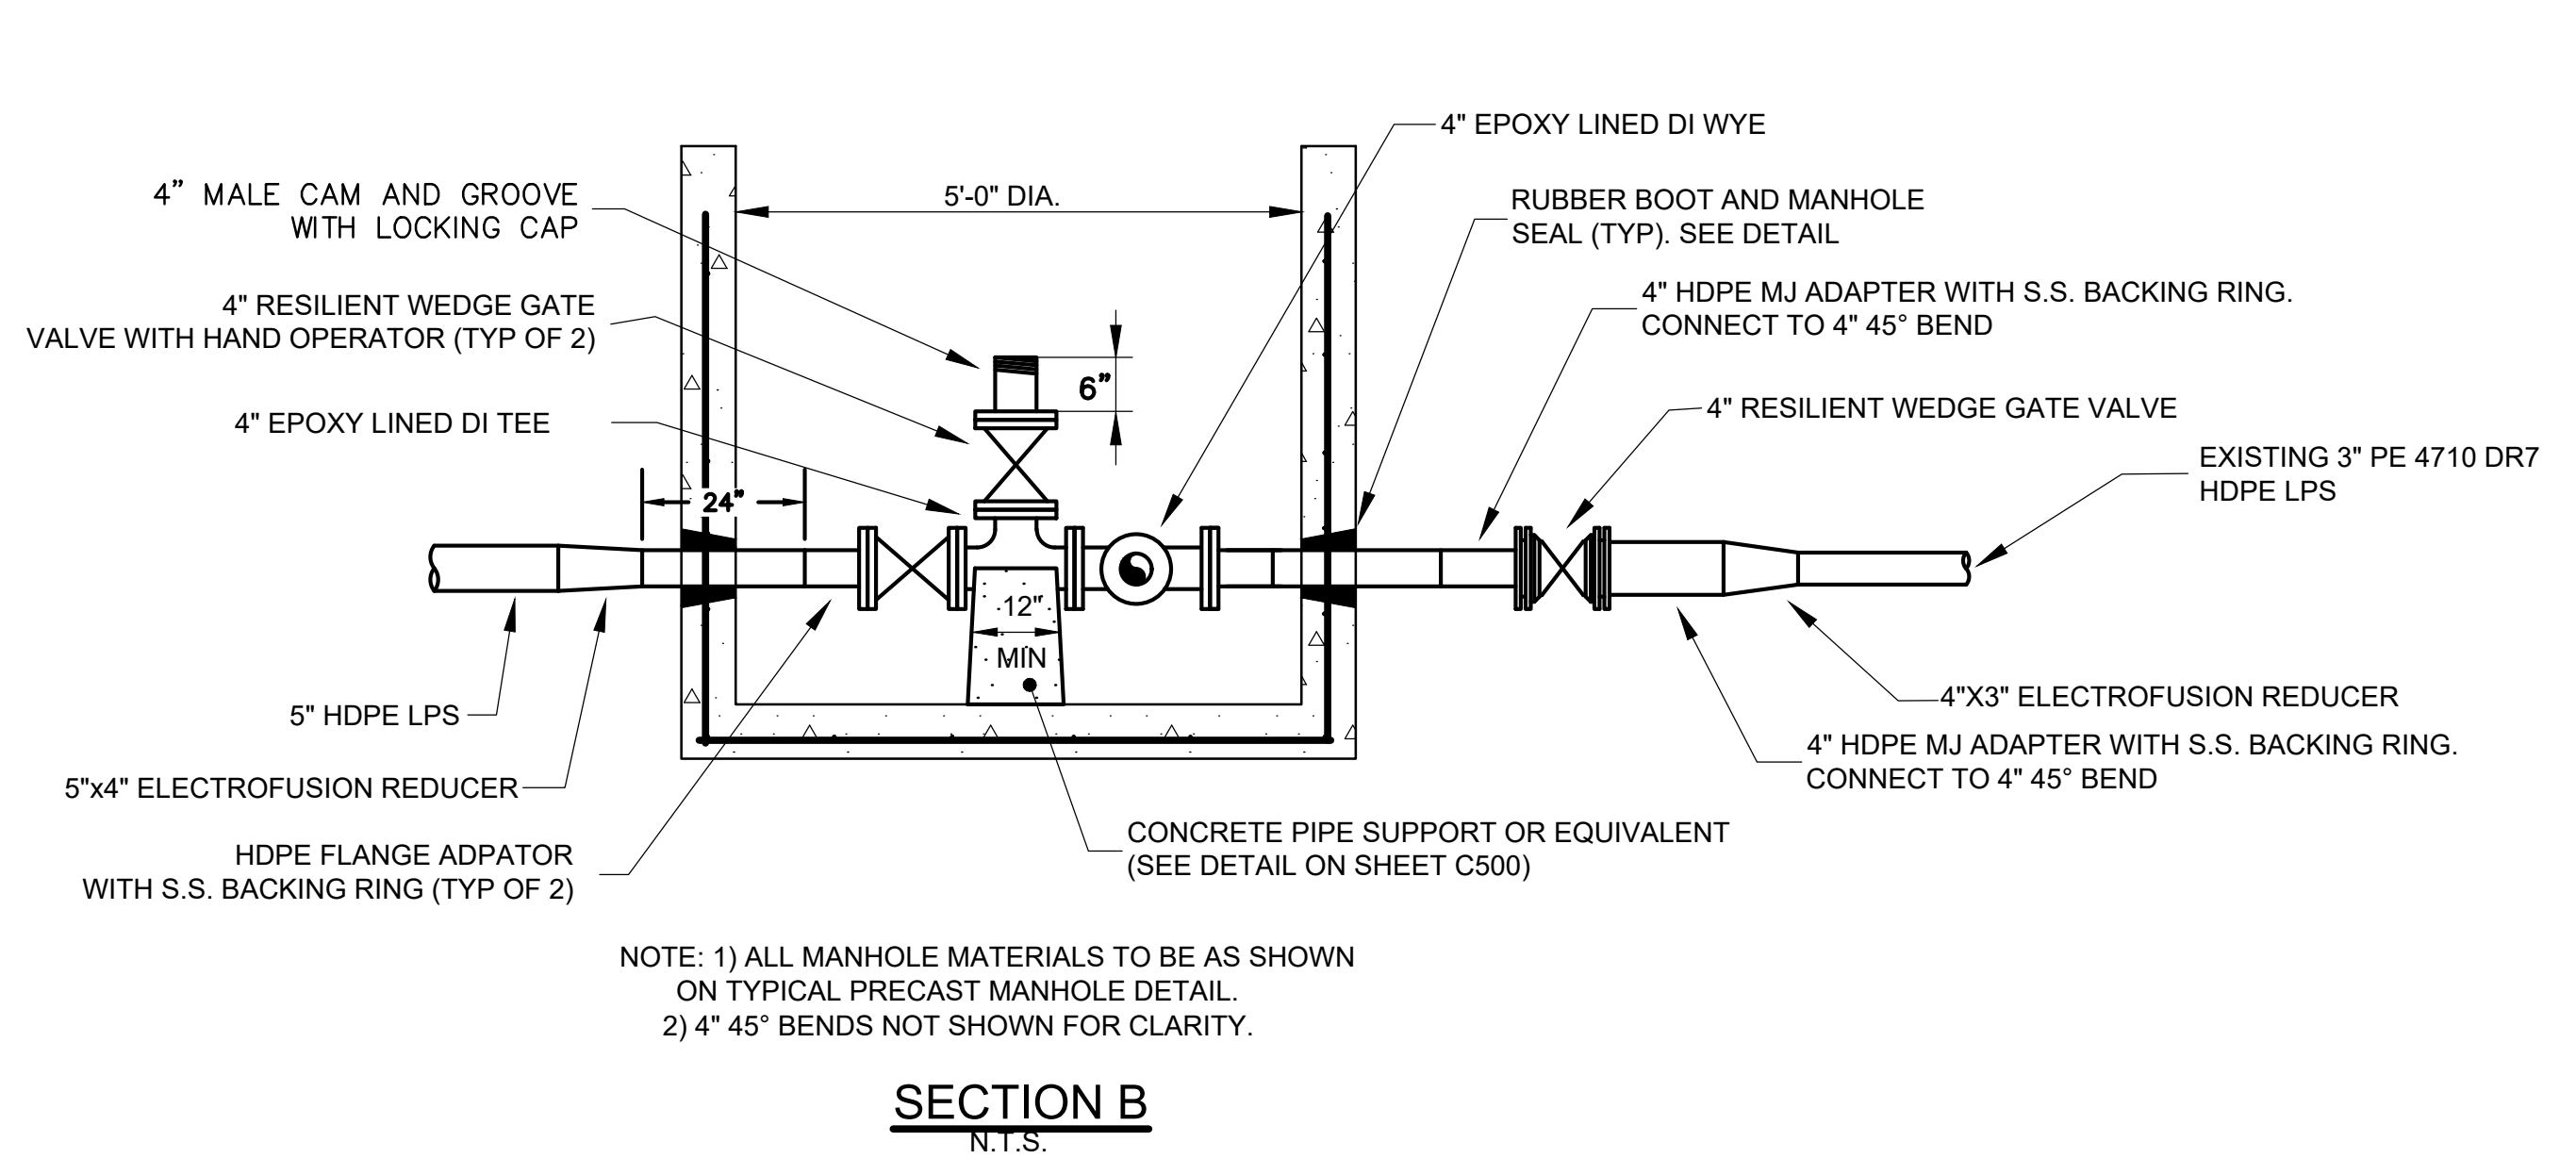
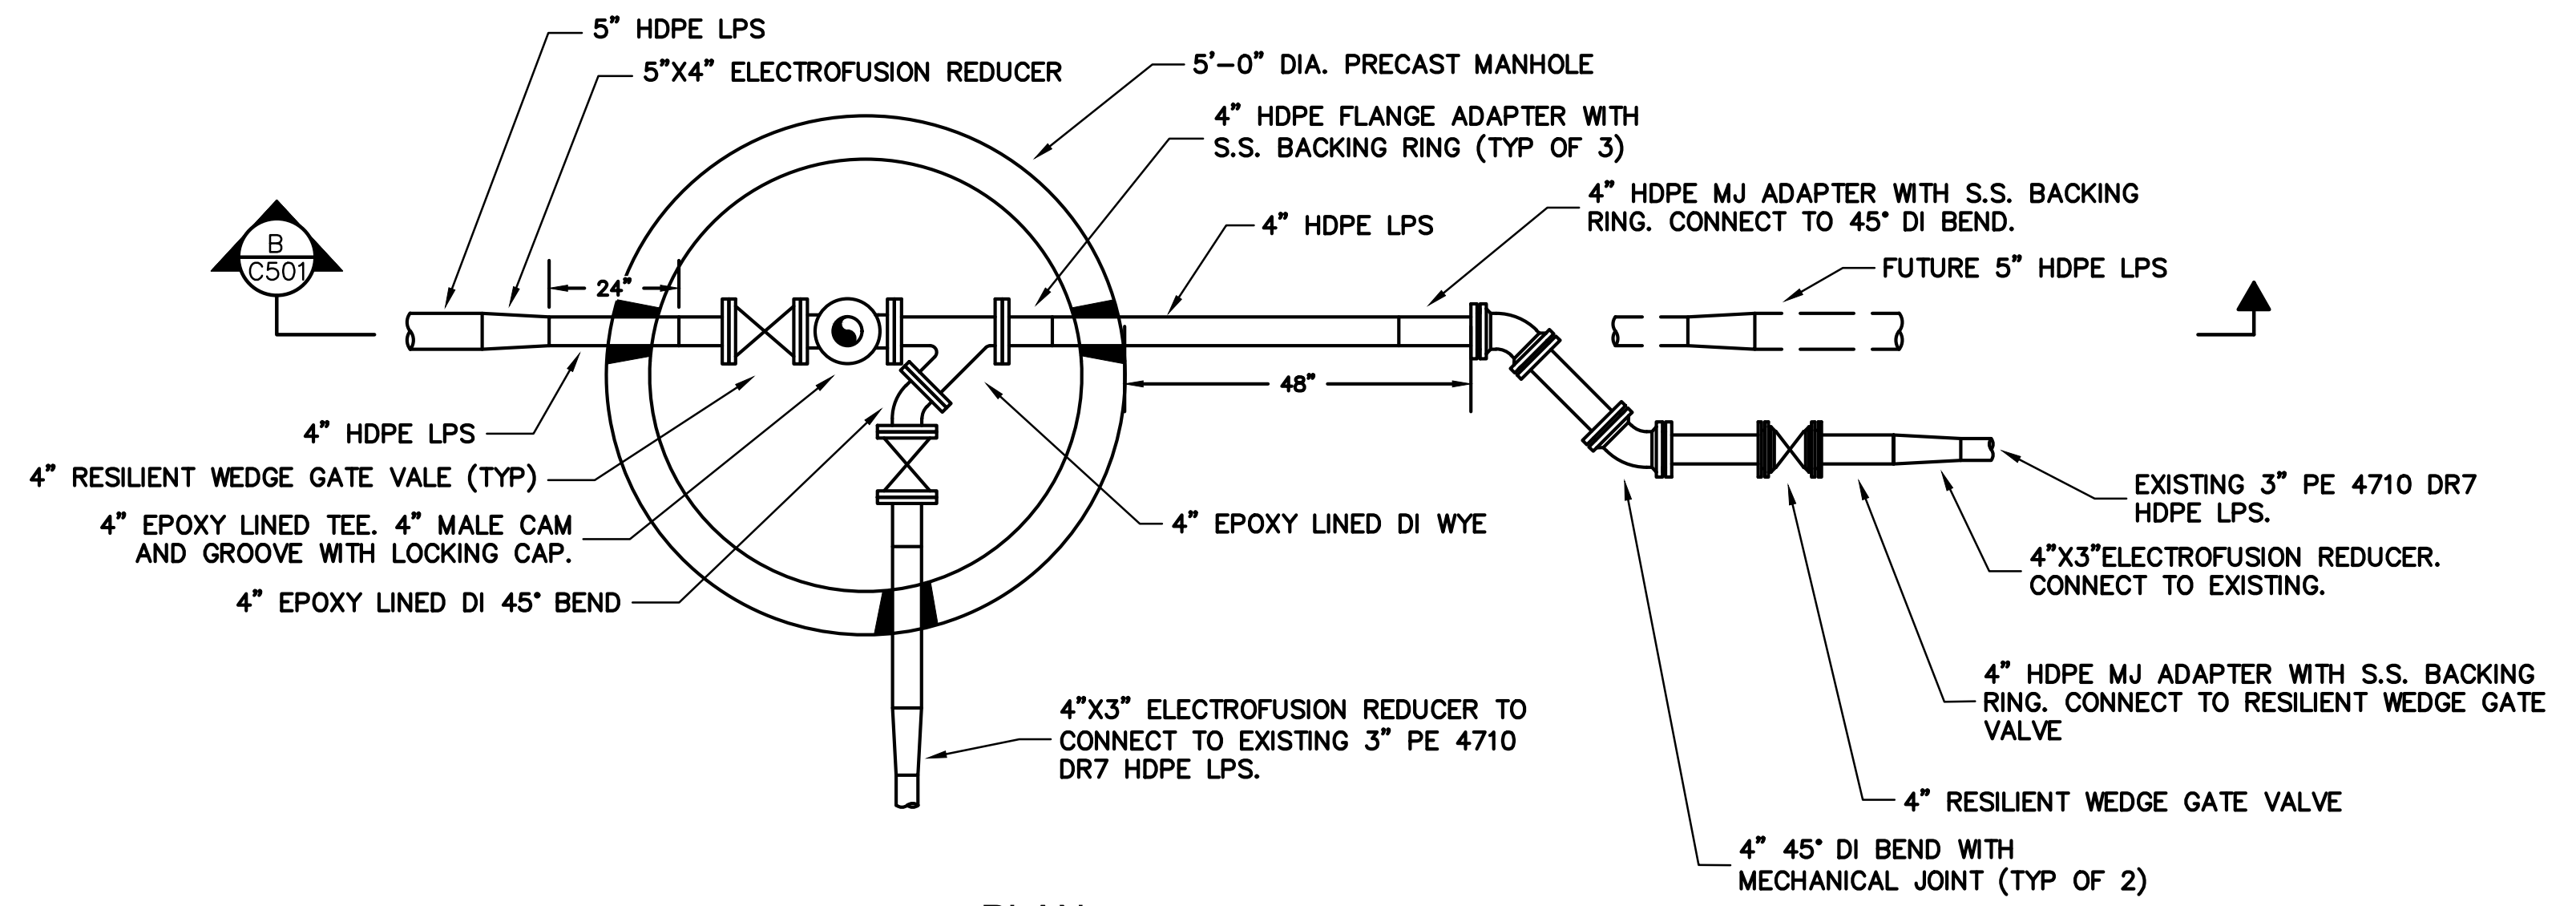
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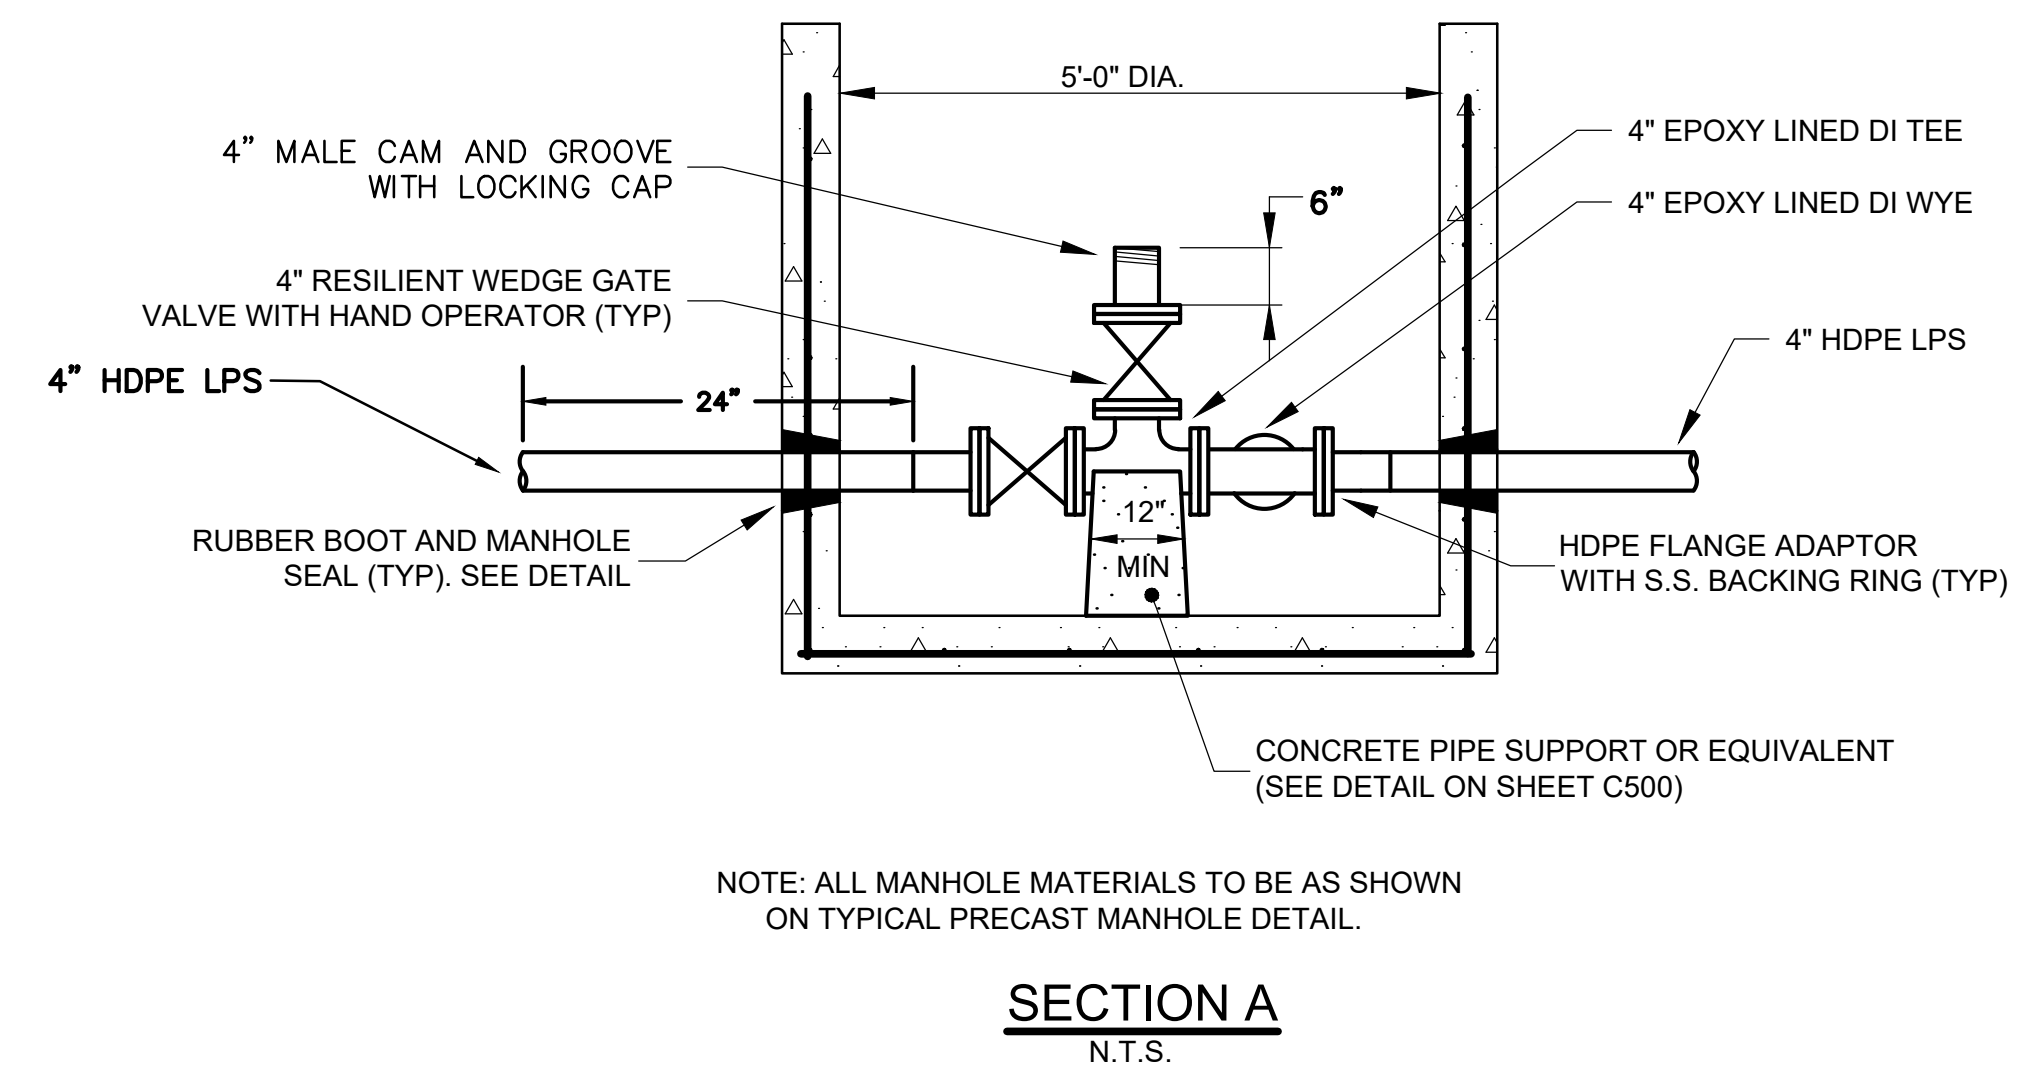
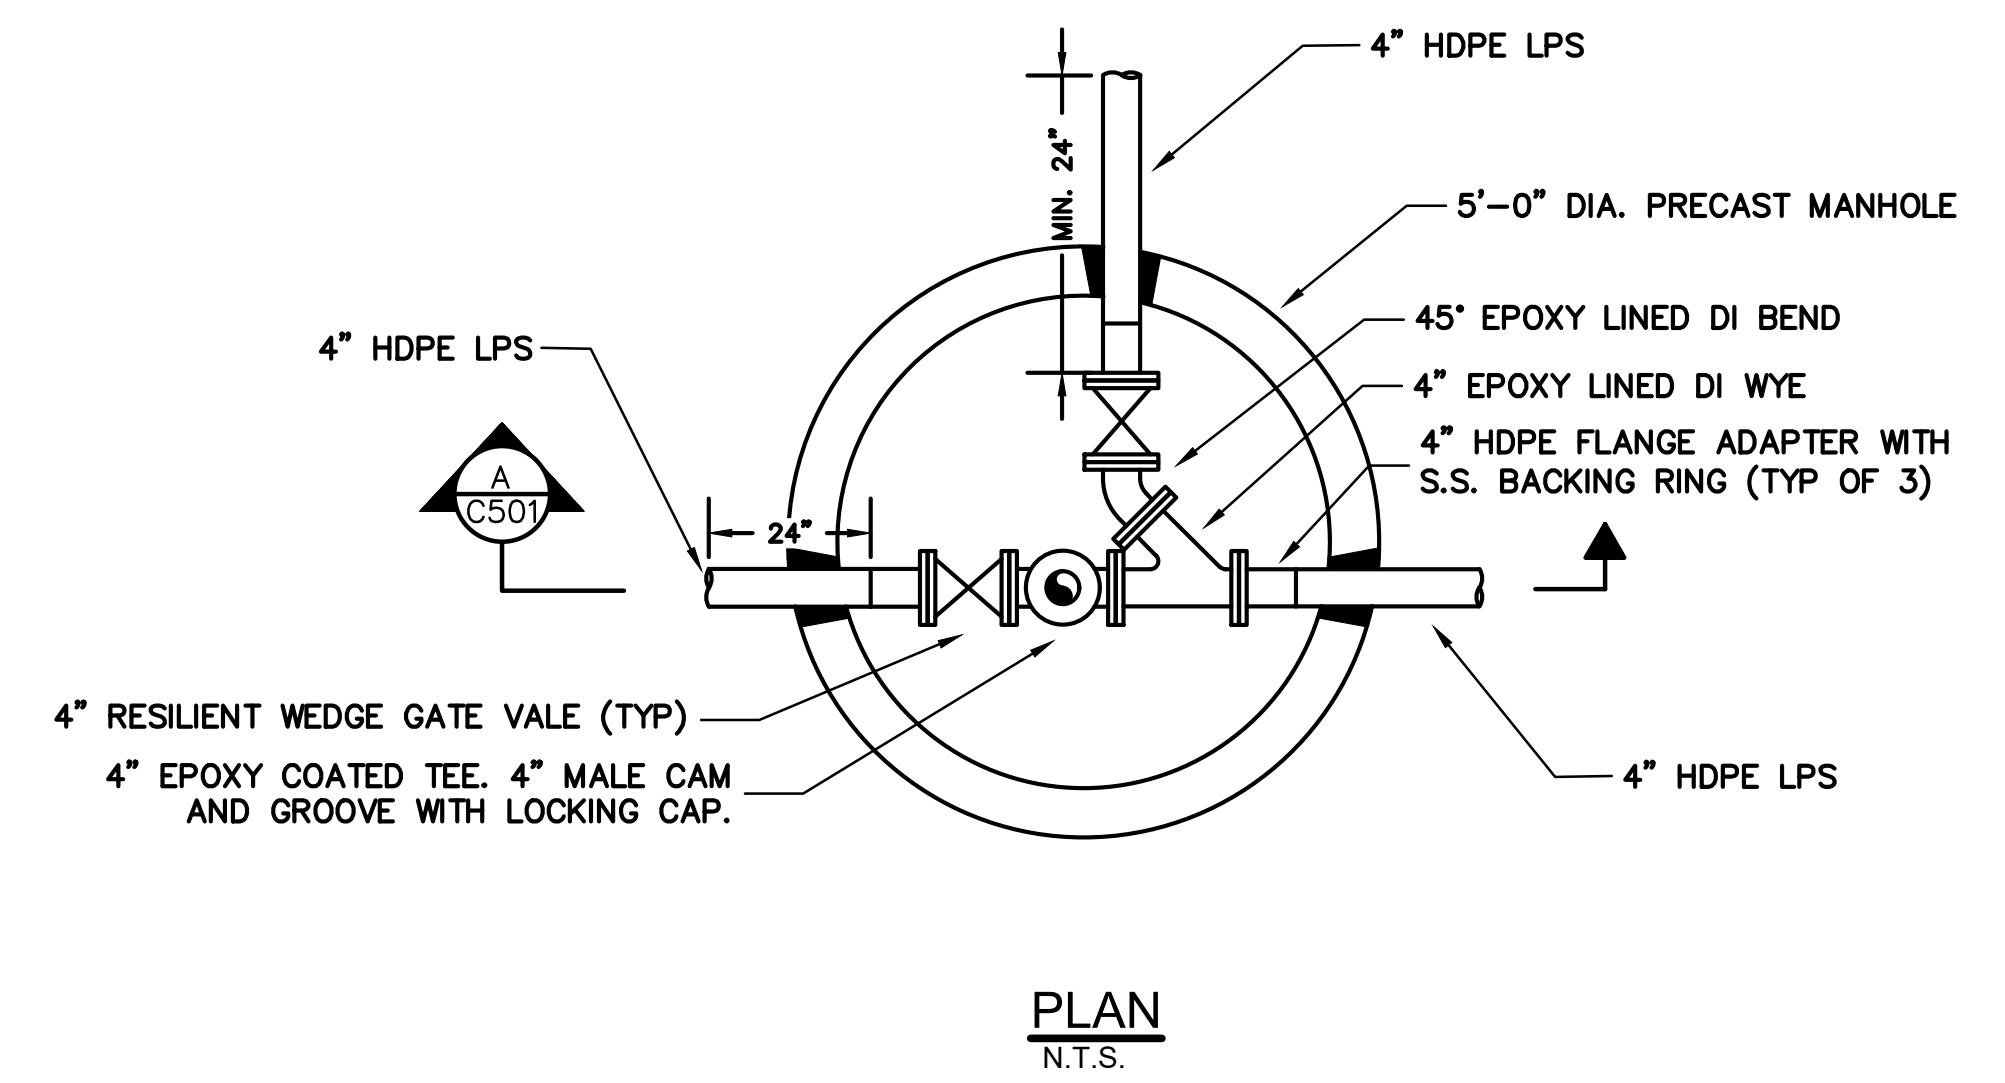
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Reviewed By: RC
Approved By: LAS
W&S Project No.: ENG20-1119
W&S File No.:

Drawing Title:
LOW PRESSURE SEWER DETAILS


Sheet Number:
DET-05




LOW PRESSURE SEWER "HIGH SCHOOL" MANHOLE
N.T.S.



LOW PRESSURE SEWER JUNCTION MANHOLE
N.T.S.

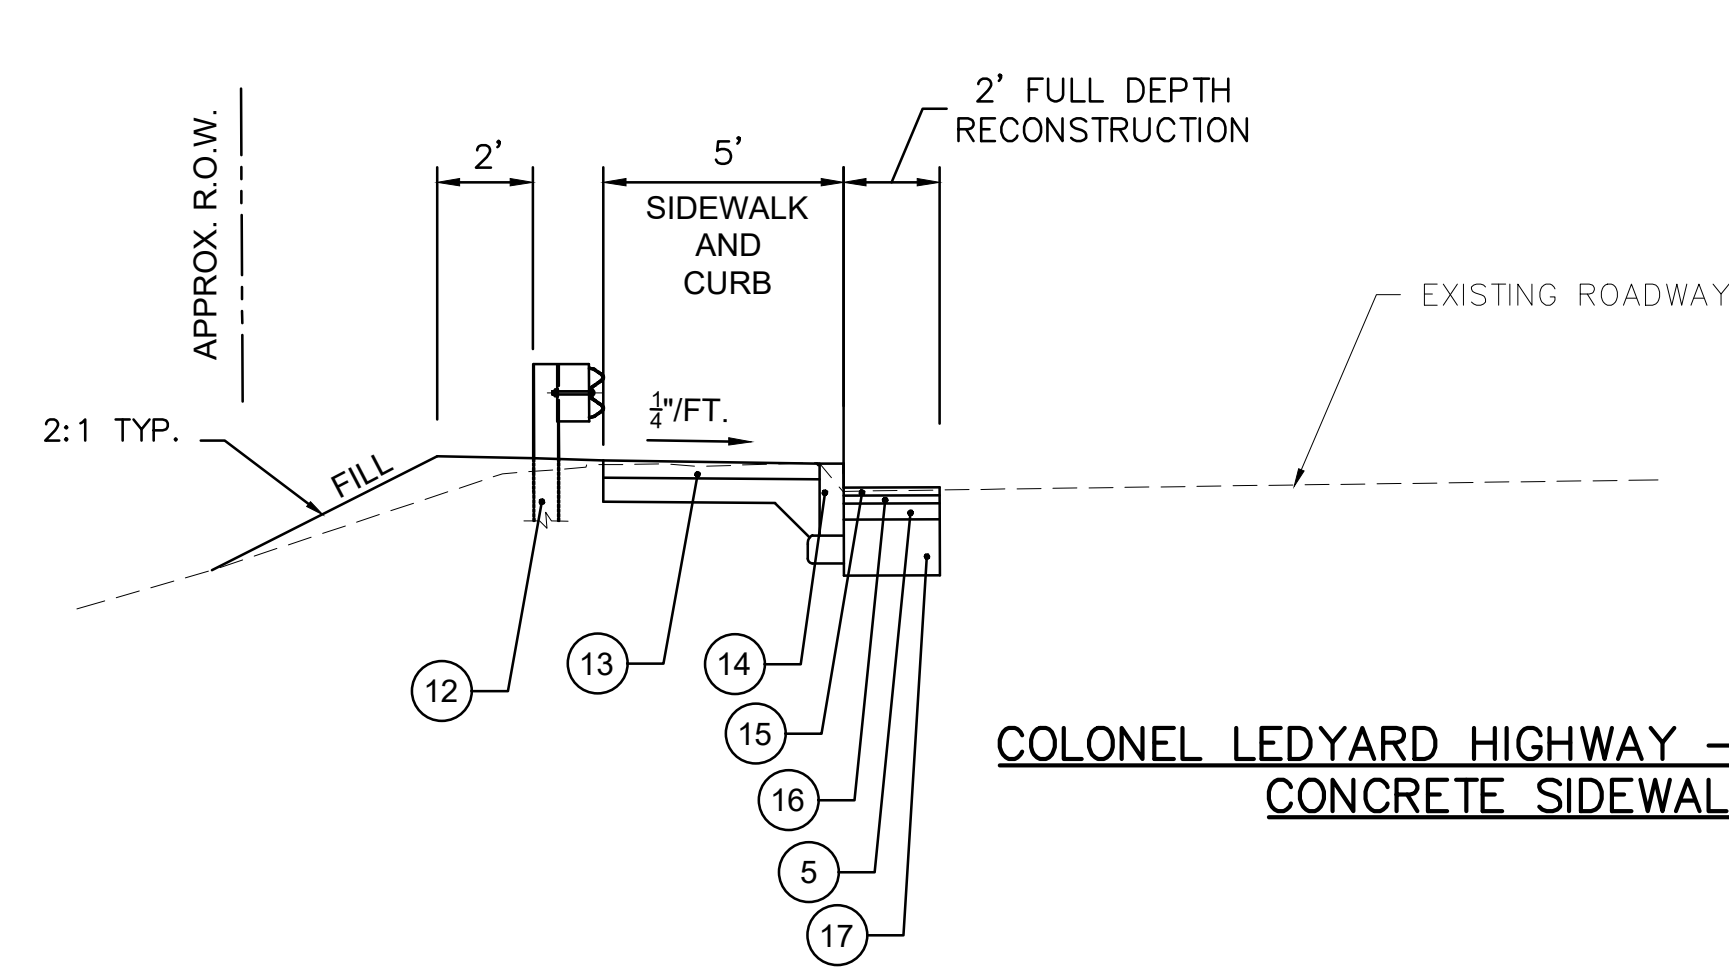


**COLONEL LEDYARD HIGHWAY – ROUTE 117
CONCRETE SIDEWALK**

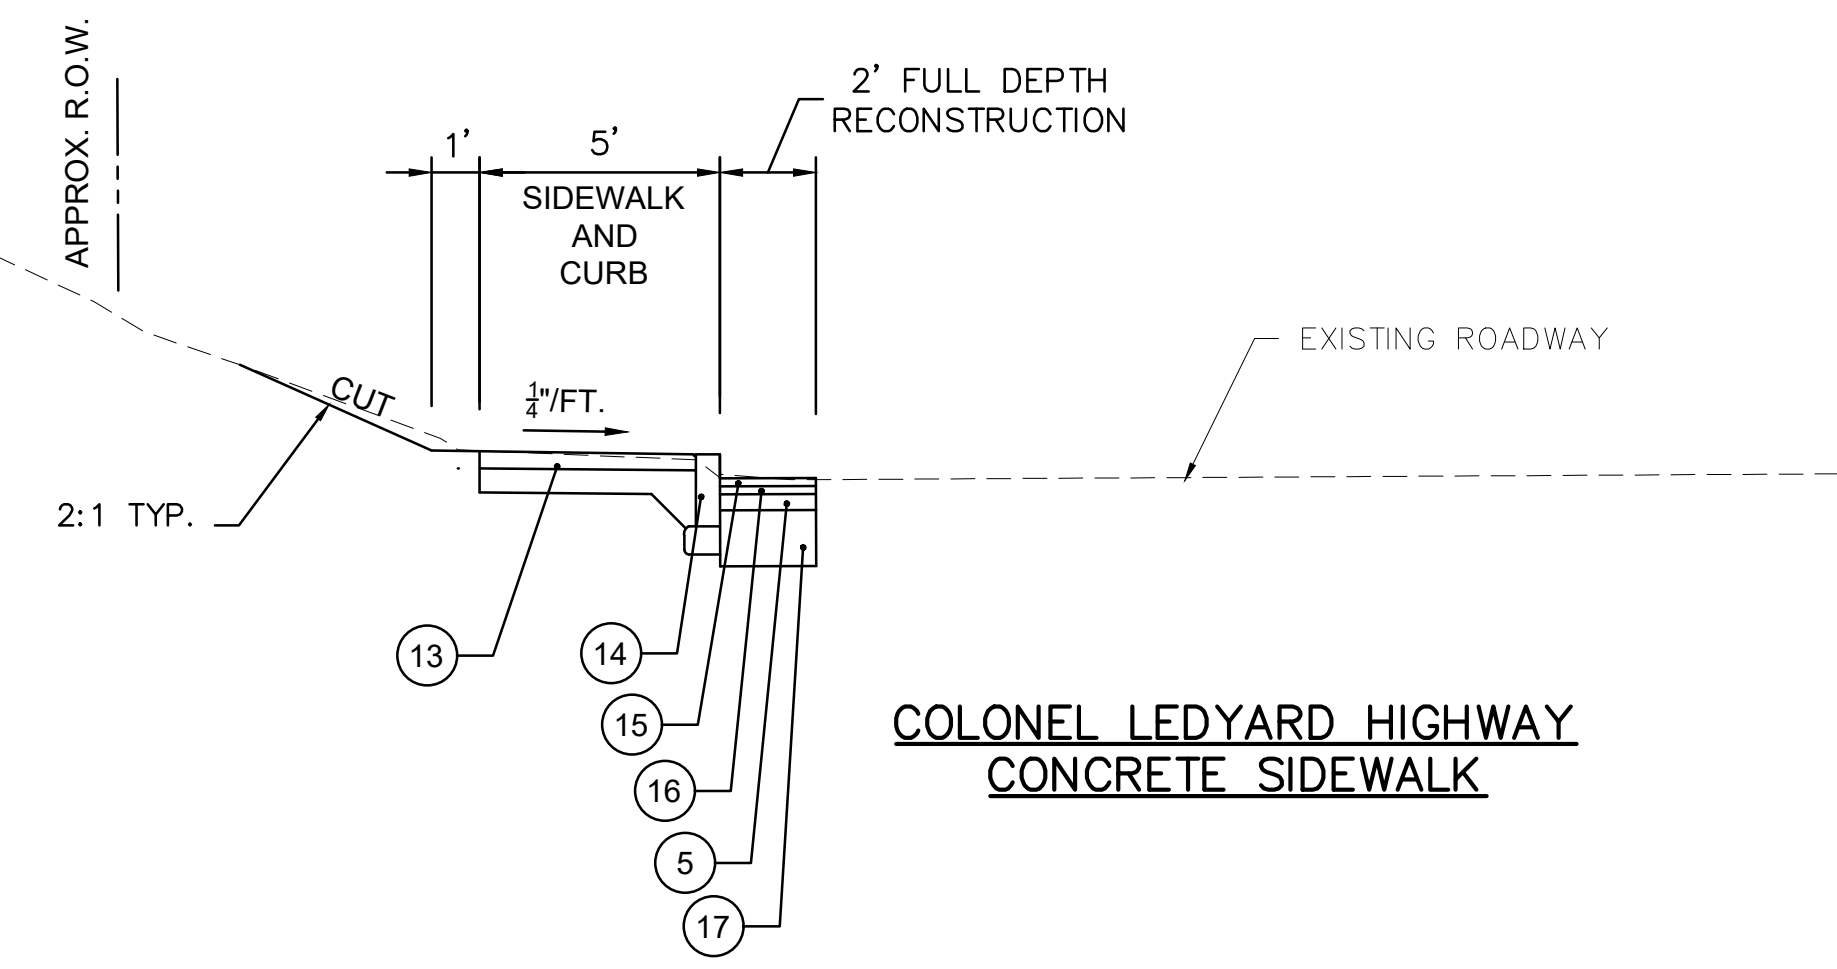

**COLONEL LEDYARD HIGHWAY
CONCRETE SIDEWALK**


START – STA. 11+00
 STA. 12+75 – STA. 13+25
 STA. 17+70 – STA. 20+00
 STA. 22+00 – STA. 24+50
 STA. 31+00 – STA. 37+50
 STA. 40+50 – STA. 42+00
 STA. 45+50 – STA. 47+50
 STA. 61+00 – END

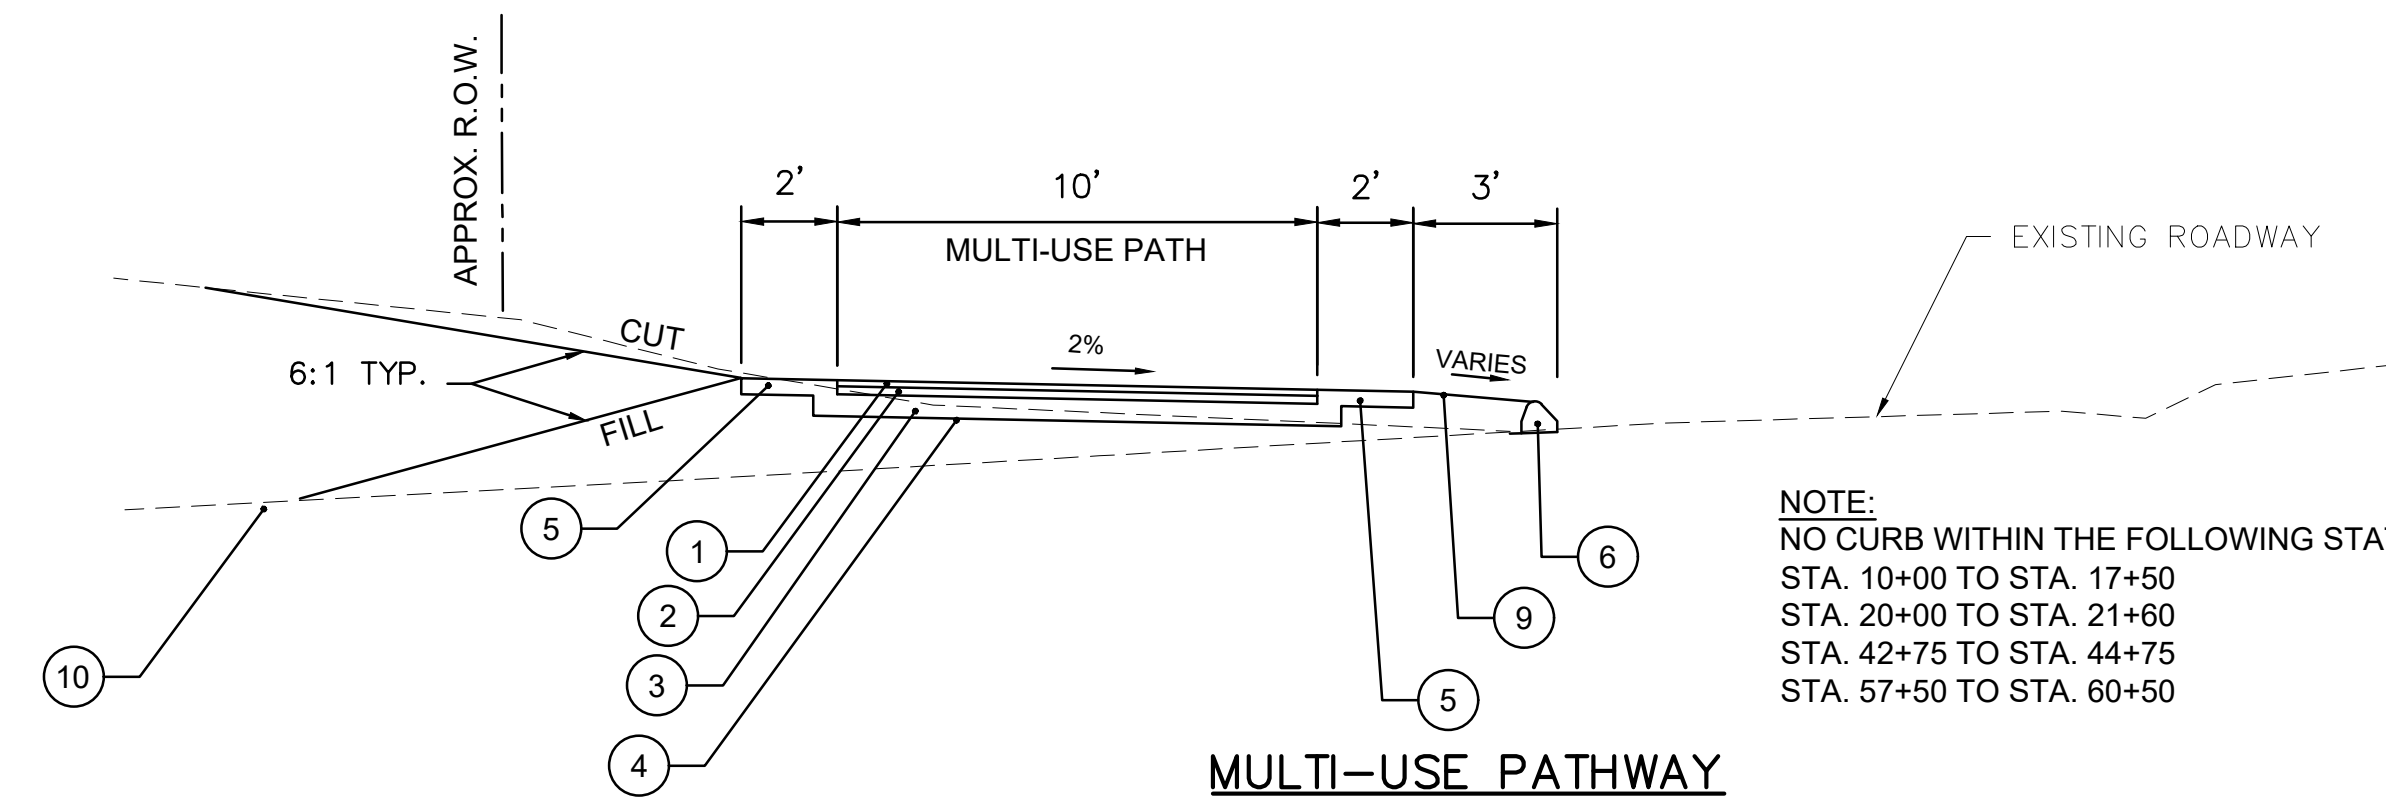

MULTI-USE PATHWAY


NOTE:
 NO CURB WITHIN THE FOLLOWING STATION RANGES -
 STA. 10+00 TO STA. 17+50
 STA. 20+00 TO STA. 21+80
 STA. 42+75 TO STA. 44+75
 STA. 57+50 TO STA. 60+50

STA. 11+50 – STA. 12+50
 STA. 13+50 – STA. 17+50
 STA. 25+00 – STA. 30+50
 STA. 38+00 – STA. 40+00
 STA. 42+50 – STA. 45+00
 STA. 48+00 – STA. 51+65
 STA. 56+50 – STA. 60+50

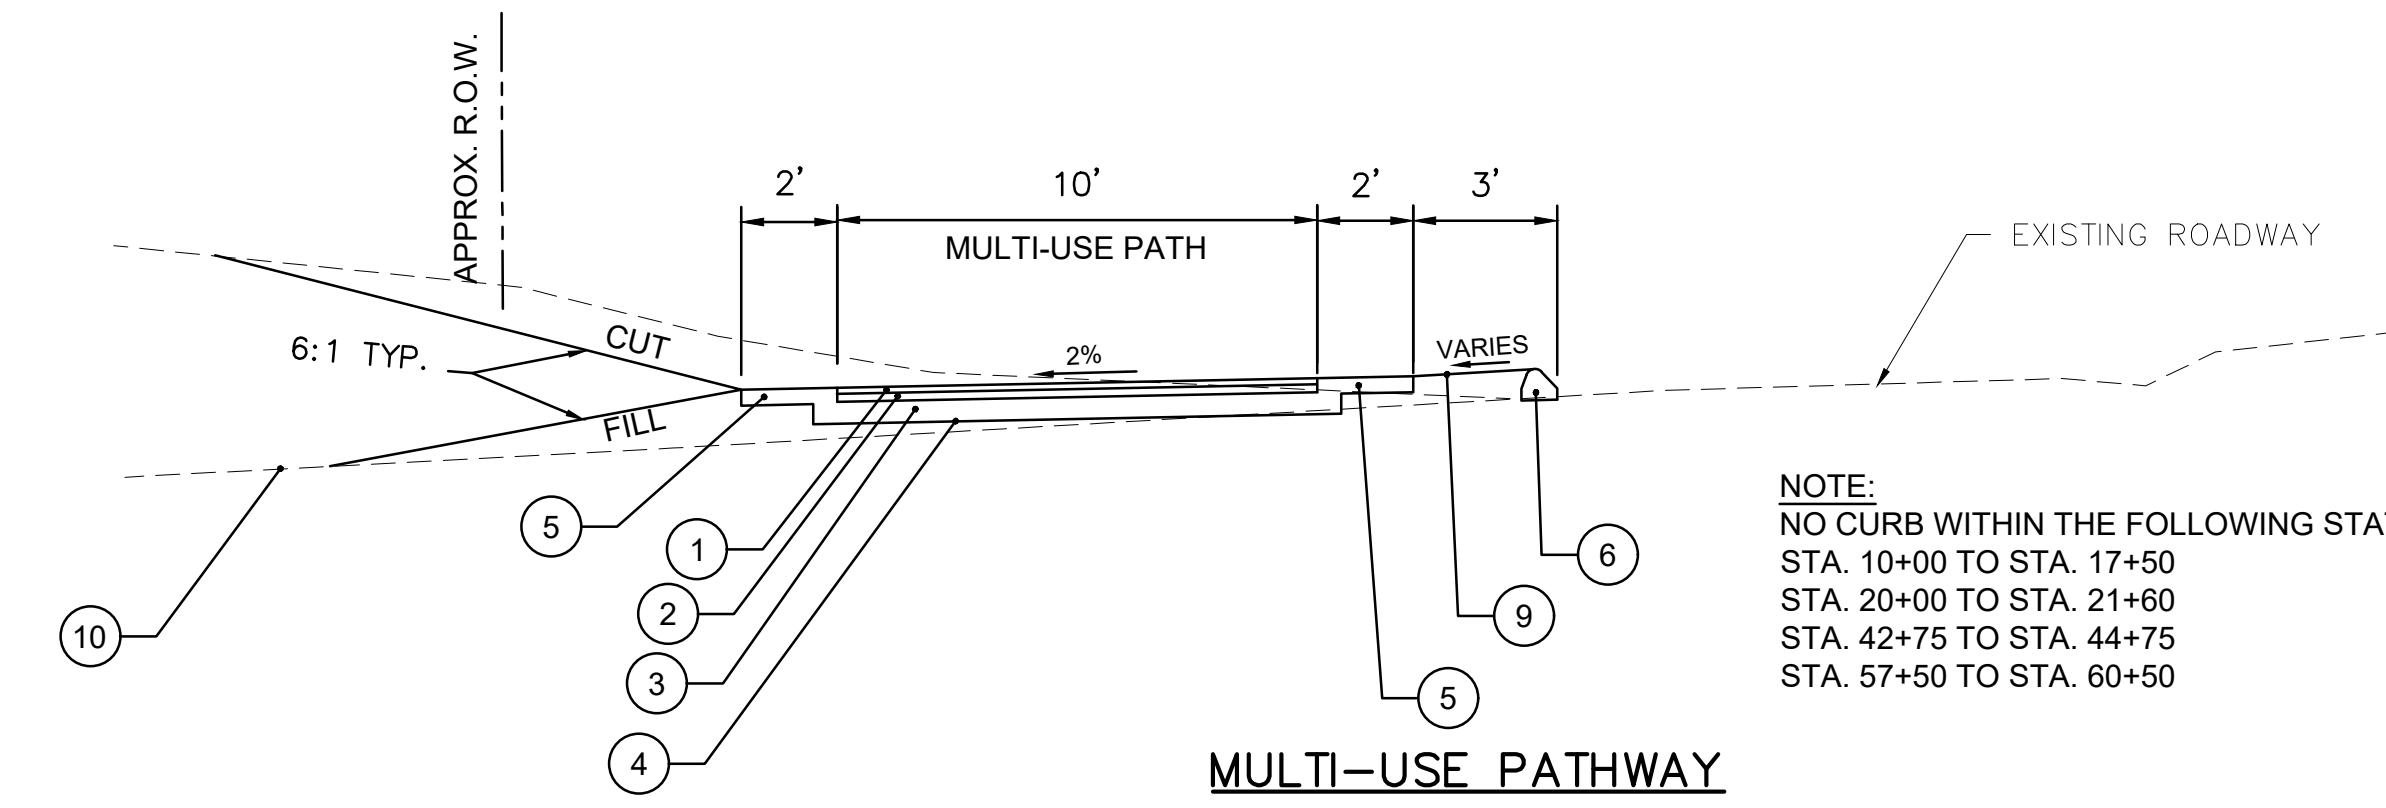


MULTI-USE PATHWAY

NOTE:
 NO CURB WITHIN THE FOLLOWING STATION RANGES -
 STA. 10+00 TO STA. 17+50
 STA. 20+00 TO STA. 21+80
 STA. 42+75 TO STA. 44+75
 STA. 57+50 TO STA. 60+50

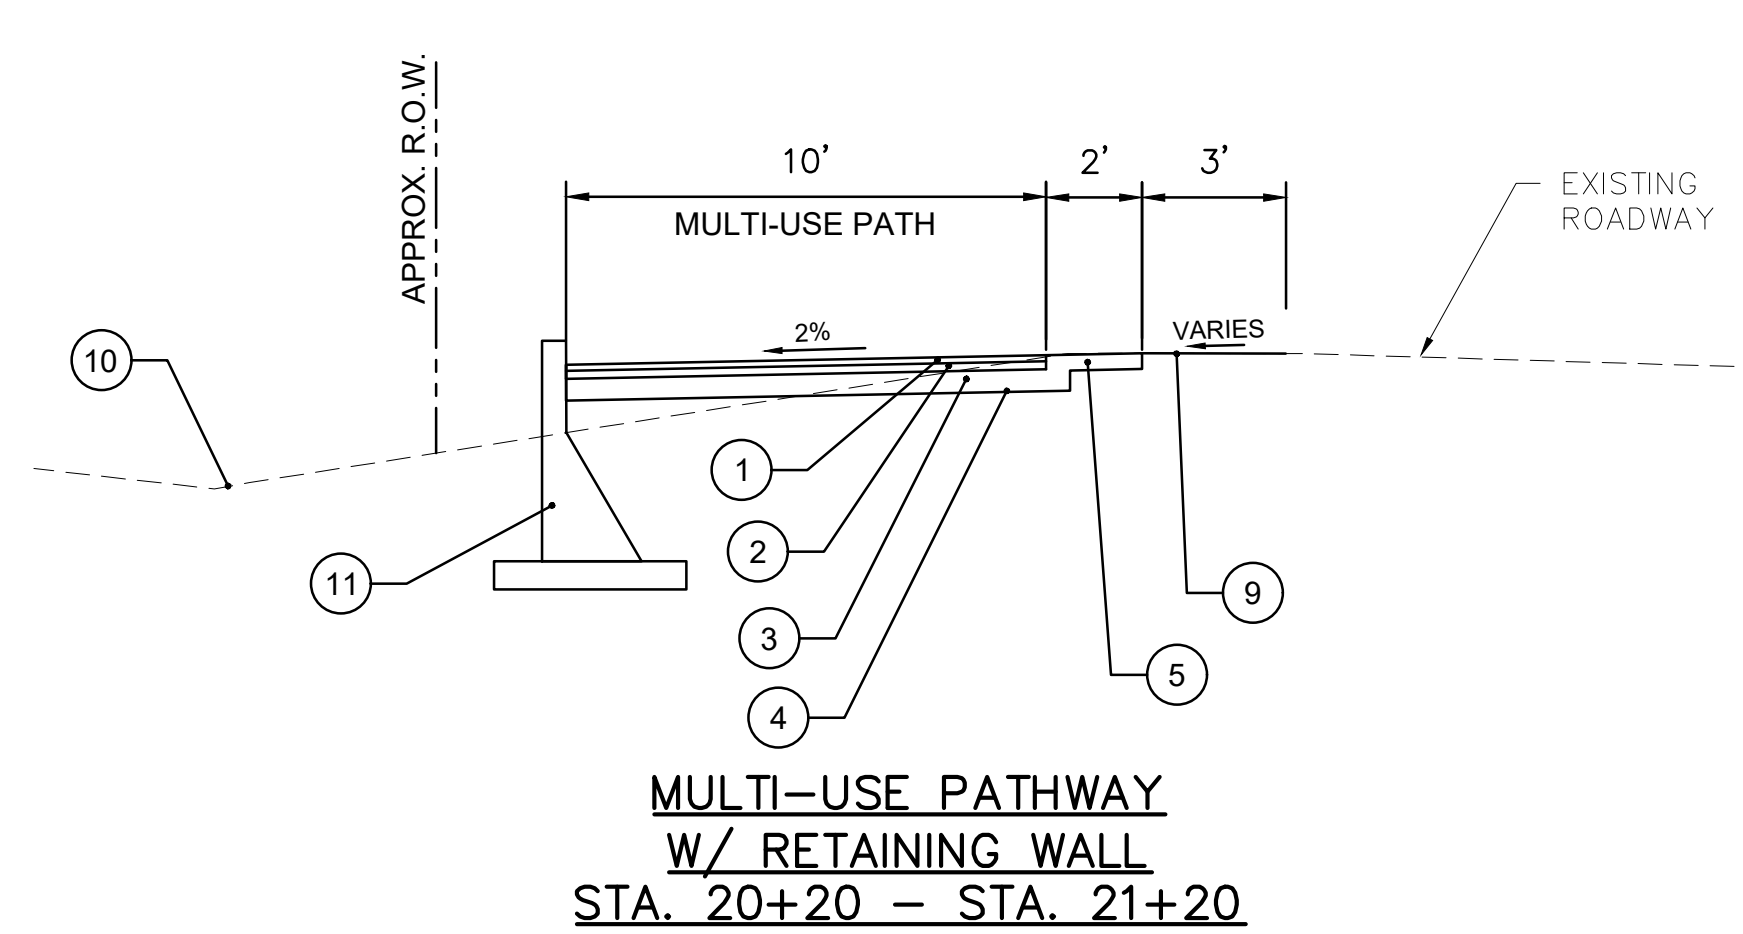


**MULTI-USE PATHWAY
W/ RETAINING WALL
STA. 20+20 – STA. 21+20**

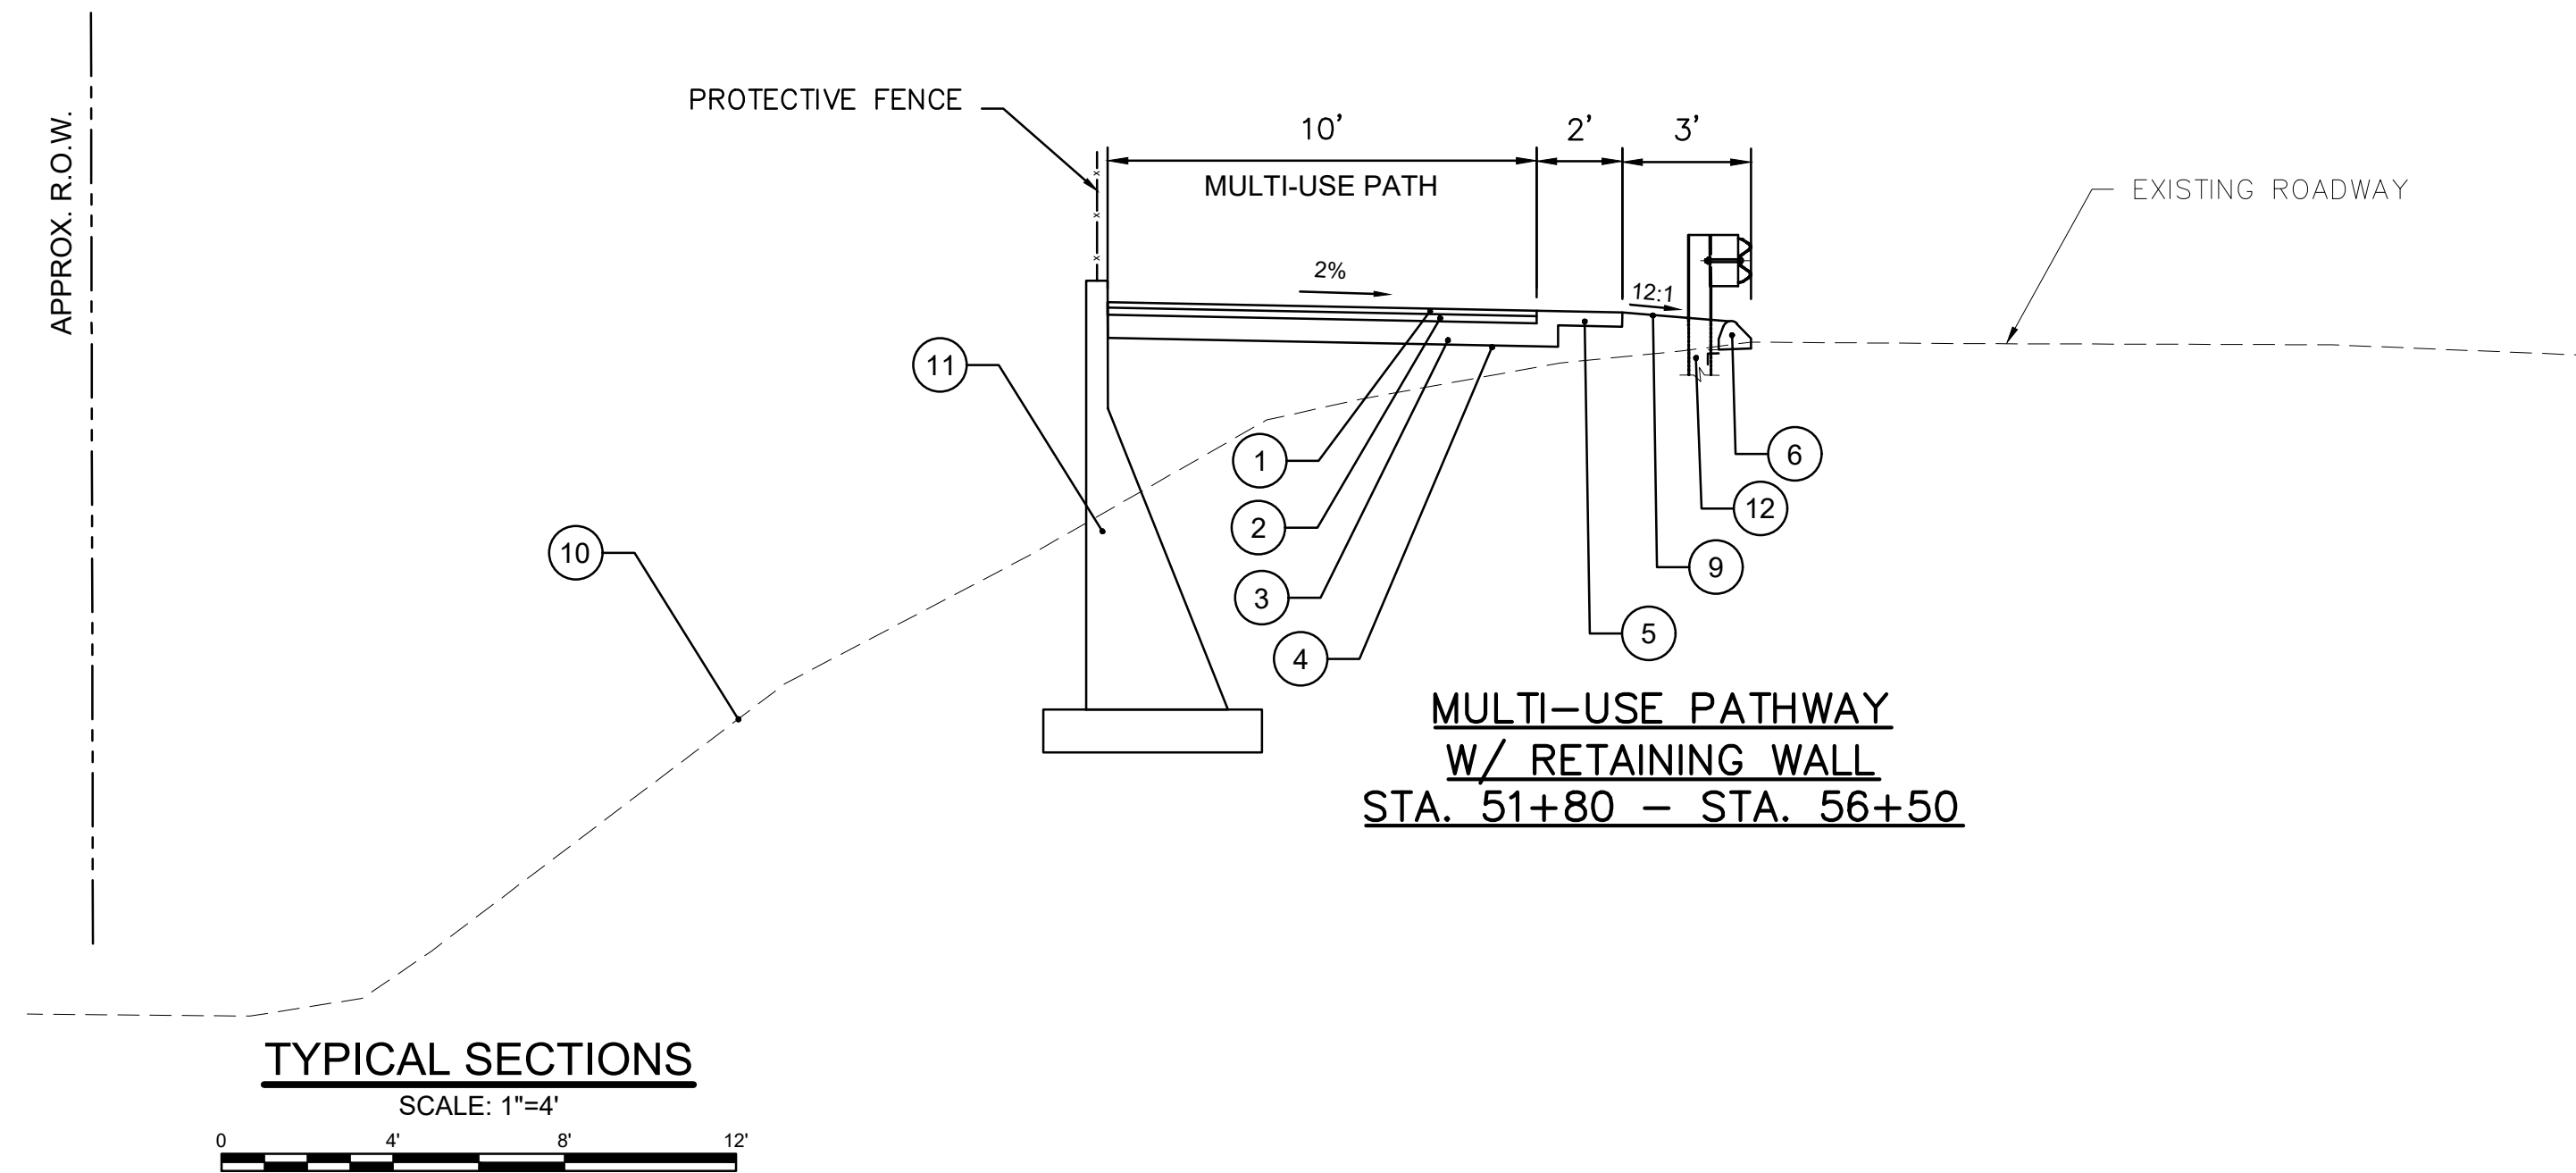

**MULTI-USE PATHWAY
W/ RETAINING WALL
STA. 51+80 – STA. 56+50**

TYPICAL SECTIONS
 SCALE: 1"=4'

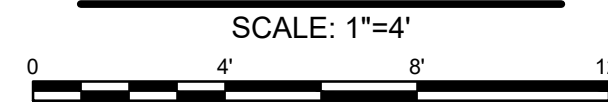

LEGEND

- ① - 1.5" HMA S0.375
- ② - 2" HMA S0.5
- ③ - 6" PROCESSED AGGREGATE BASE
- ④ - COMPACTED SUBGRADE
- ⑤ - 4" PROCESSED AGGREGATE BASE
- ⑥ - 6" BITUMINOUS CONCRETE LIP CURBING
- ⑦ - 6" CONCRETE CURBING
- ⑧ - CONCRETE SIDEWALK
- ⑨ - 4" TOPSOIL AND TURF ESTABLISHMENT
- ⑩ - EXISTING GRADE
- ⑪ - RETAINING WALL
- ⑫ - METAL BEAM RAIL (R-B MASH)
- ⑬ - CONCRETE SIDEWALK
- ⑭ - CONCRETE CURB
- ⑮ - 2" HMA S0.375
- ⑯ - 2" HMA S0.5
- ⑰ - 14" SUBBASE

NOTES:
 1. ALL CUT OR FILL SLOPES TO BE 2:1 MAX, UNLESS OTHERWISE NOTED ON THE CROSS SECTIONS OR APPROVED BY THE ENGINEER
 2. CONTRACTOR TO TRANSITION CROSS SLOPE OF MULTI-USE PATHWAY AS NEEDED BETWEEN THE SPECIFIED STATION RANGES

Project:
 TOWN OF LEDYARD, CT

LEDYARD HIGH SCHOOL
 MULTI-USE PATHWAY &
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 W&S File No.:

Drawing Title:
MULTI-USE PATHWAY AND SIDEWALK TYPICAL SECTIONS

Sheet Number:
TYP-01



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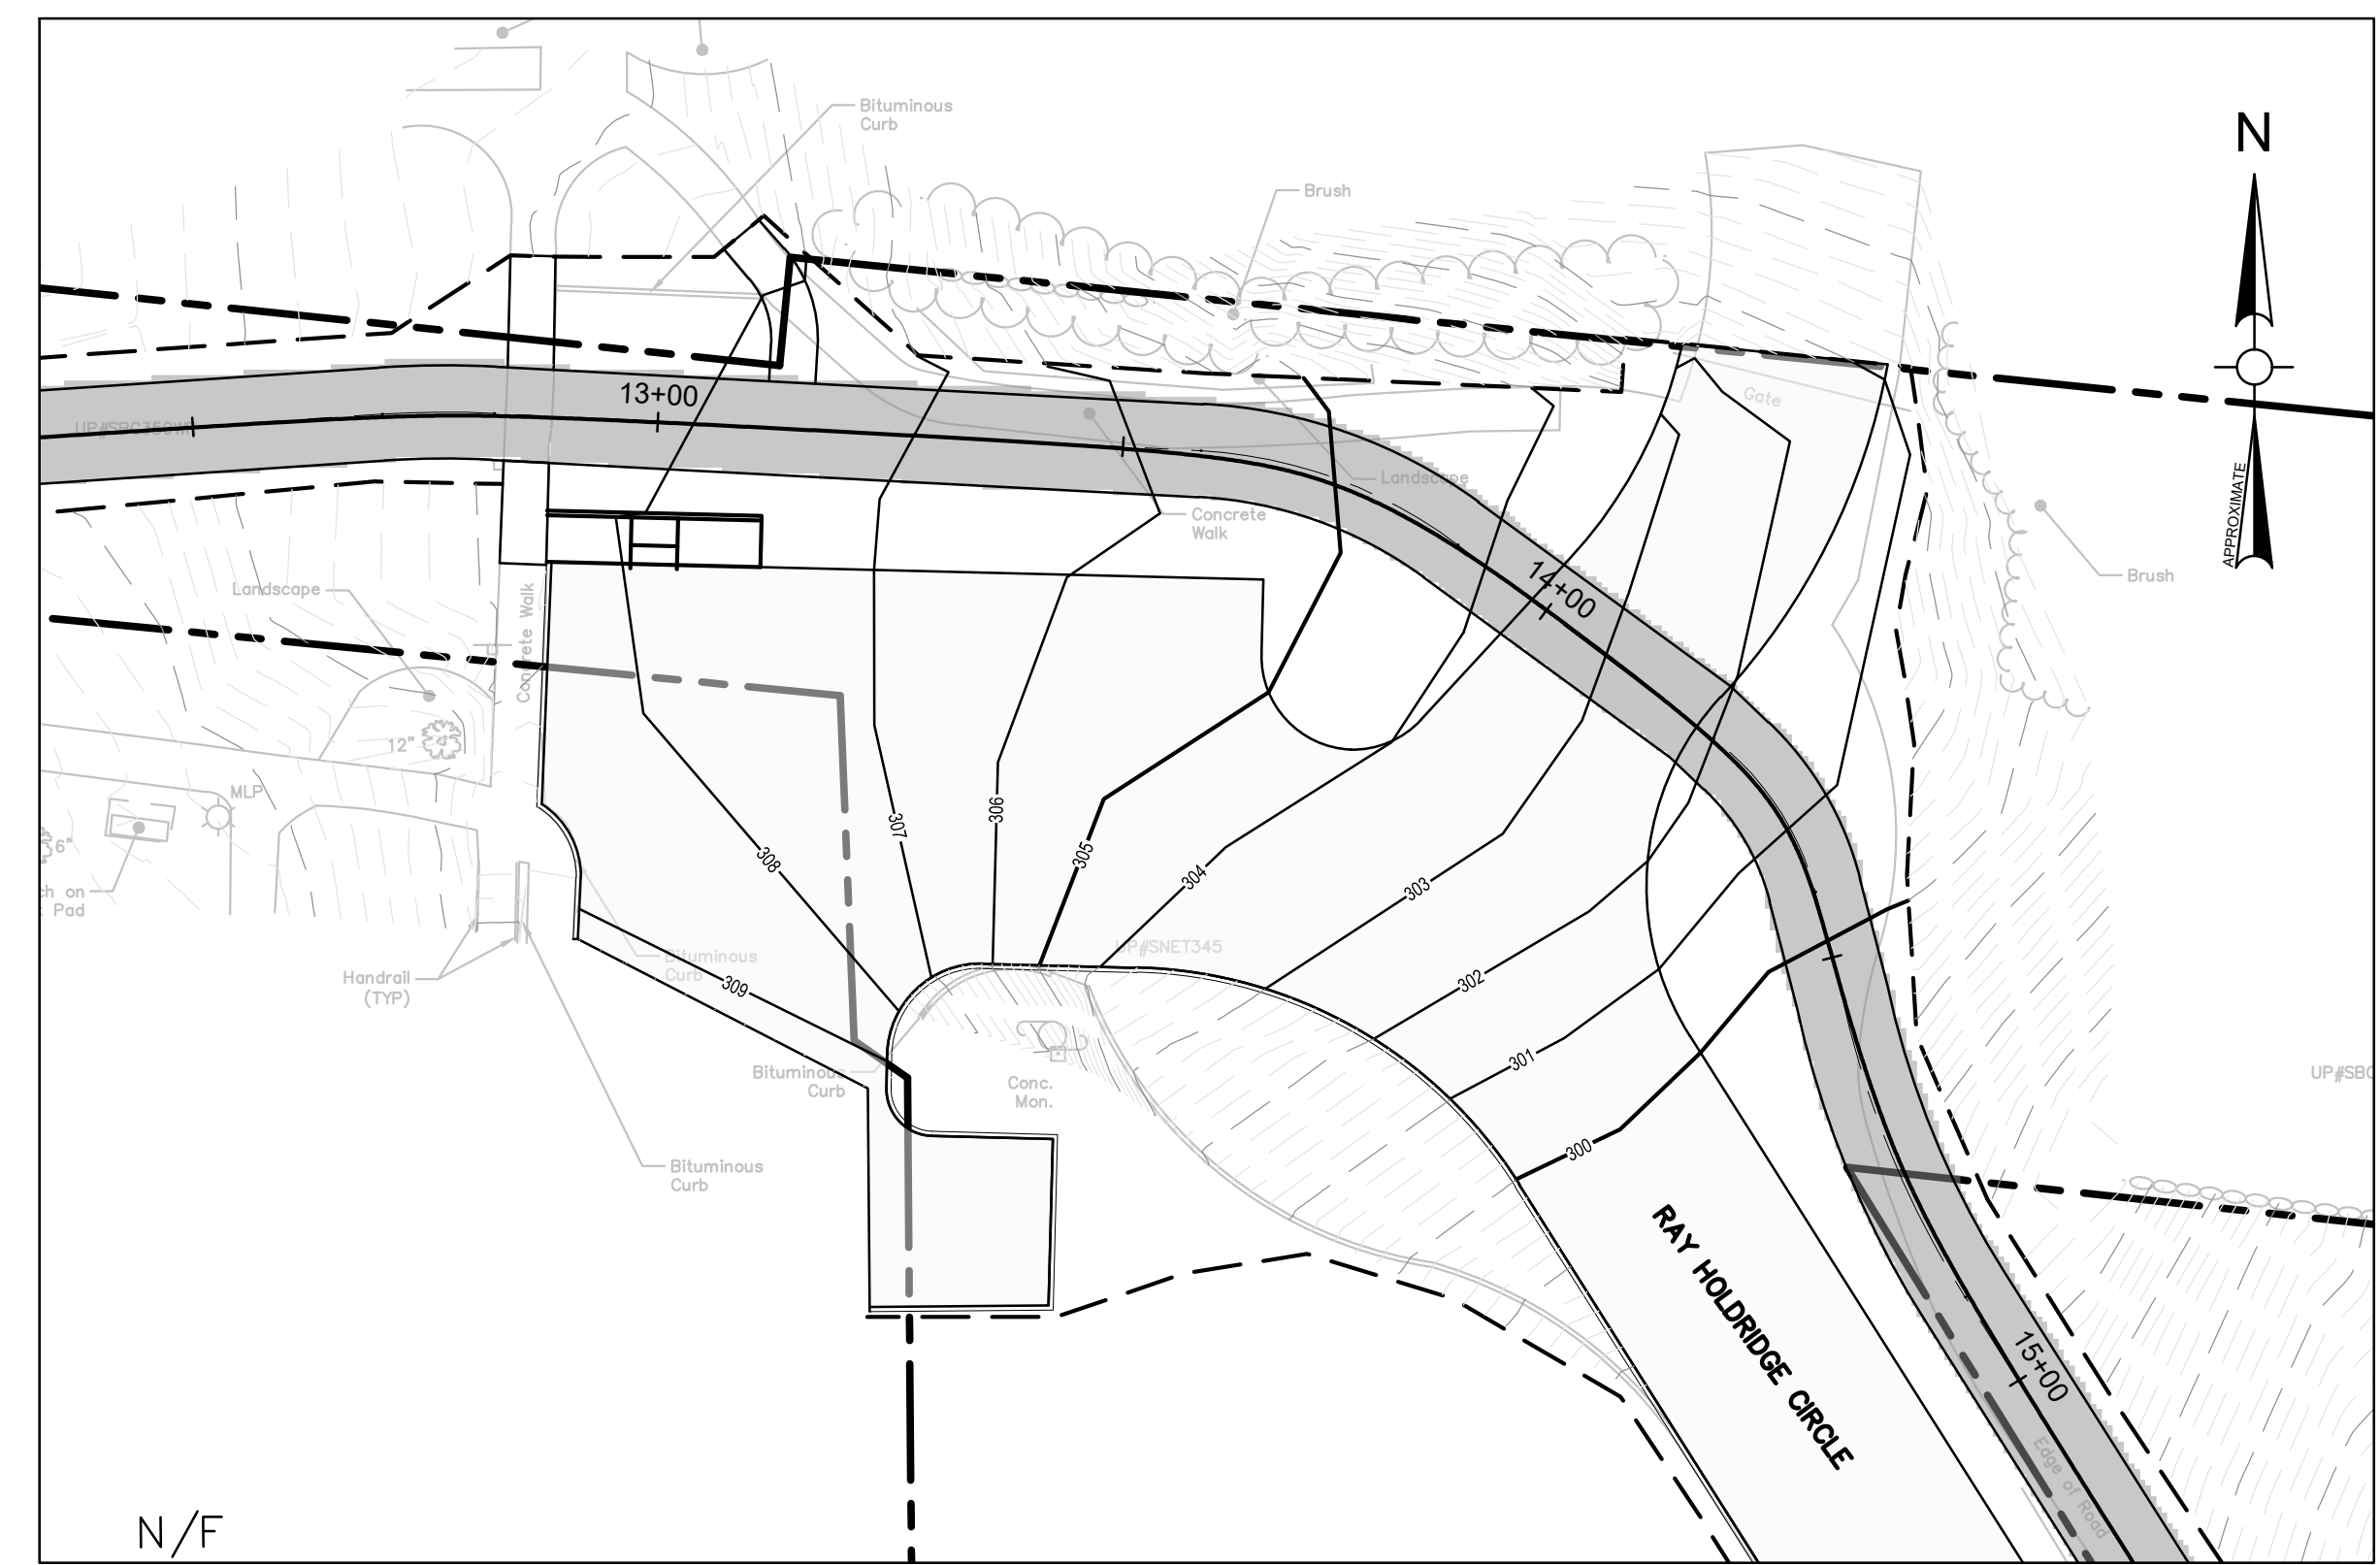
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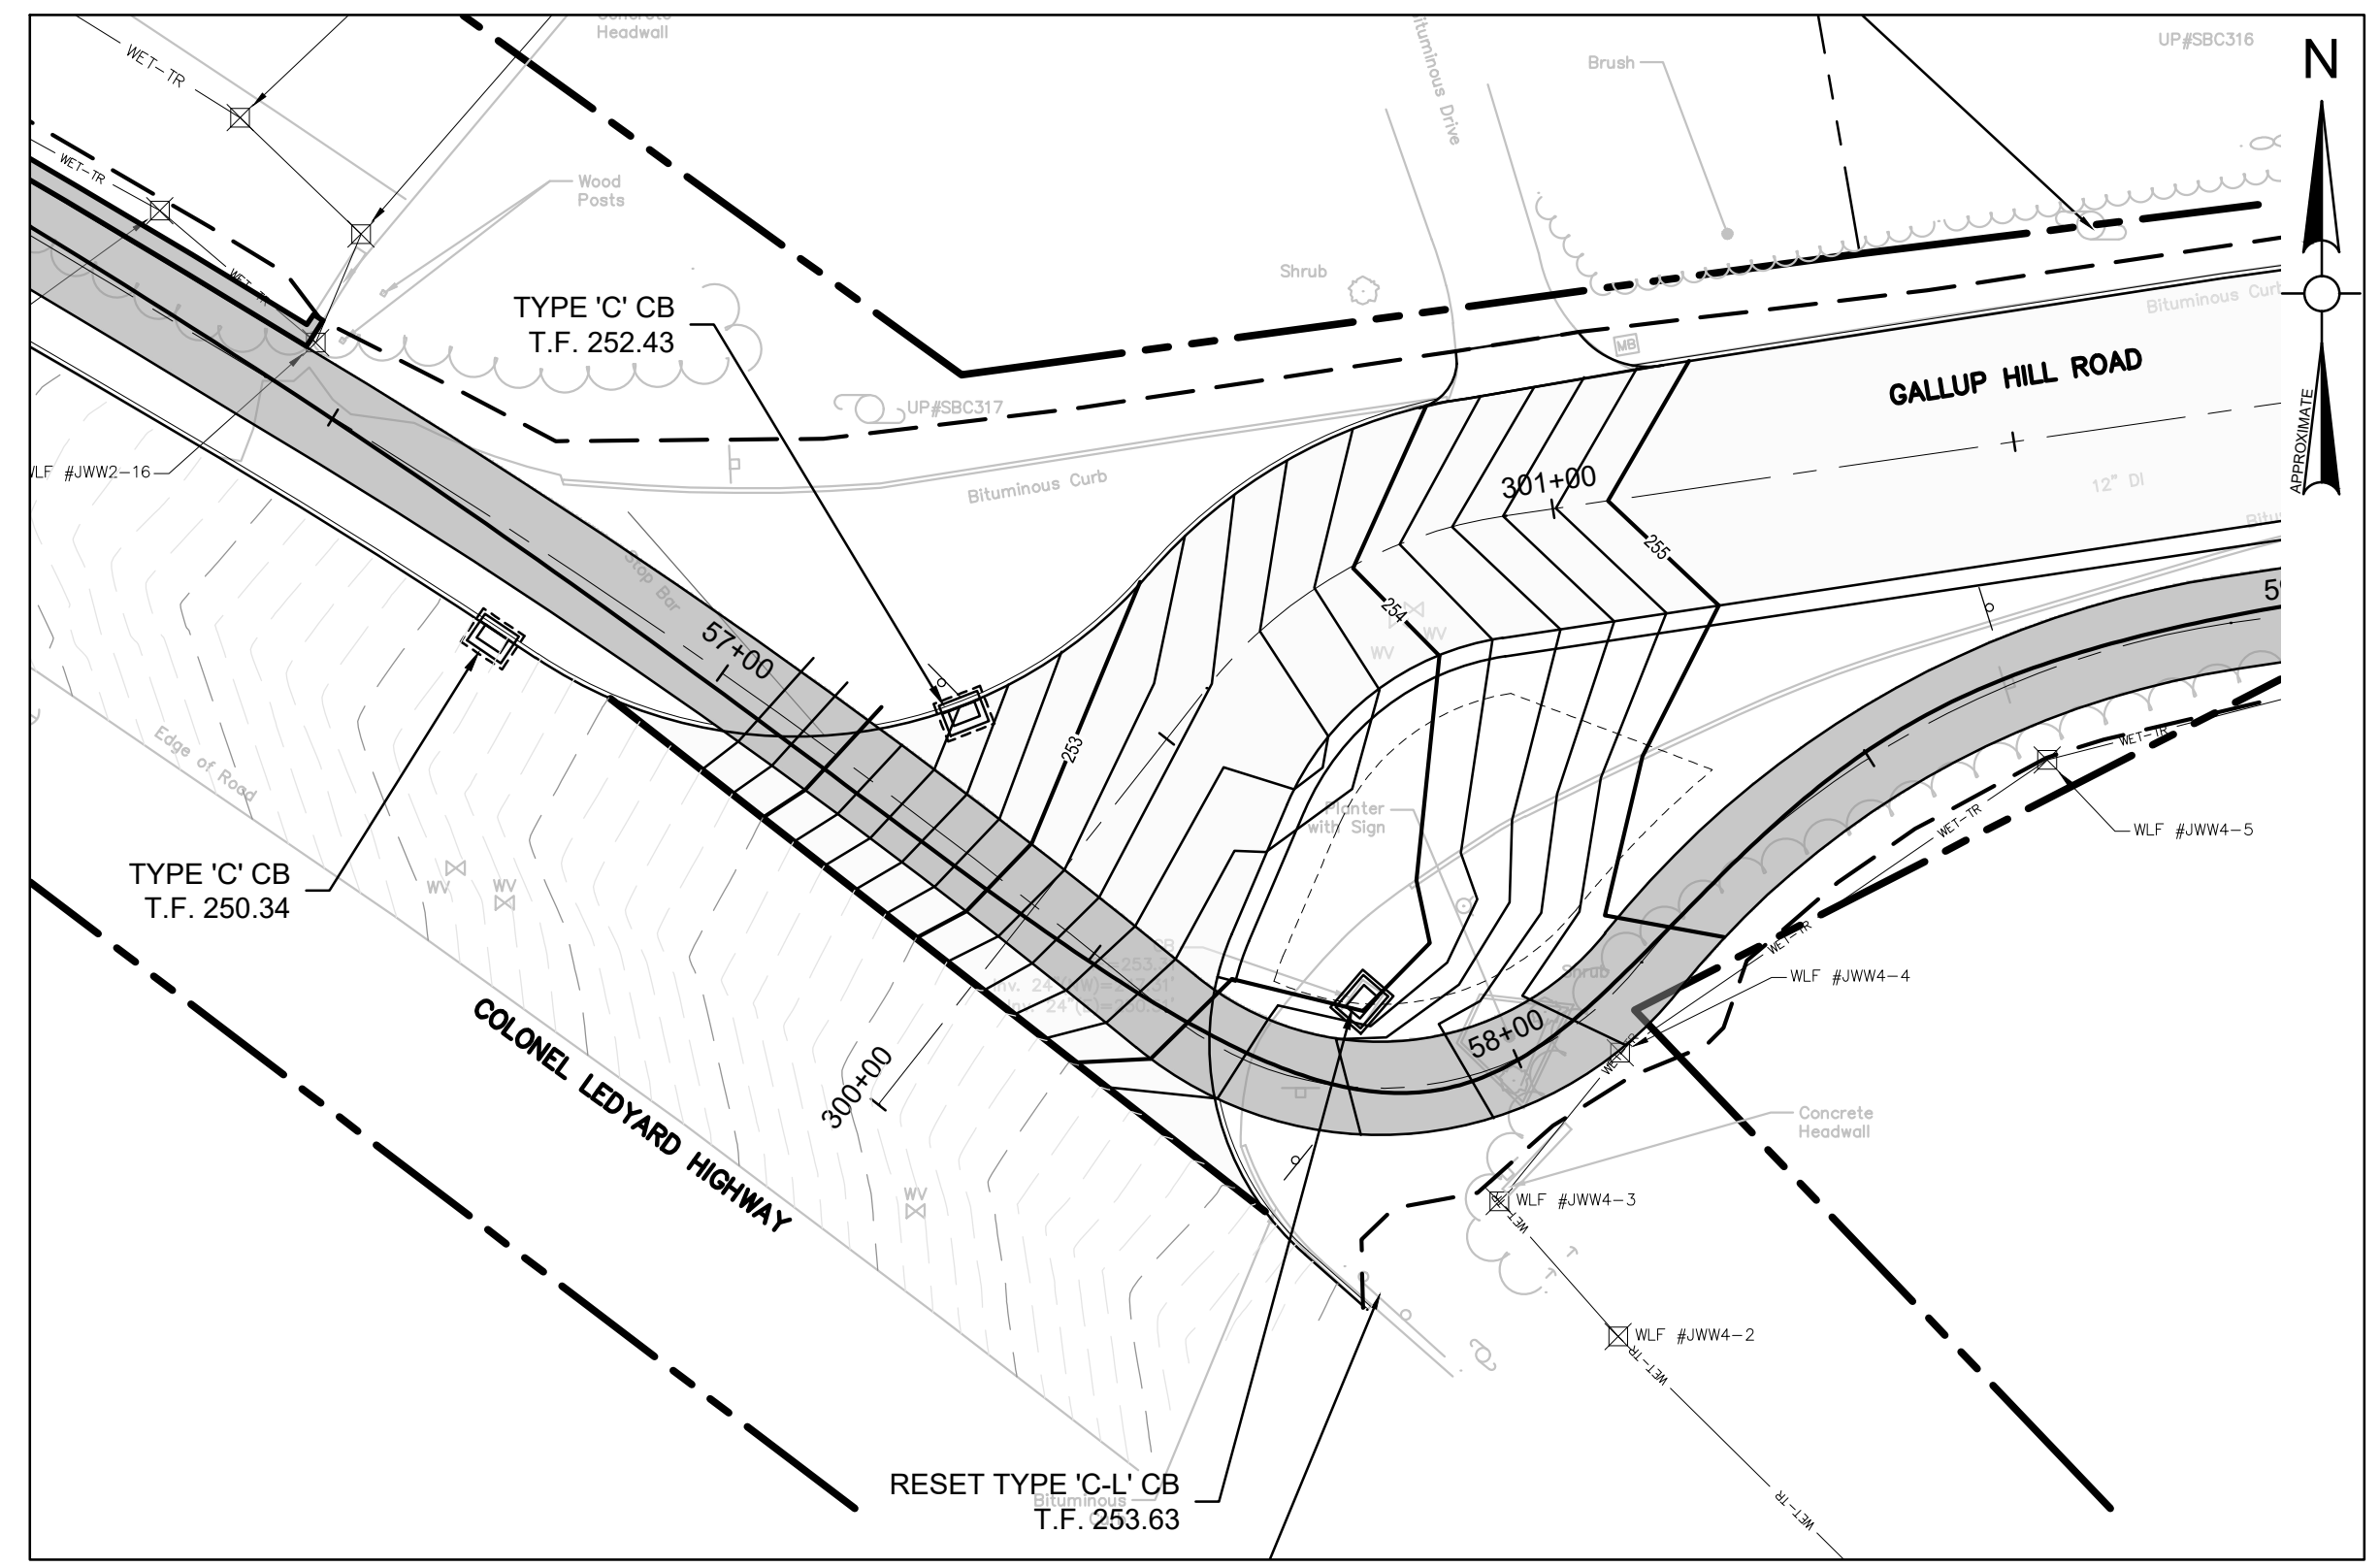
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Drawn By: JWG
Reviewed By: RC
Approved By: LAS
W&S Project No.: ENG20-1119
W&S File No.:

Drawing Title:
**INTERSECTION
GRADING PLANS
RAY HOLDRIDGE CIR
GALLUP HILL RD**


Sheet Number:
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
PLAN
SCALE: 1"=20'
0 20' 40' 60'
RAY HOLDRIDGE CIRCLE



PLAN
SCALE: 1"=20'
0 20' 40' 60'
GALLUP HILL ROAD



Project:
TOWN OF LEDYARD, CT

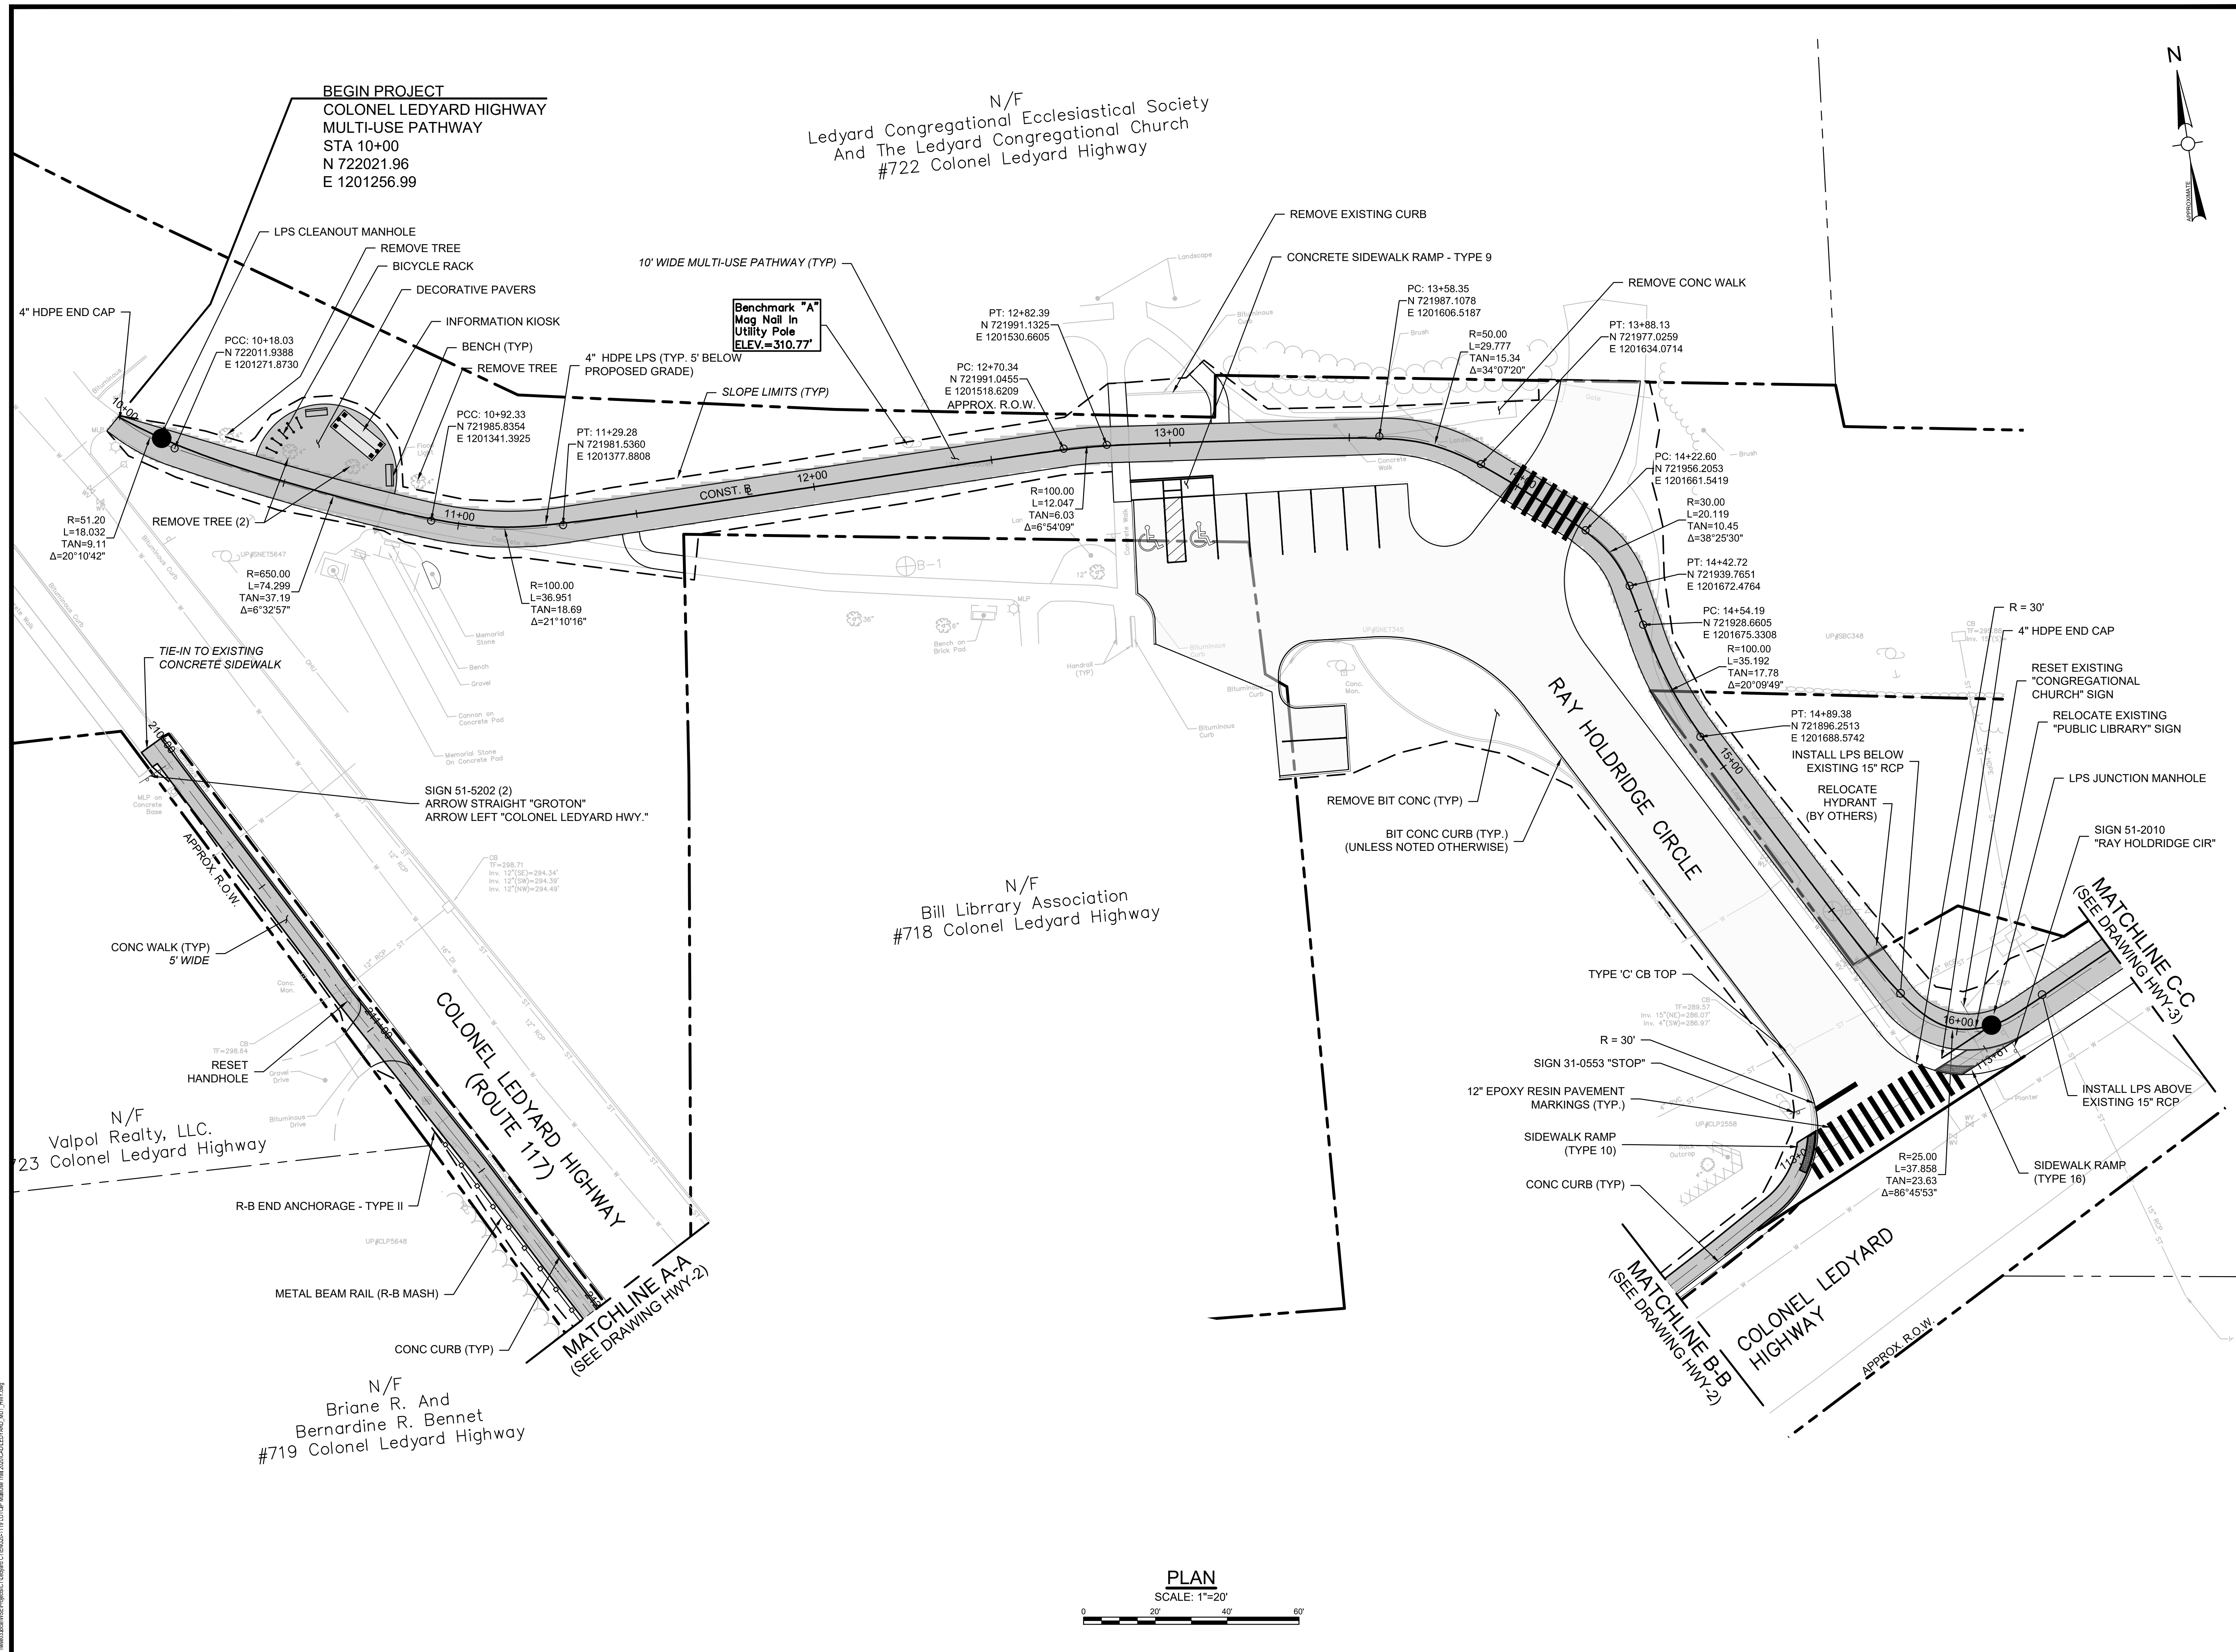

LEDYARD HIGH SCHOOL
MULTI-USE PATHWAY &
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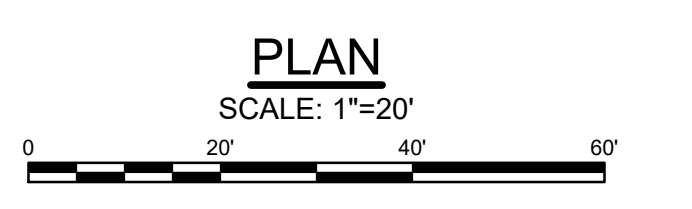
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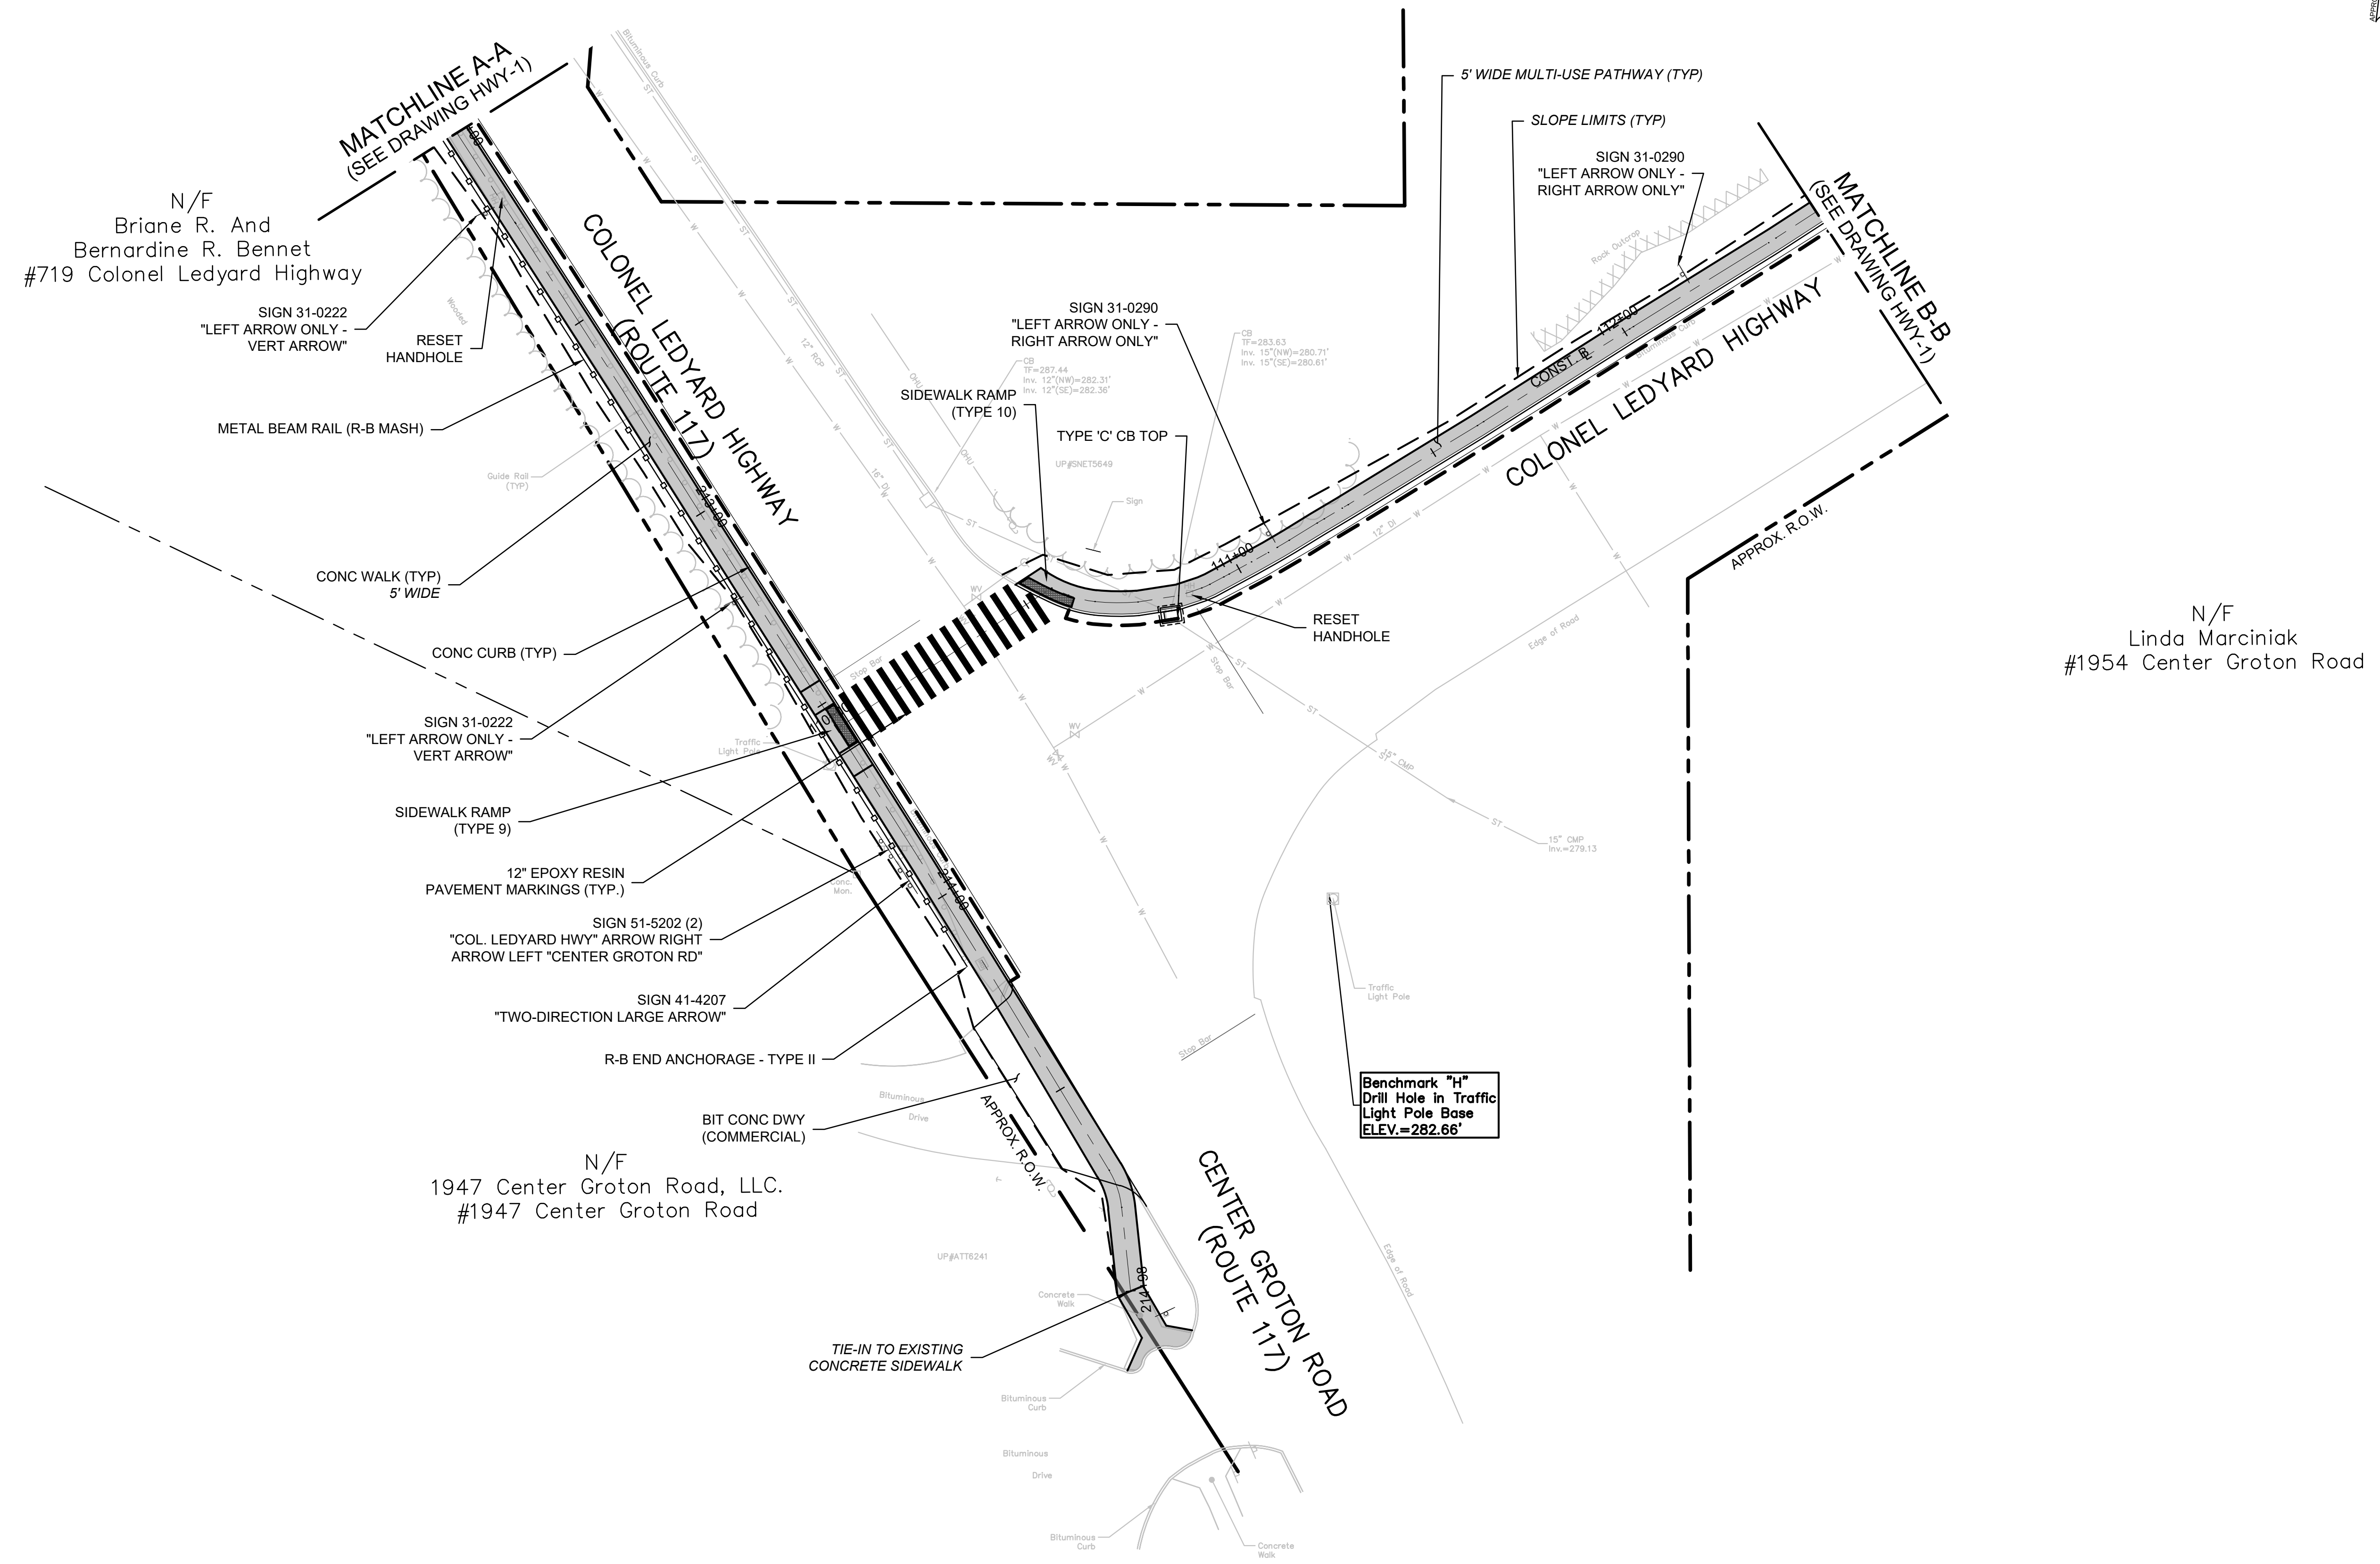
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Reviewed By: RC
Approved By: LAS
W&S Project No.: ENG20-1119
W&S File No.:

Drawing Title:
**MULTI-USE PATHWAY
& SIDEWALK PLAN
STA. 10+00 TO 16+50**

Sheet Number:
HWY-1




Rev. 1.6 Date: 04/10/2019



PLAN
SCALE: 1"=20'

Project:
TOWN OF LEDYARD, CT



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W&S File No.:

Drawing Title:
**MULTI-USE PATHWAY
& SIDEWALK PLAN**
STA. 211+50 TO 214+96
STA. 110+00 TO 112+50

Sheet Number:
HWY-2

\\w01\Bor\W&S\Projects\LEDYARD\CT\ENG20-1119\UTOP\Main\DWG\2022\LEDYARD_MU_HWY-2.dwg

Rev: 1.6 Date: 04/10/2019

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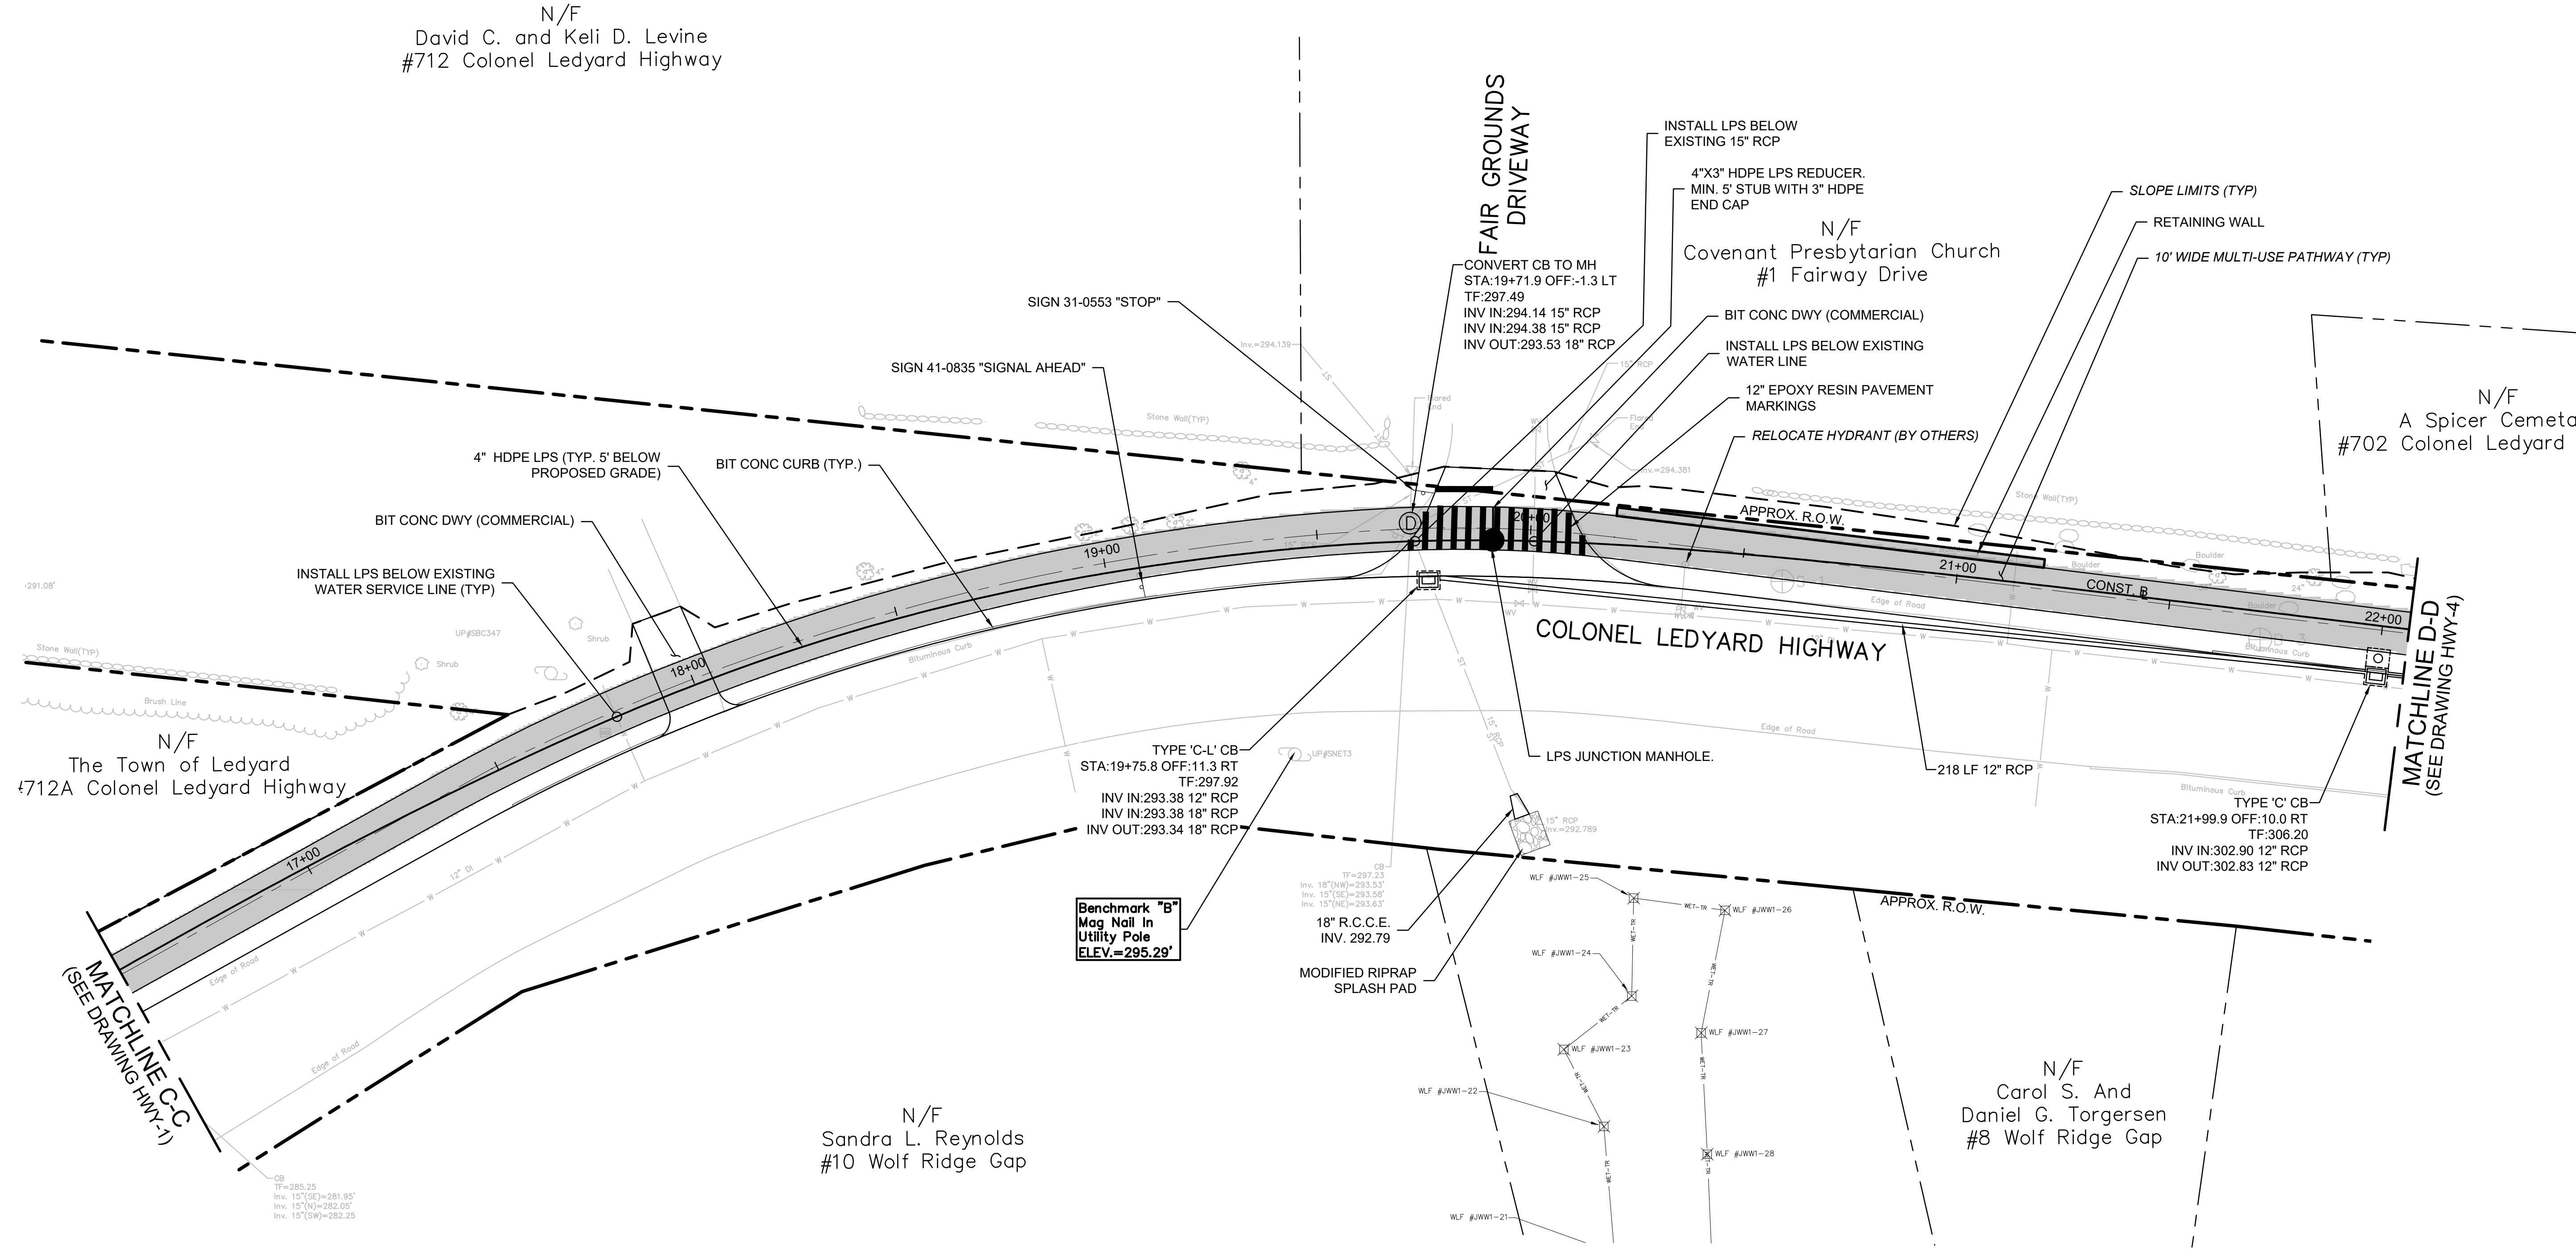
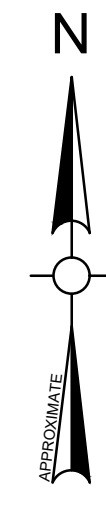
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Drawing Title:

**MULTI-USE PATHWAY
& SIDEWALK PLAN
STA. 16+50 TO 22+00**

Sheet Number:

HWY-3




N/F
David C. and Keli D. Levine
#712 Colonel Ledyard Highway

N/F
The Town of Ledyard
#712A Colonel Ledyard Highway

N/F
Sandra L. Reynolds
#10 Wolf Ridge Gap

N/F
Carol S. And
Daniel G. Torgersen
#8 Wolf Ridge Gap

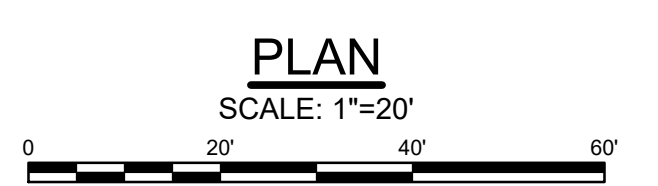

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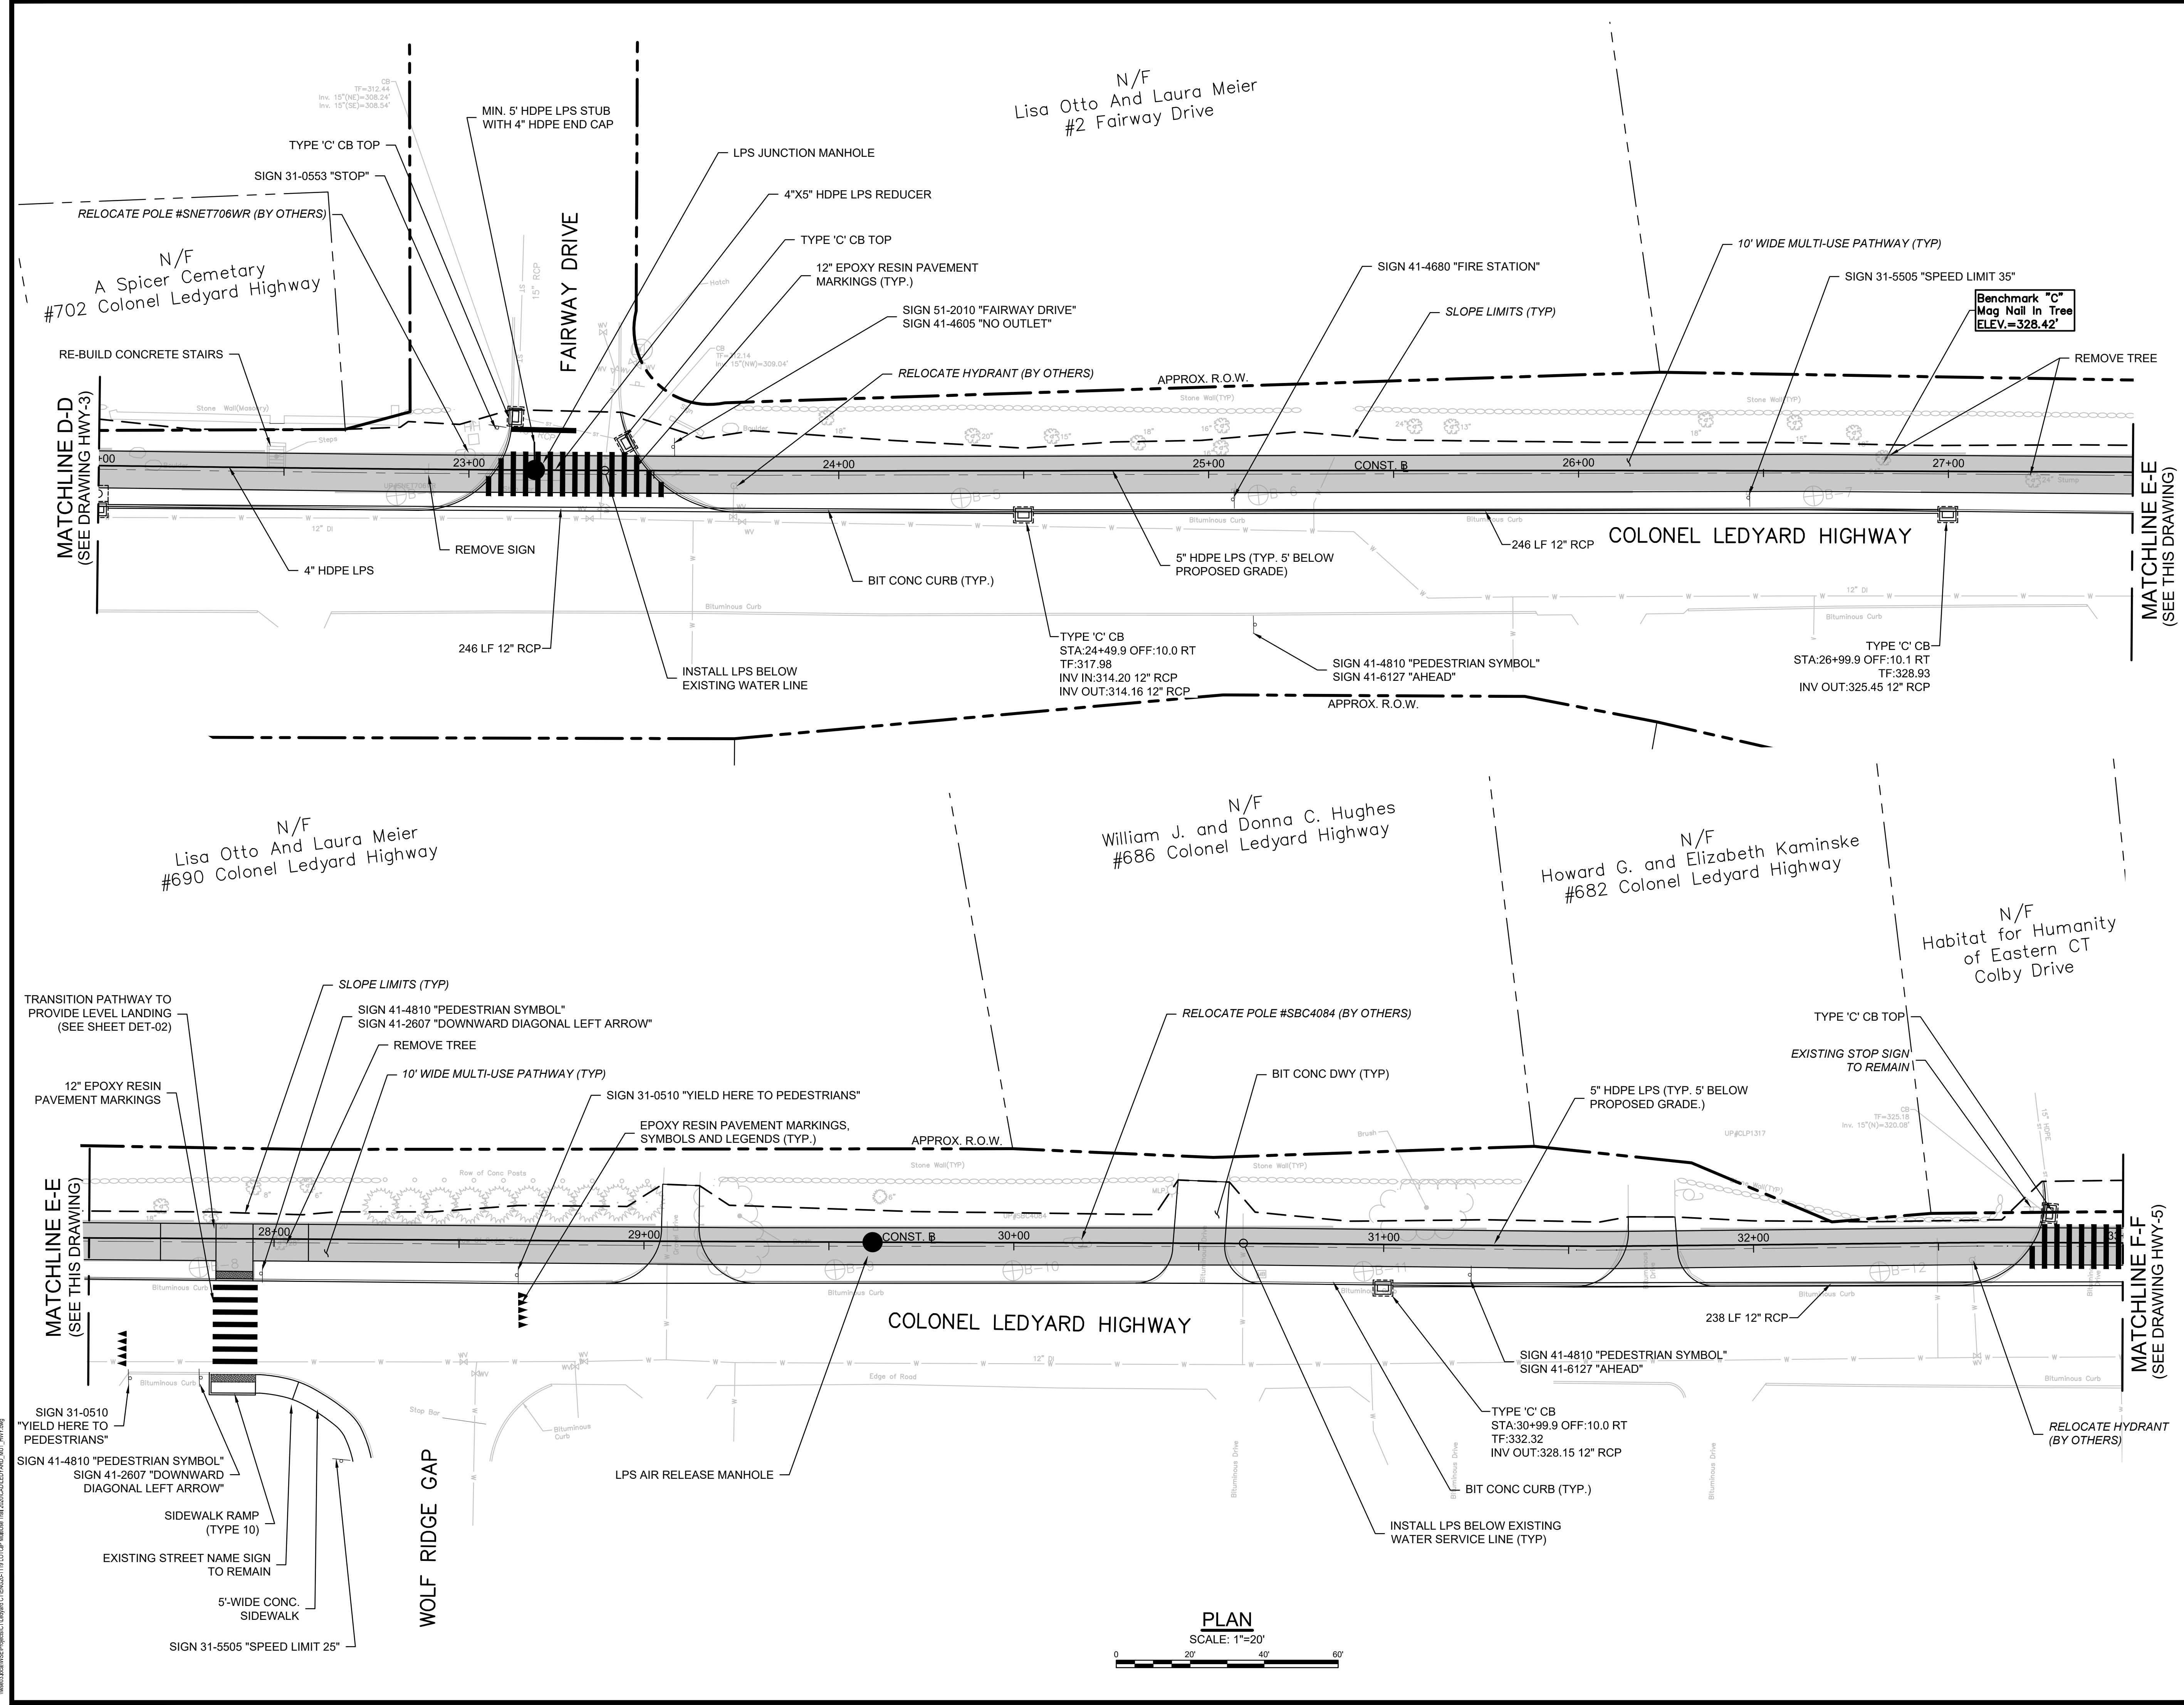
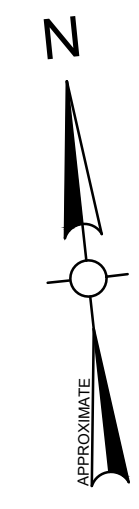
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Approved By: LAS
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W&S File No.:

Drawing Title:
MULTI-USE PATHWAY & SIDEWALK PLAN
STA. 22+00 TO 33+00
Sheet Number:
HWY-4



PLAN
SCALE: 1"=20'

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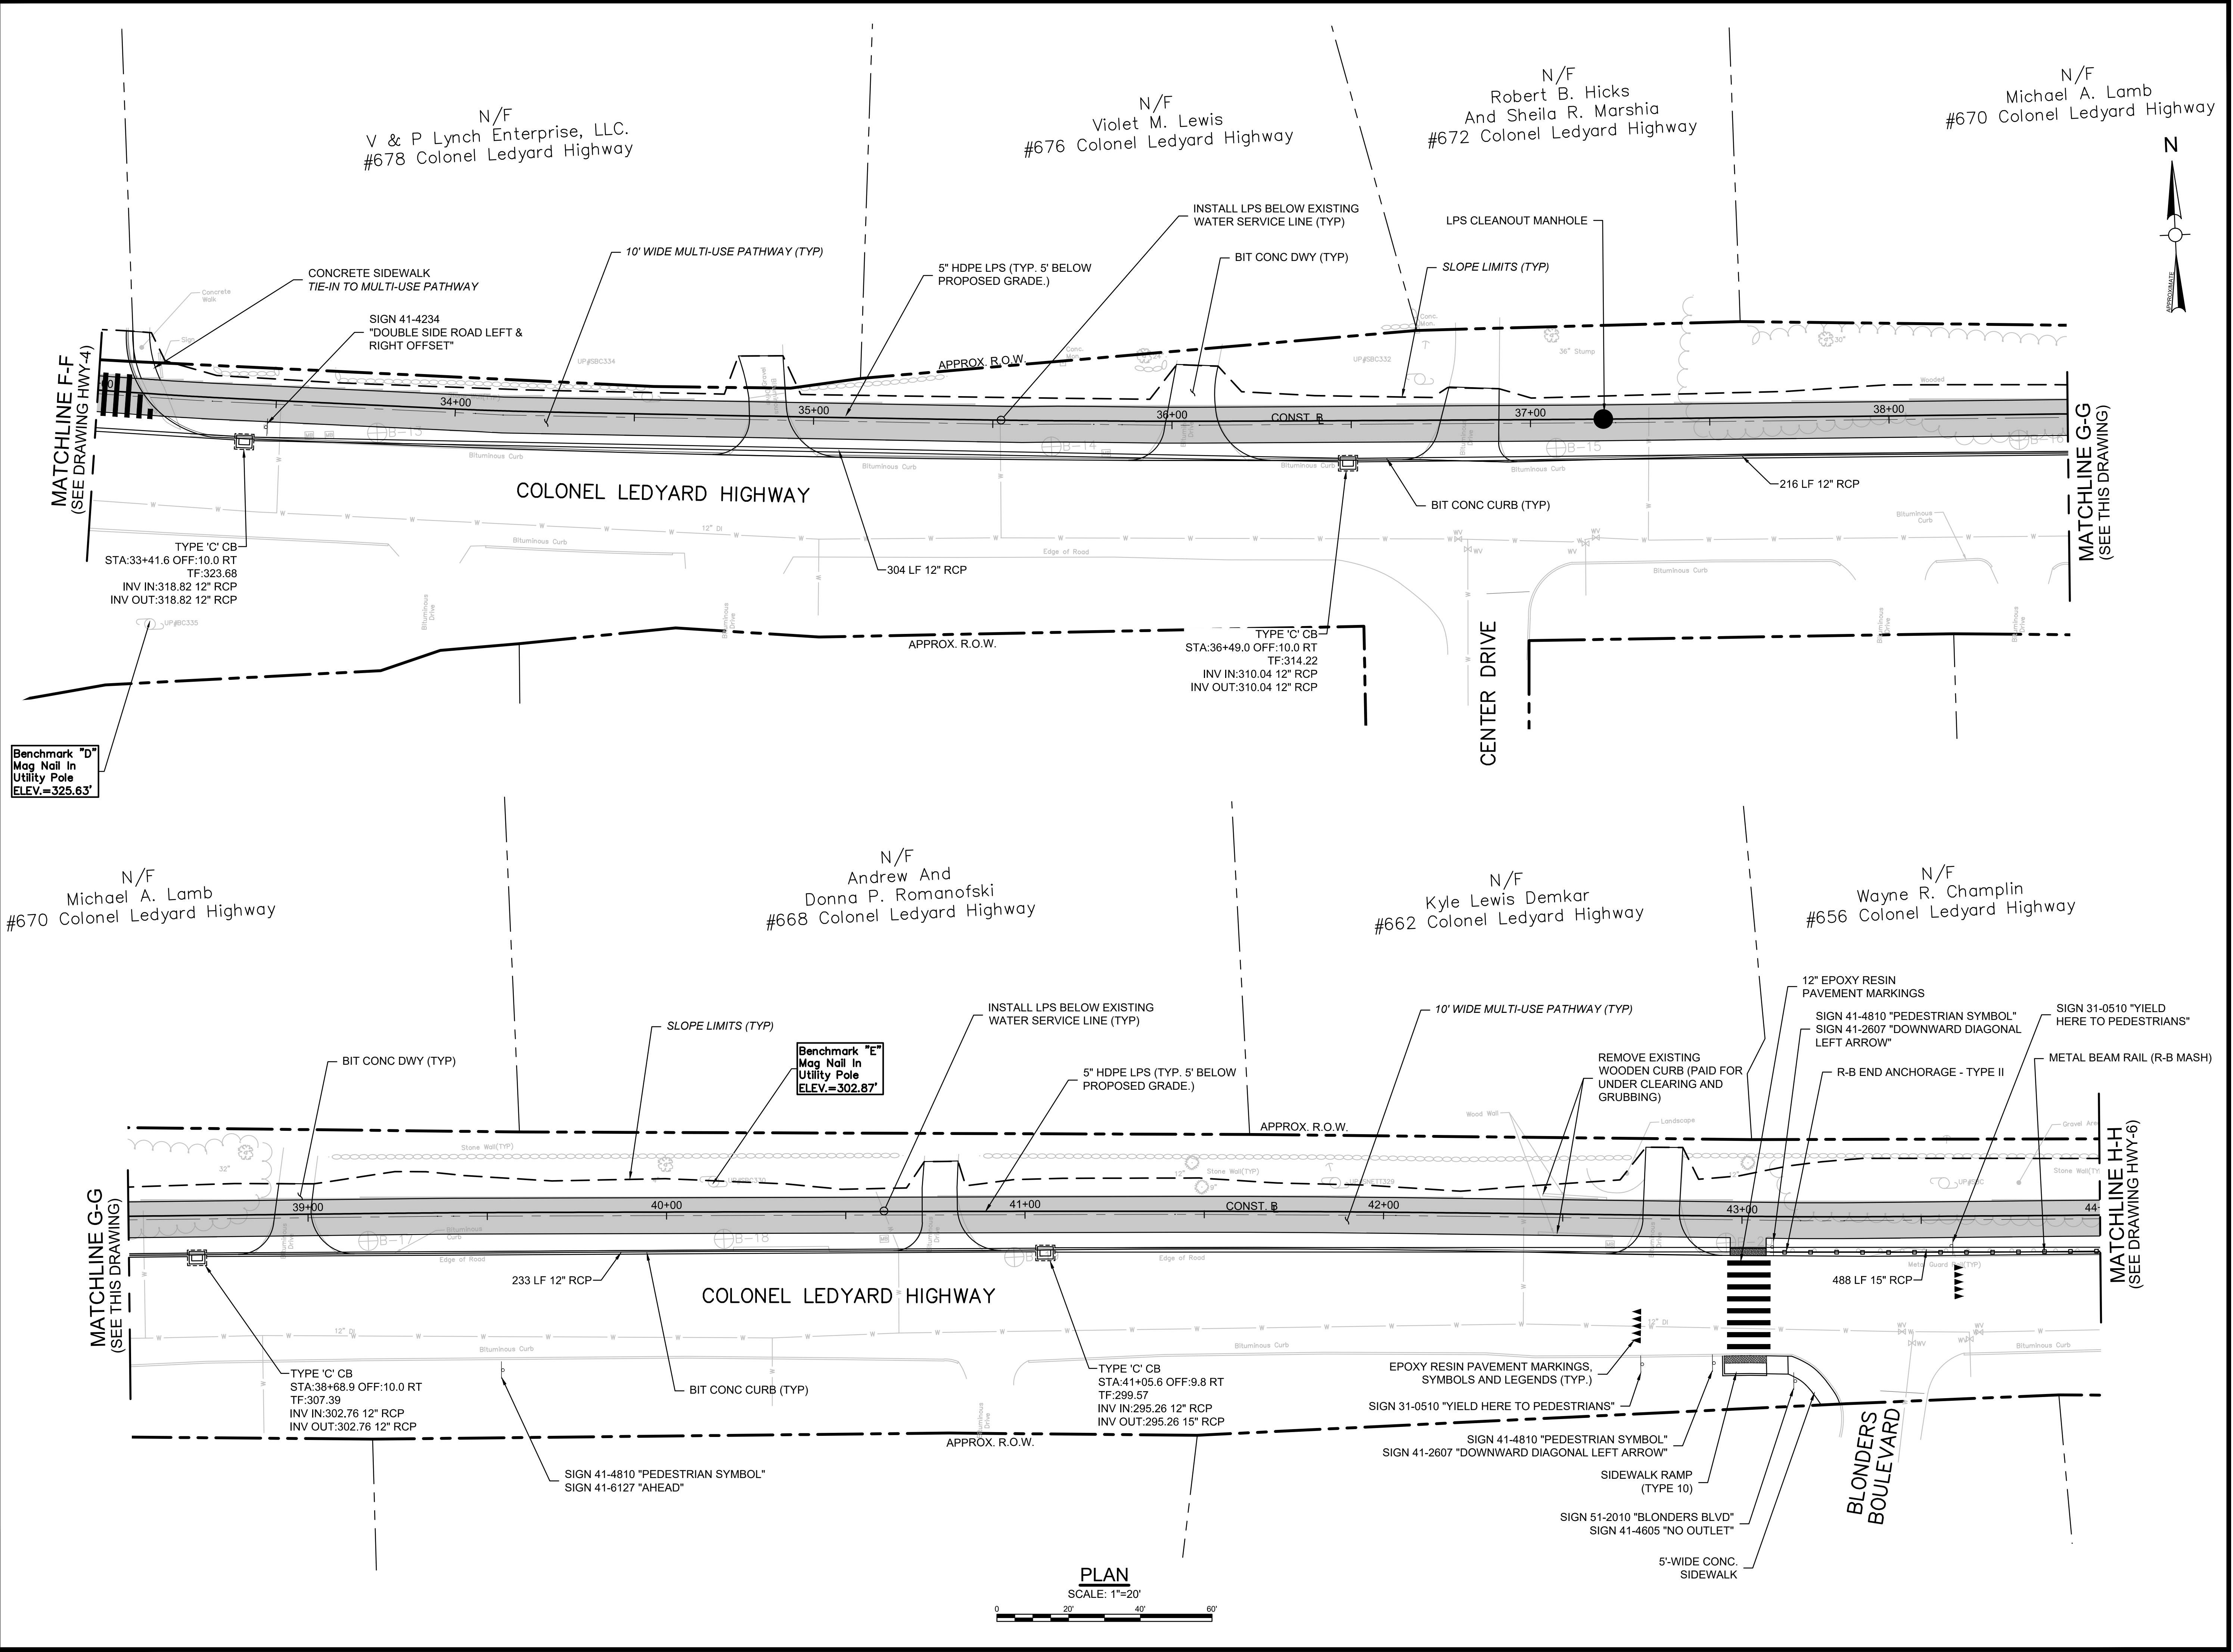
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Drawing Title:

**MULTI-USE PATHWAY
& SIDEWALK PLAN
STA. 33+00 TO 44+00**

Sheet Number:

HWY-5





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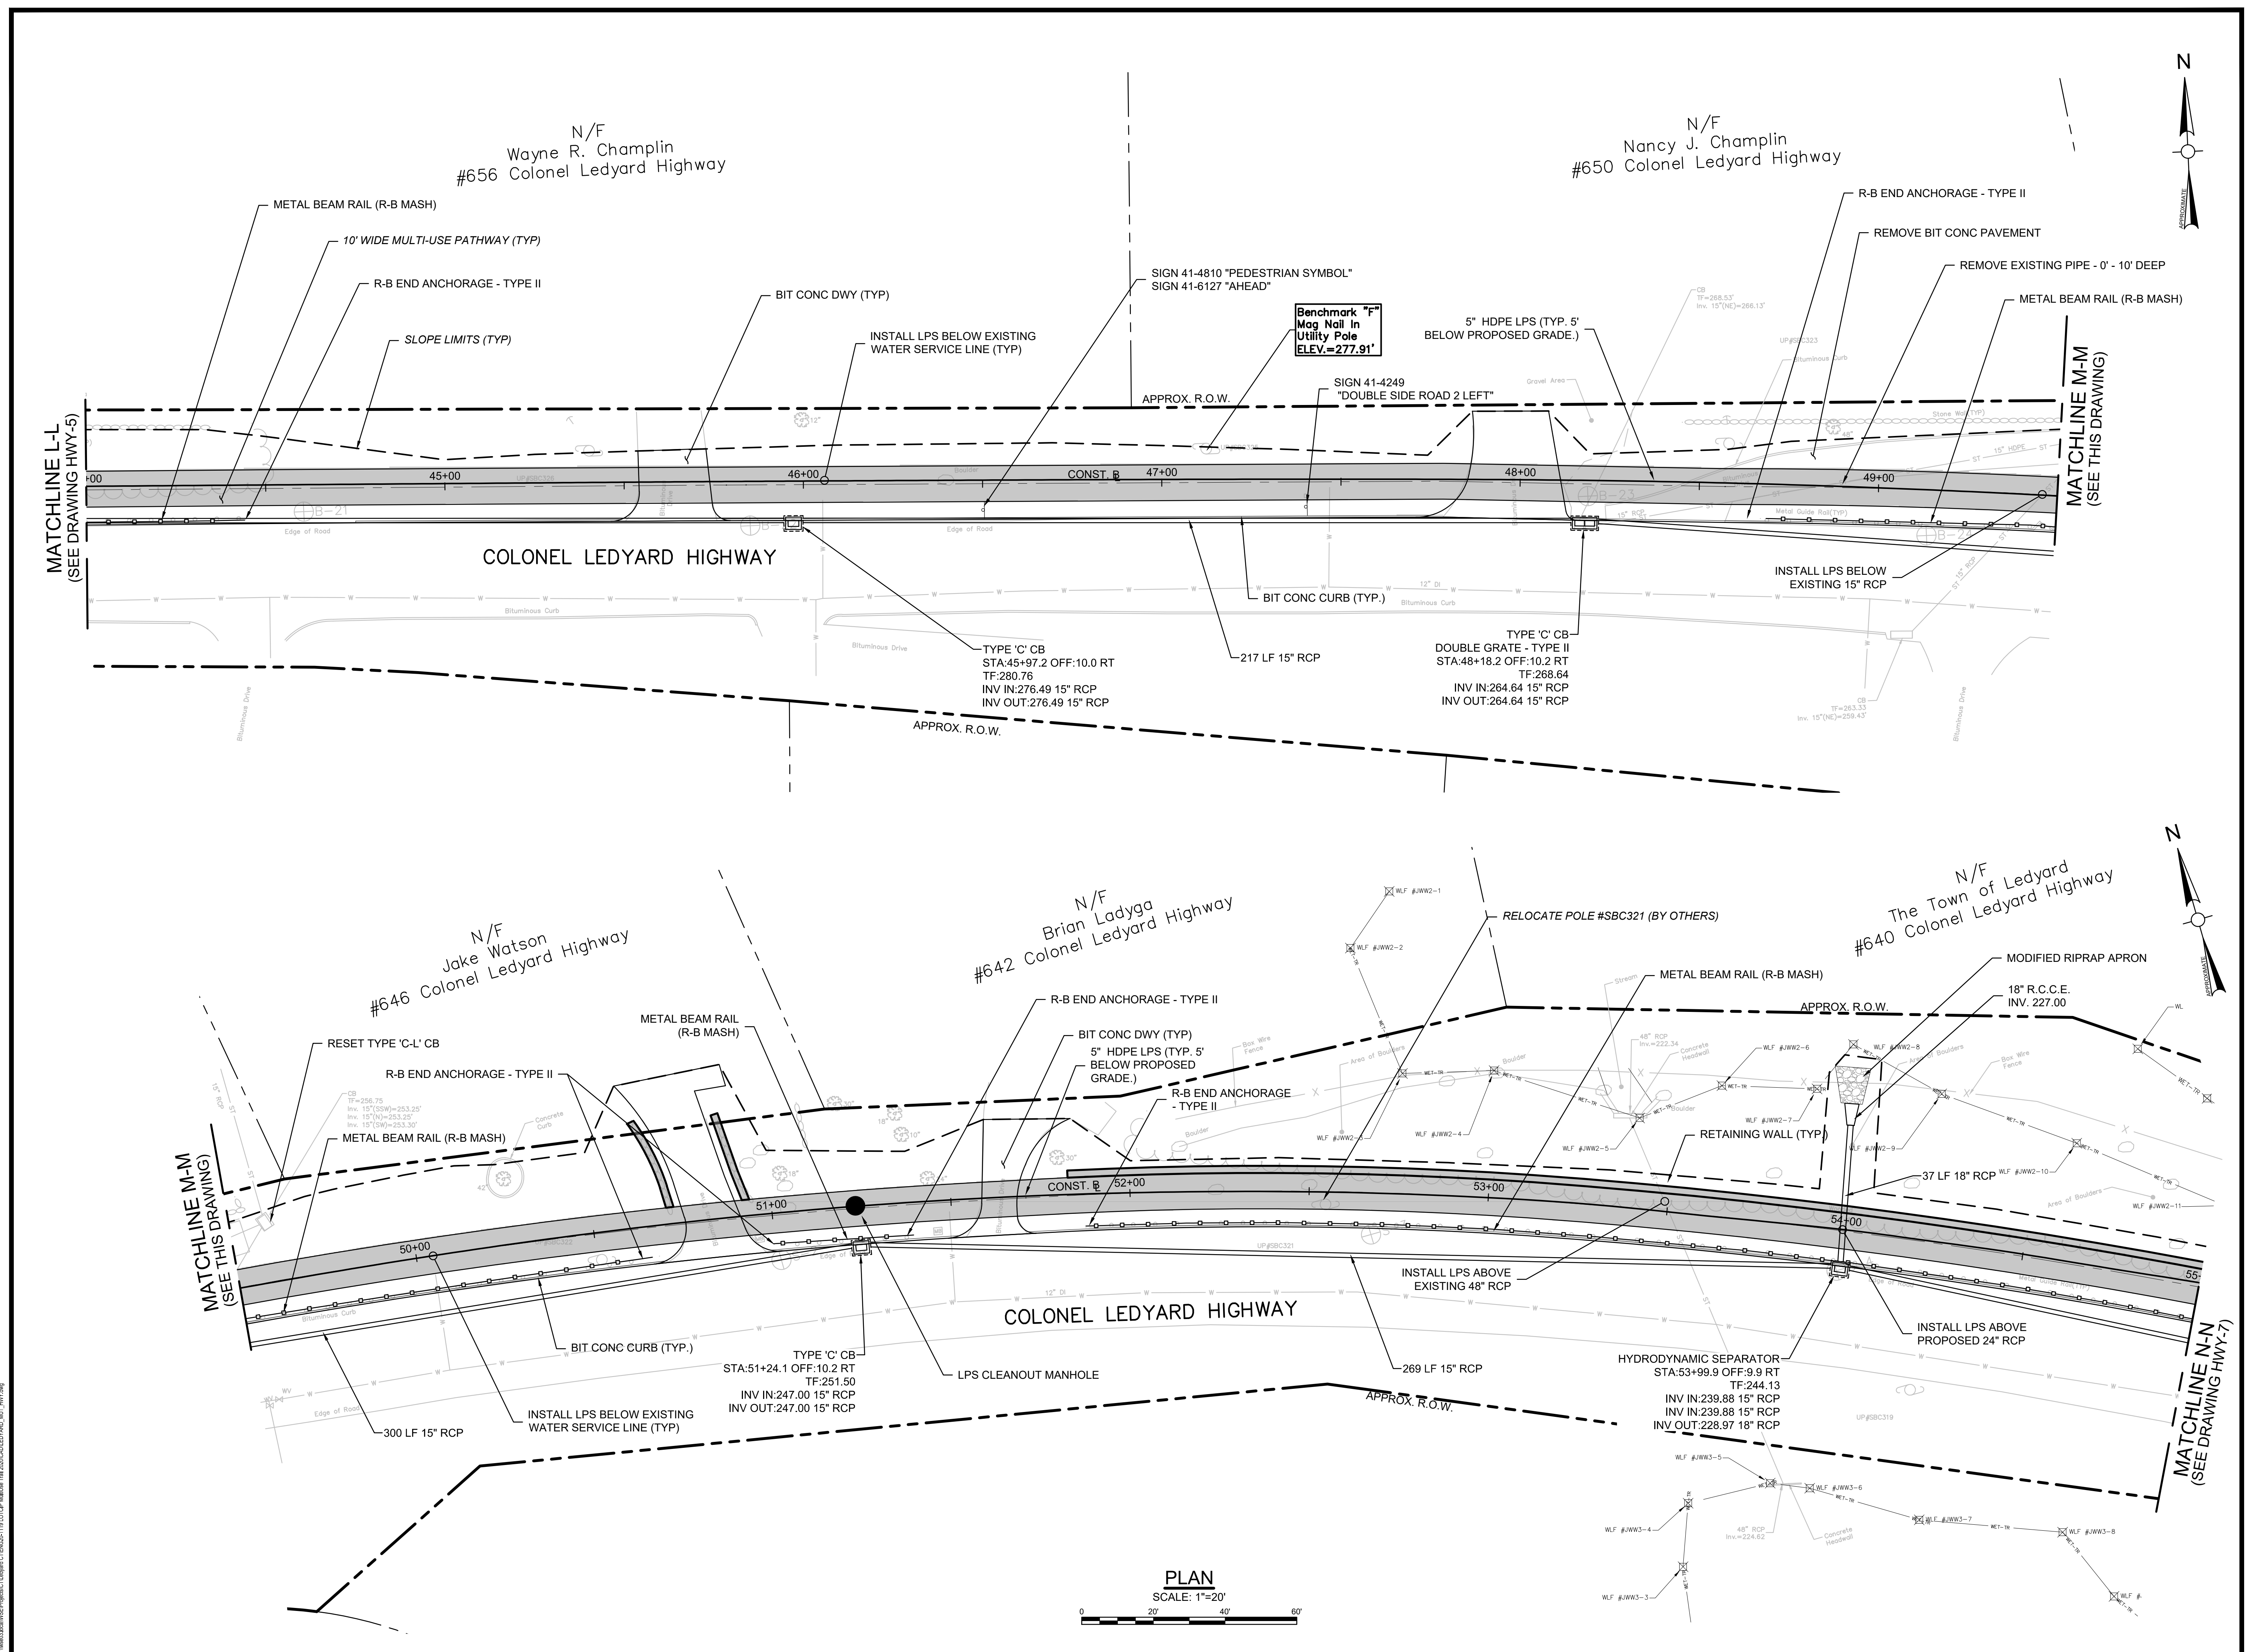
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W&S File No.:

Drawing Title:
**MULTI-USE PATHWAY & SIDEWALK PLAN
STA. 44+00 TO 55+00**
Sheet Number:
HWY-6



PLAN
SCALE: 1"=20'
0 20' 40' 60'

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Rev: 1.6 Date: 04/12/2019

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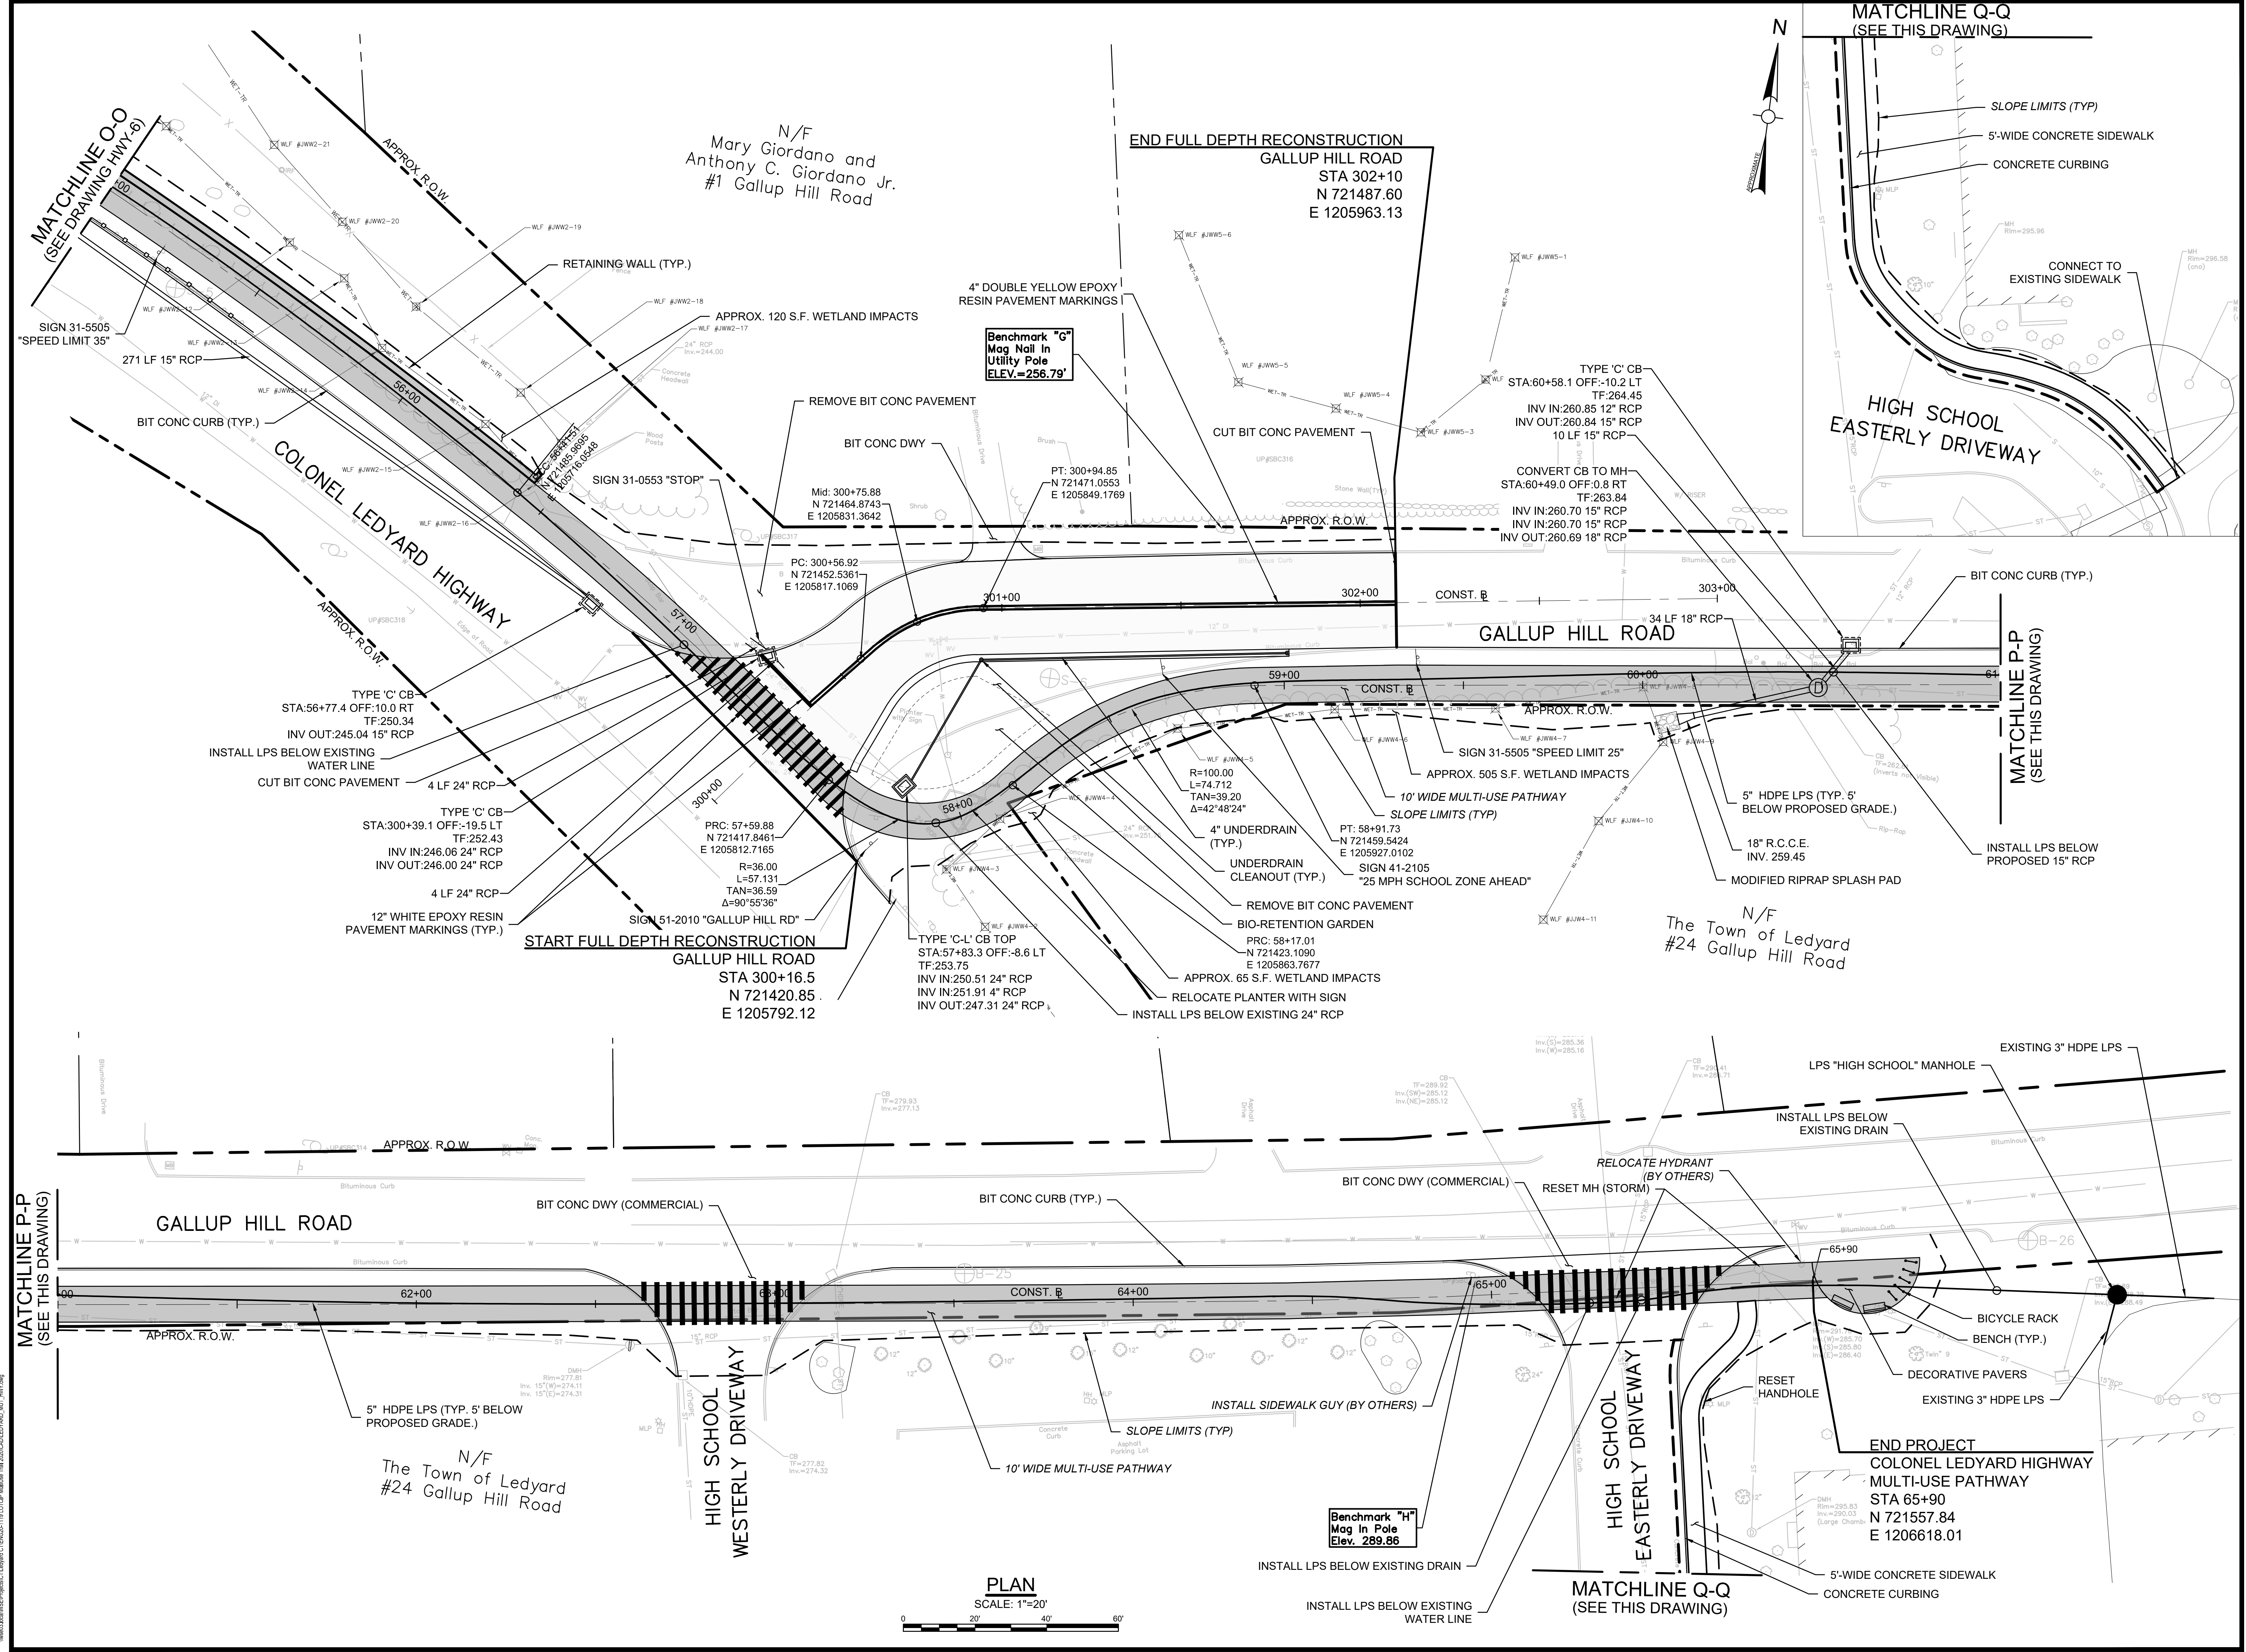
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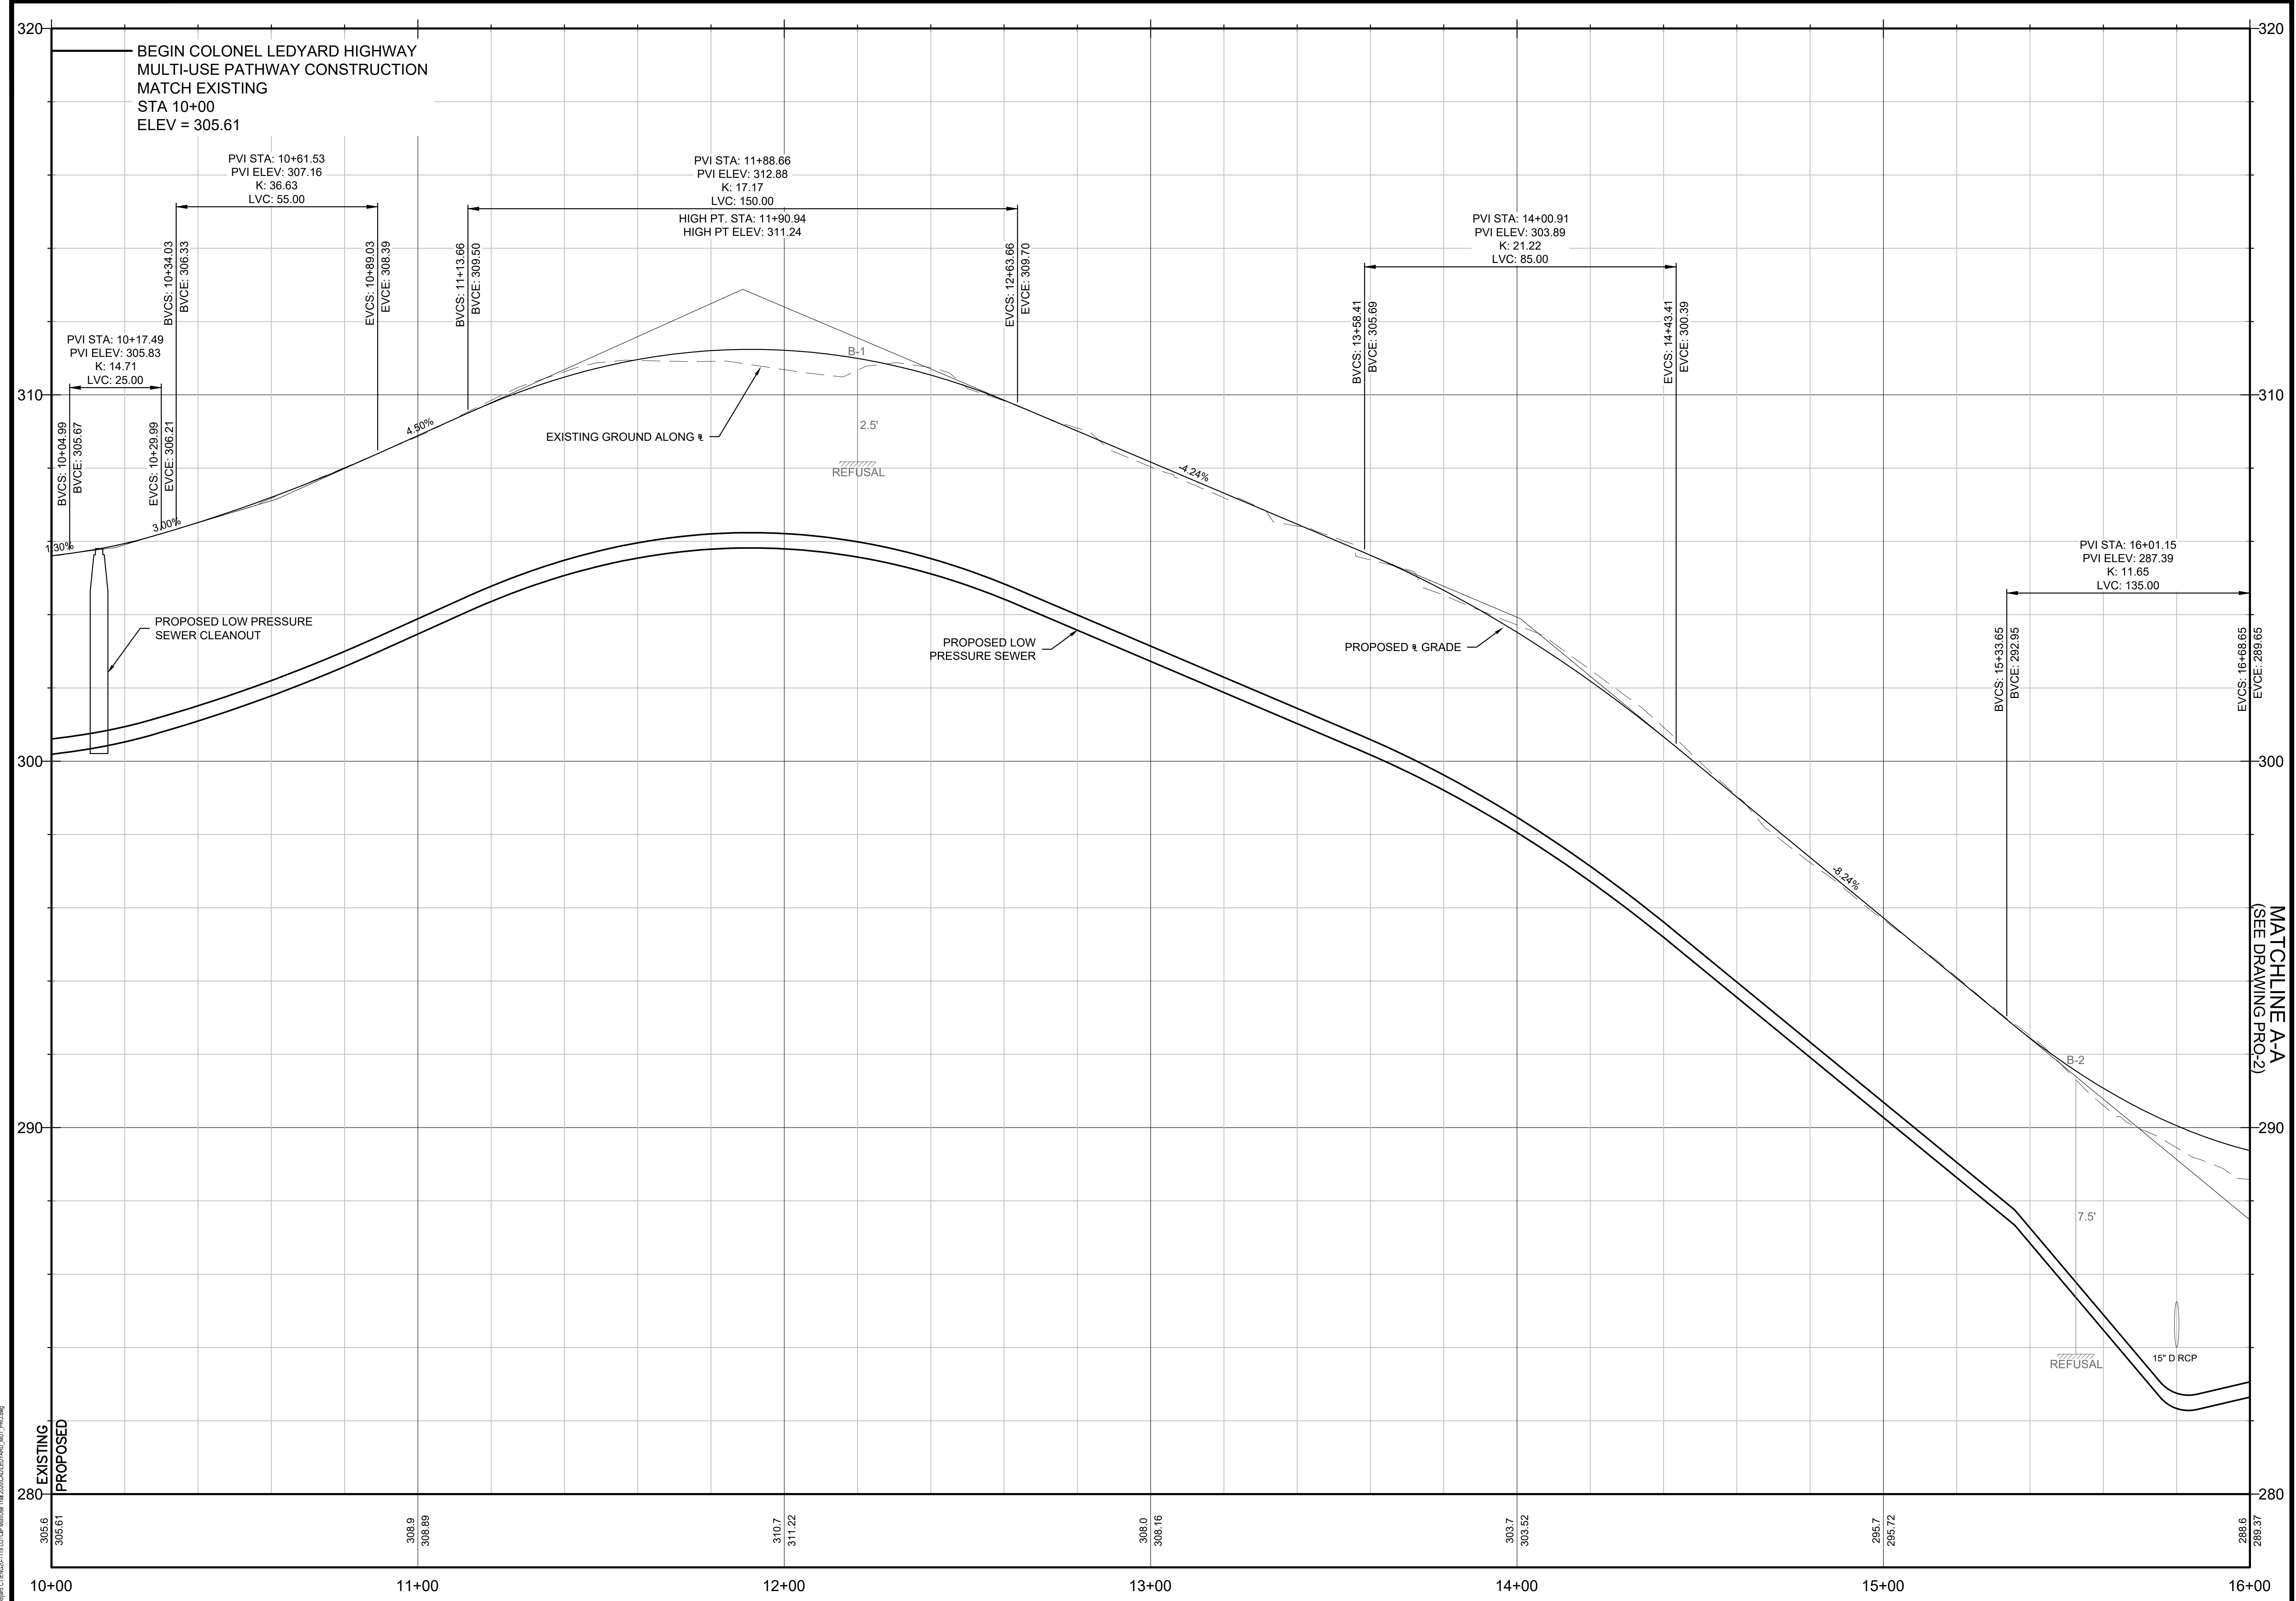
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Reviewed By: RC
Approved By: LAS
W&S Project No.: ENG20-1119
W&S File No.:

Drawing Title:
**MULTI-USE PATHWAY & SIDEWALK PLAN
STA. 55+00 TO 65+90**

Sheet Number:
HWY-7



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CENTERLINE TRAIL PROFILE
SCALE: 1"=20' HORZ, 1"=2' VERT

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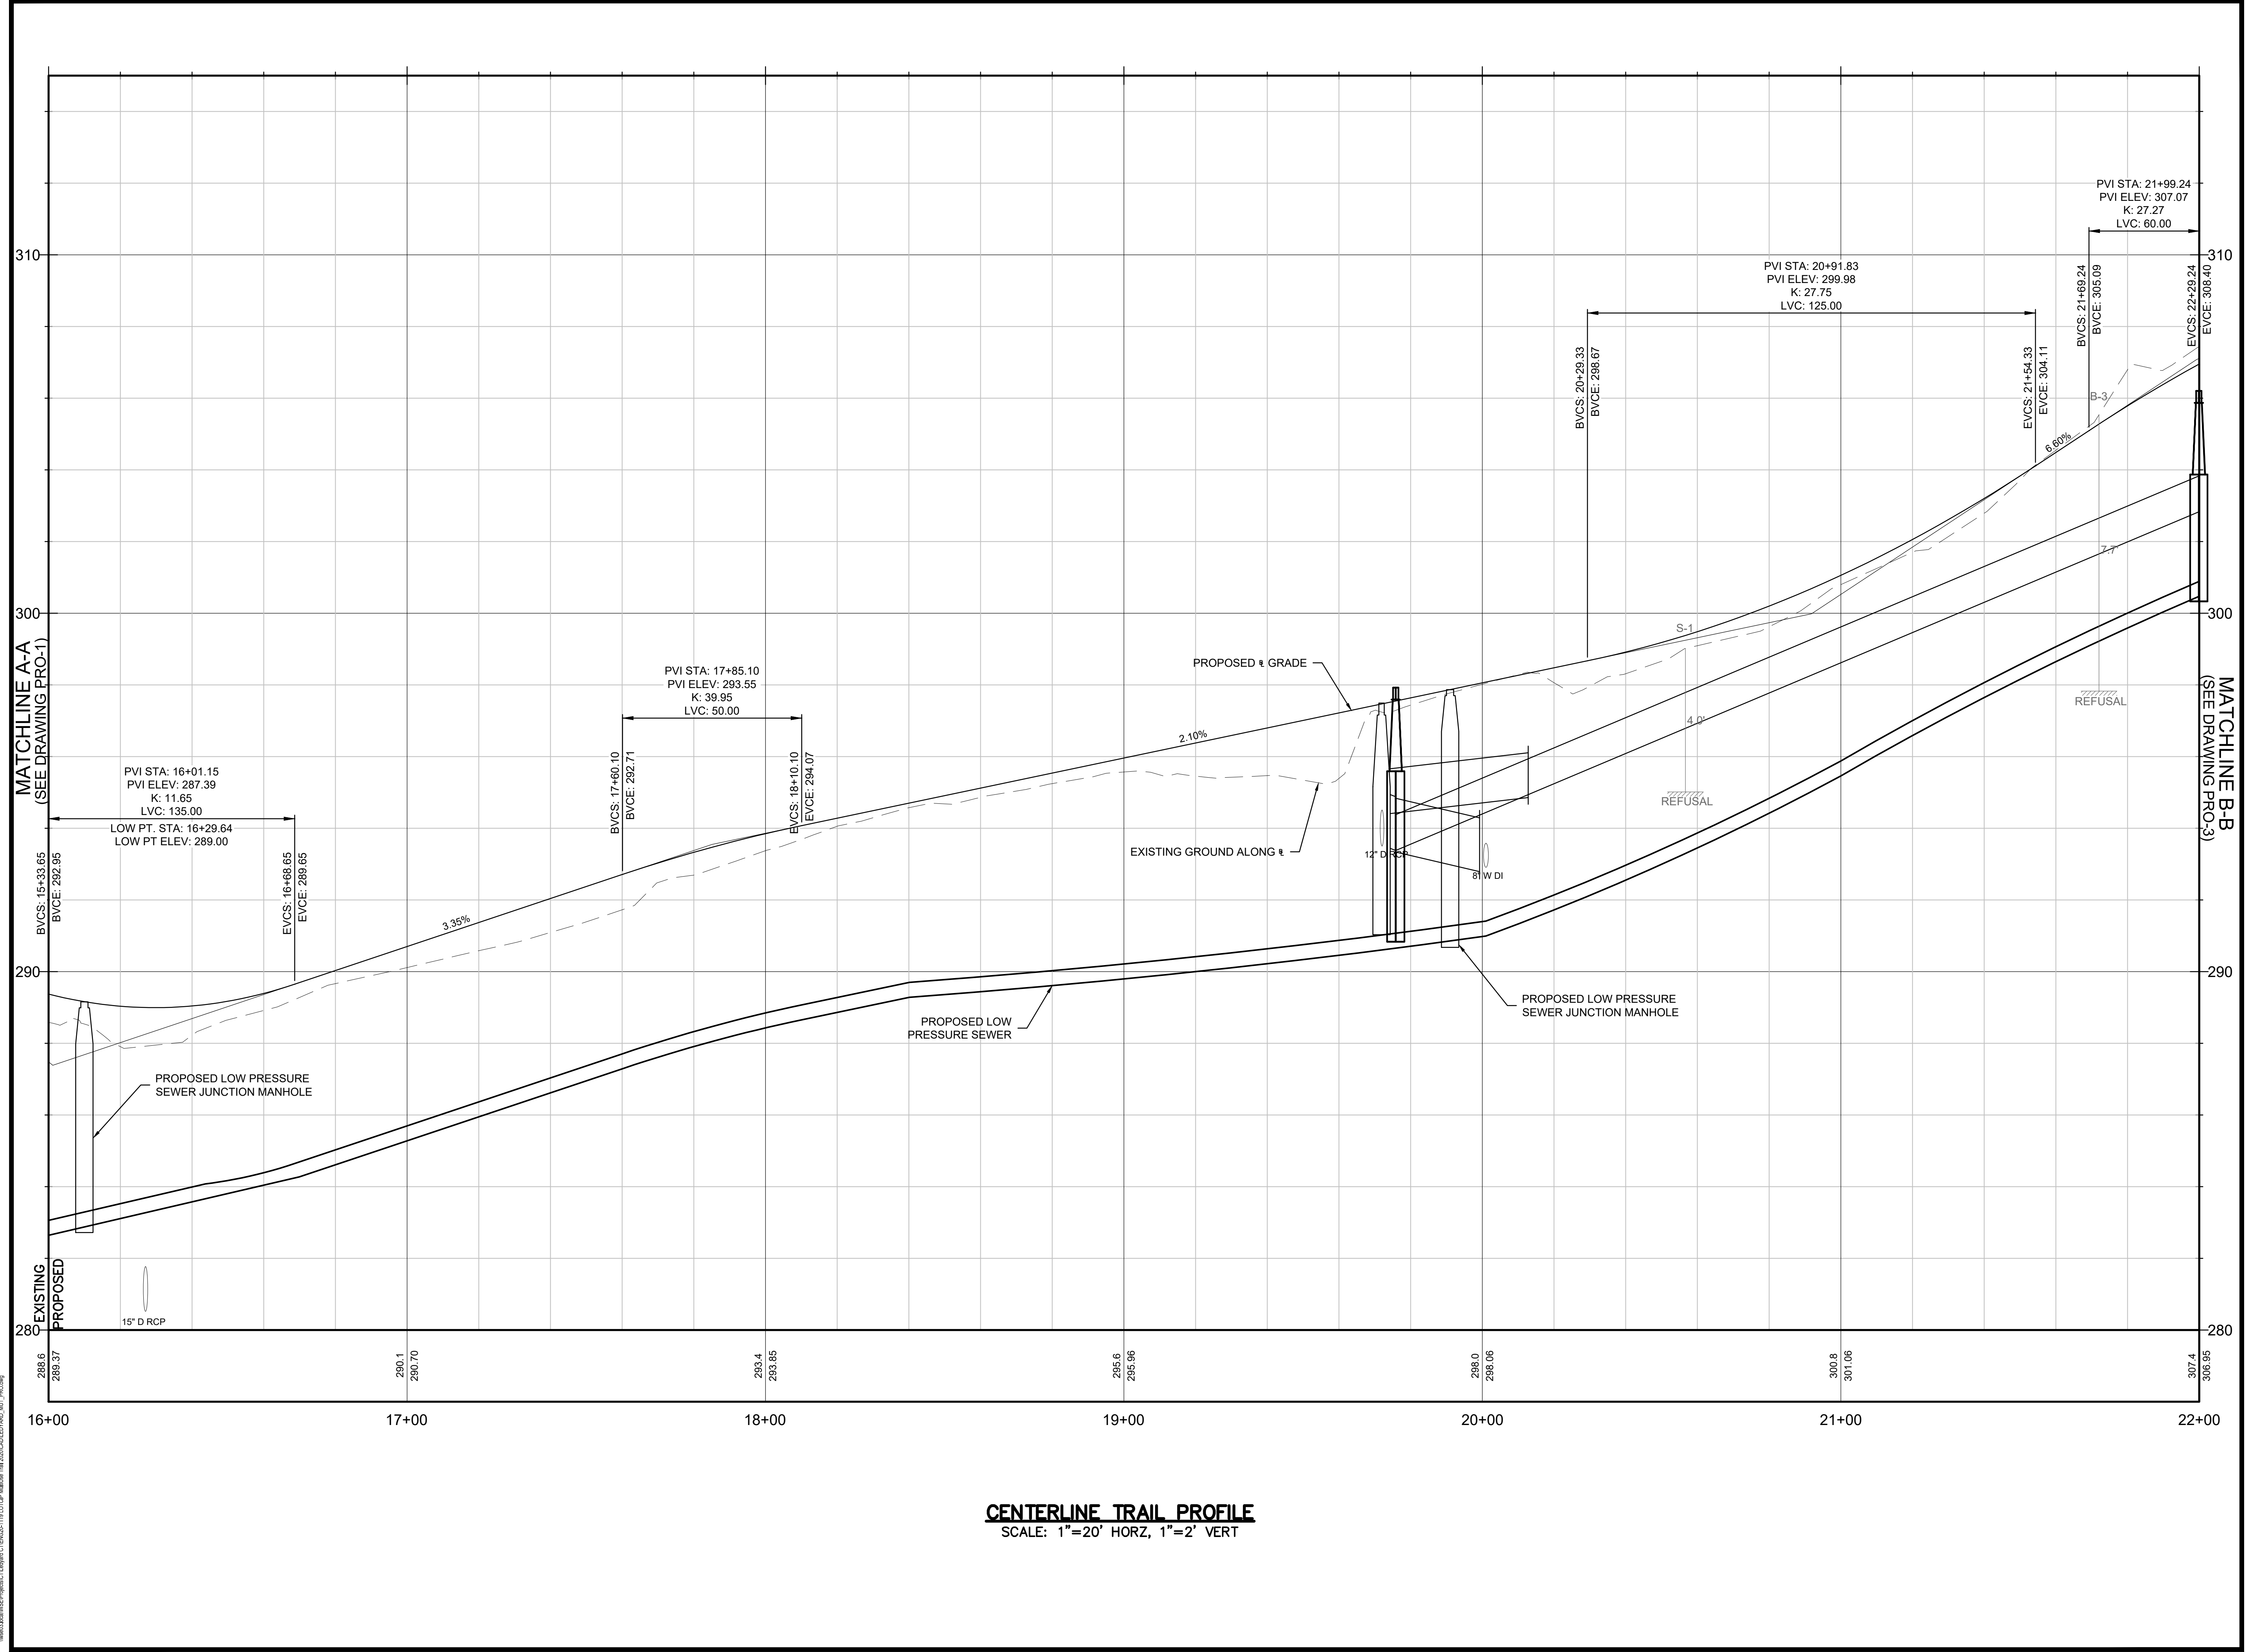
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W&S File No.:

Drawing Title:
**MULTI-USE PATHWAY PROFILE
STA. 10+00 TO 16+50**

Sheet Number:
PRO-01

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W&S File No.:

Drawing Title:
MULTI-USE PATHWAY PROFILE
STA. 16+50 TO 22+00

Sheet Number:
PRO-02

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Revisions:

No.	Date	Description

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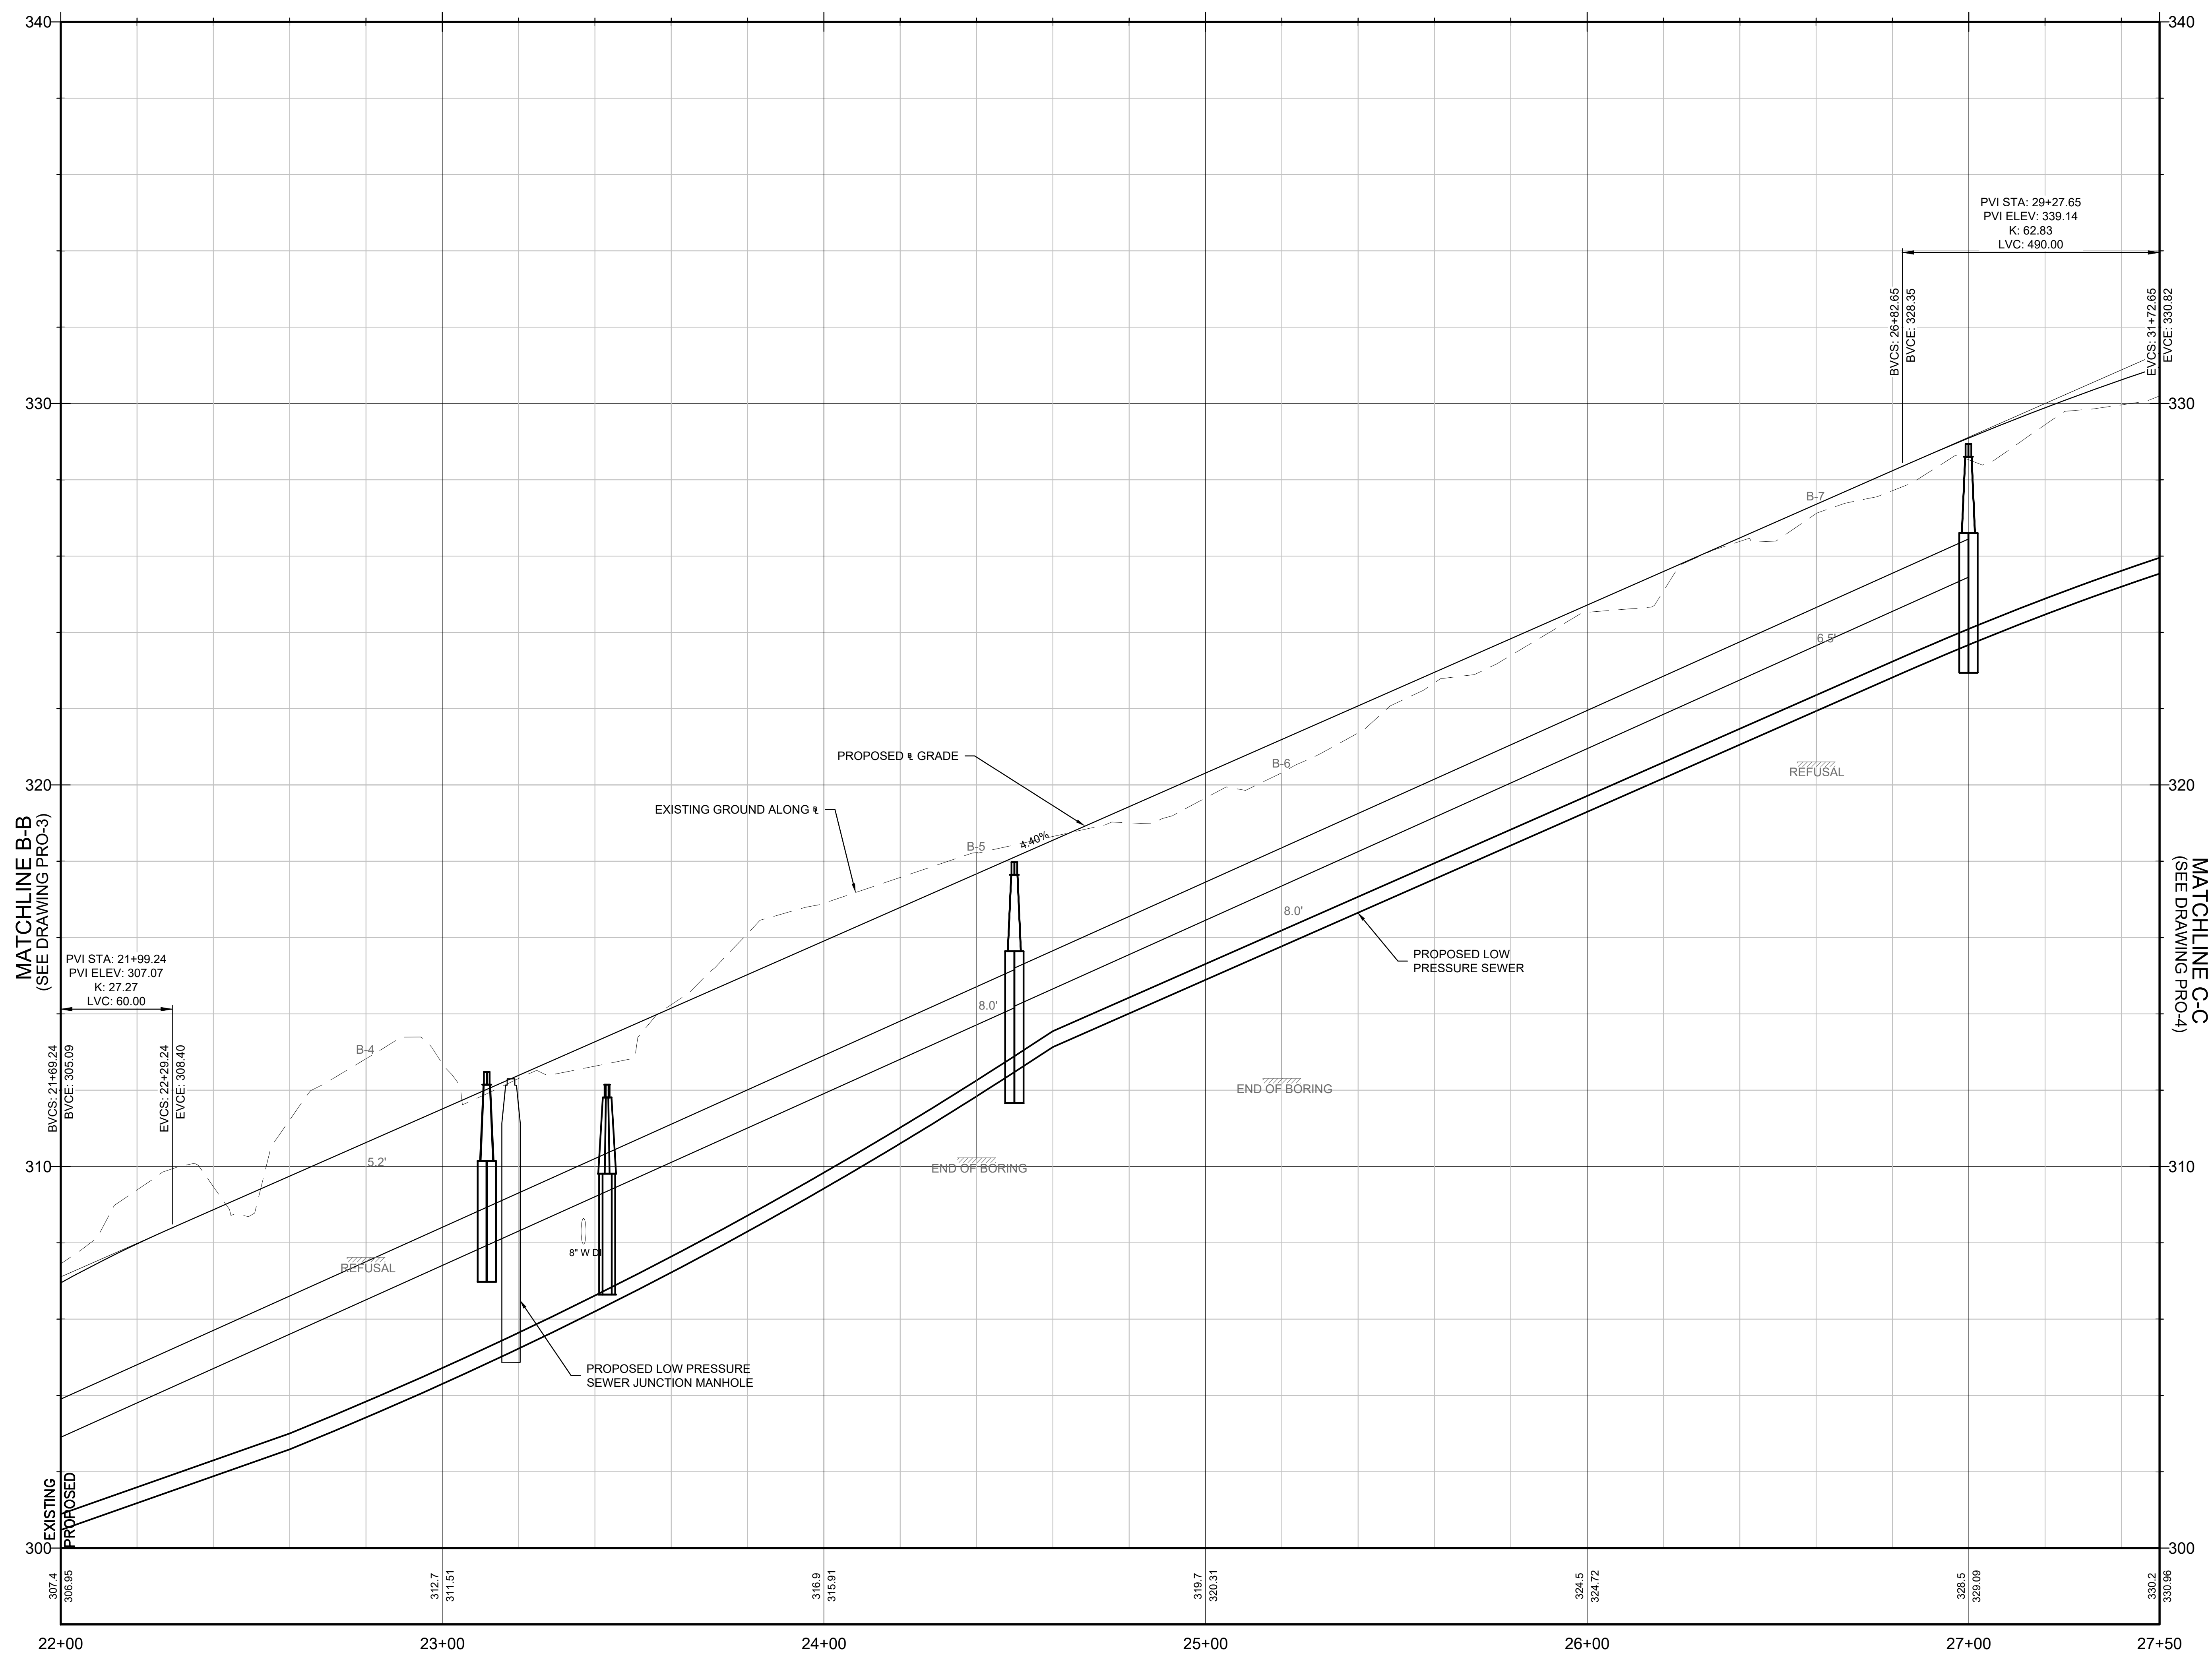
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W&S File No.:

Drawing Title:
**MULTI-USE PATHWAY
PROFILE
STA. 22+00 TO 27+50**

Sheet Number:
PRO-03



CENTERLINE TRAIL PROFILE
SCALE: 1"=20' HORZ, 1"=2' VERT

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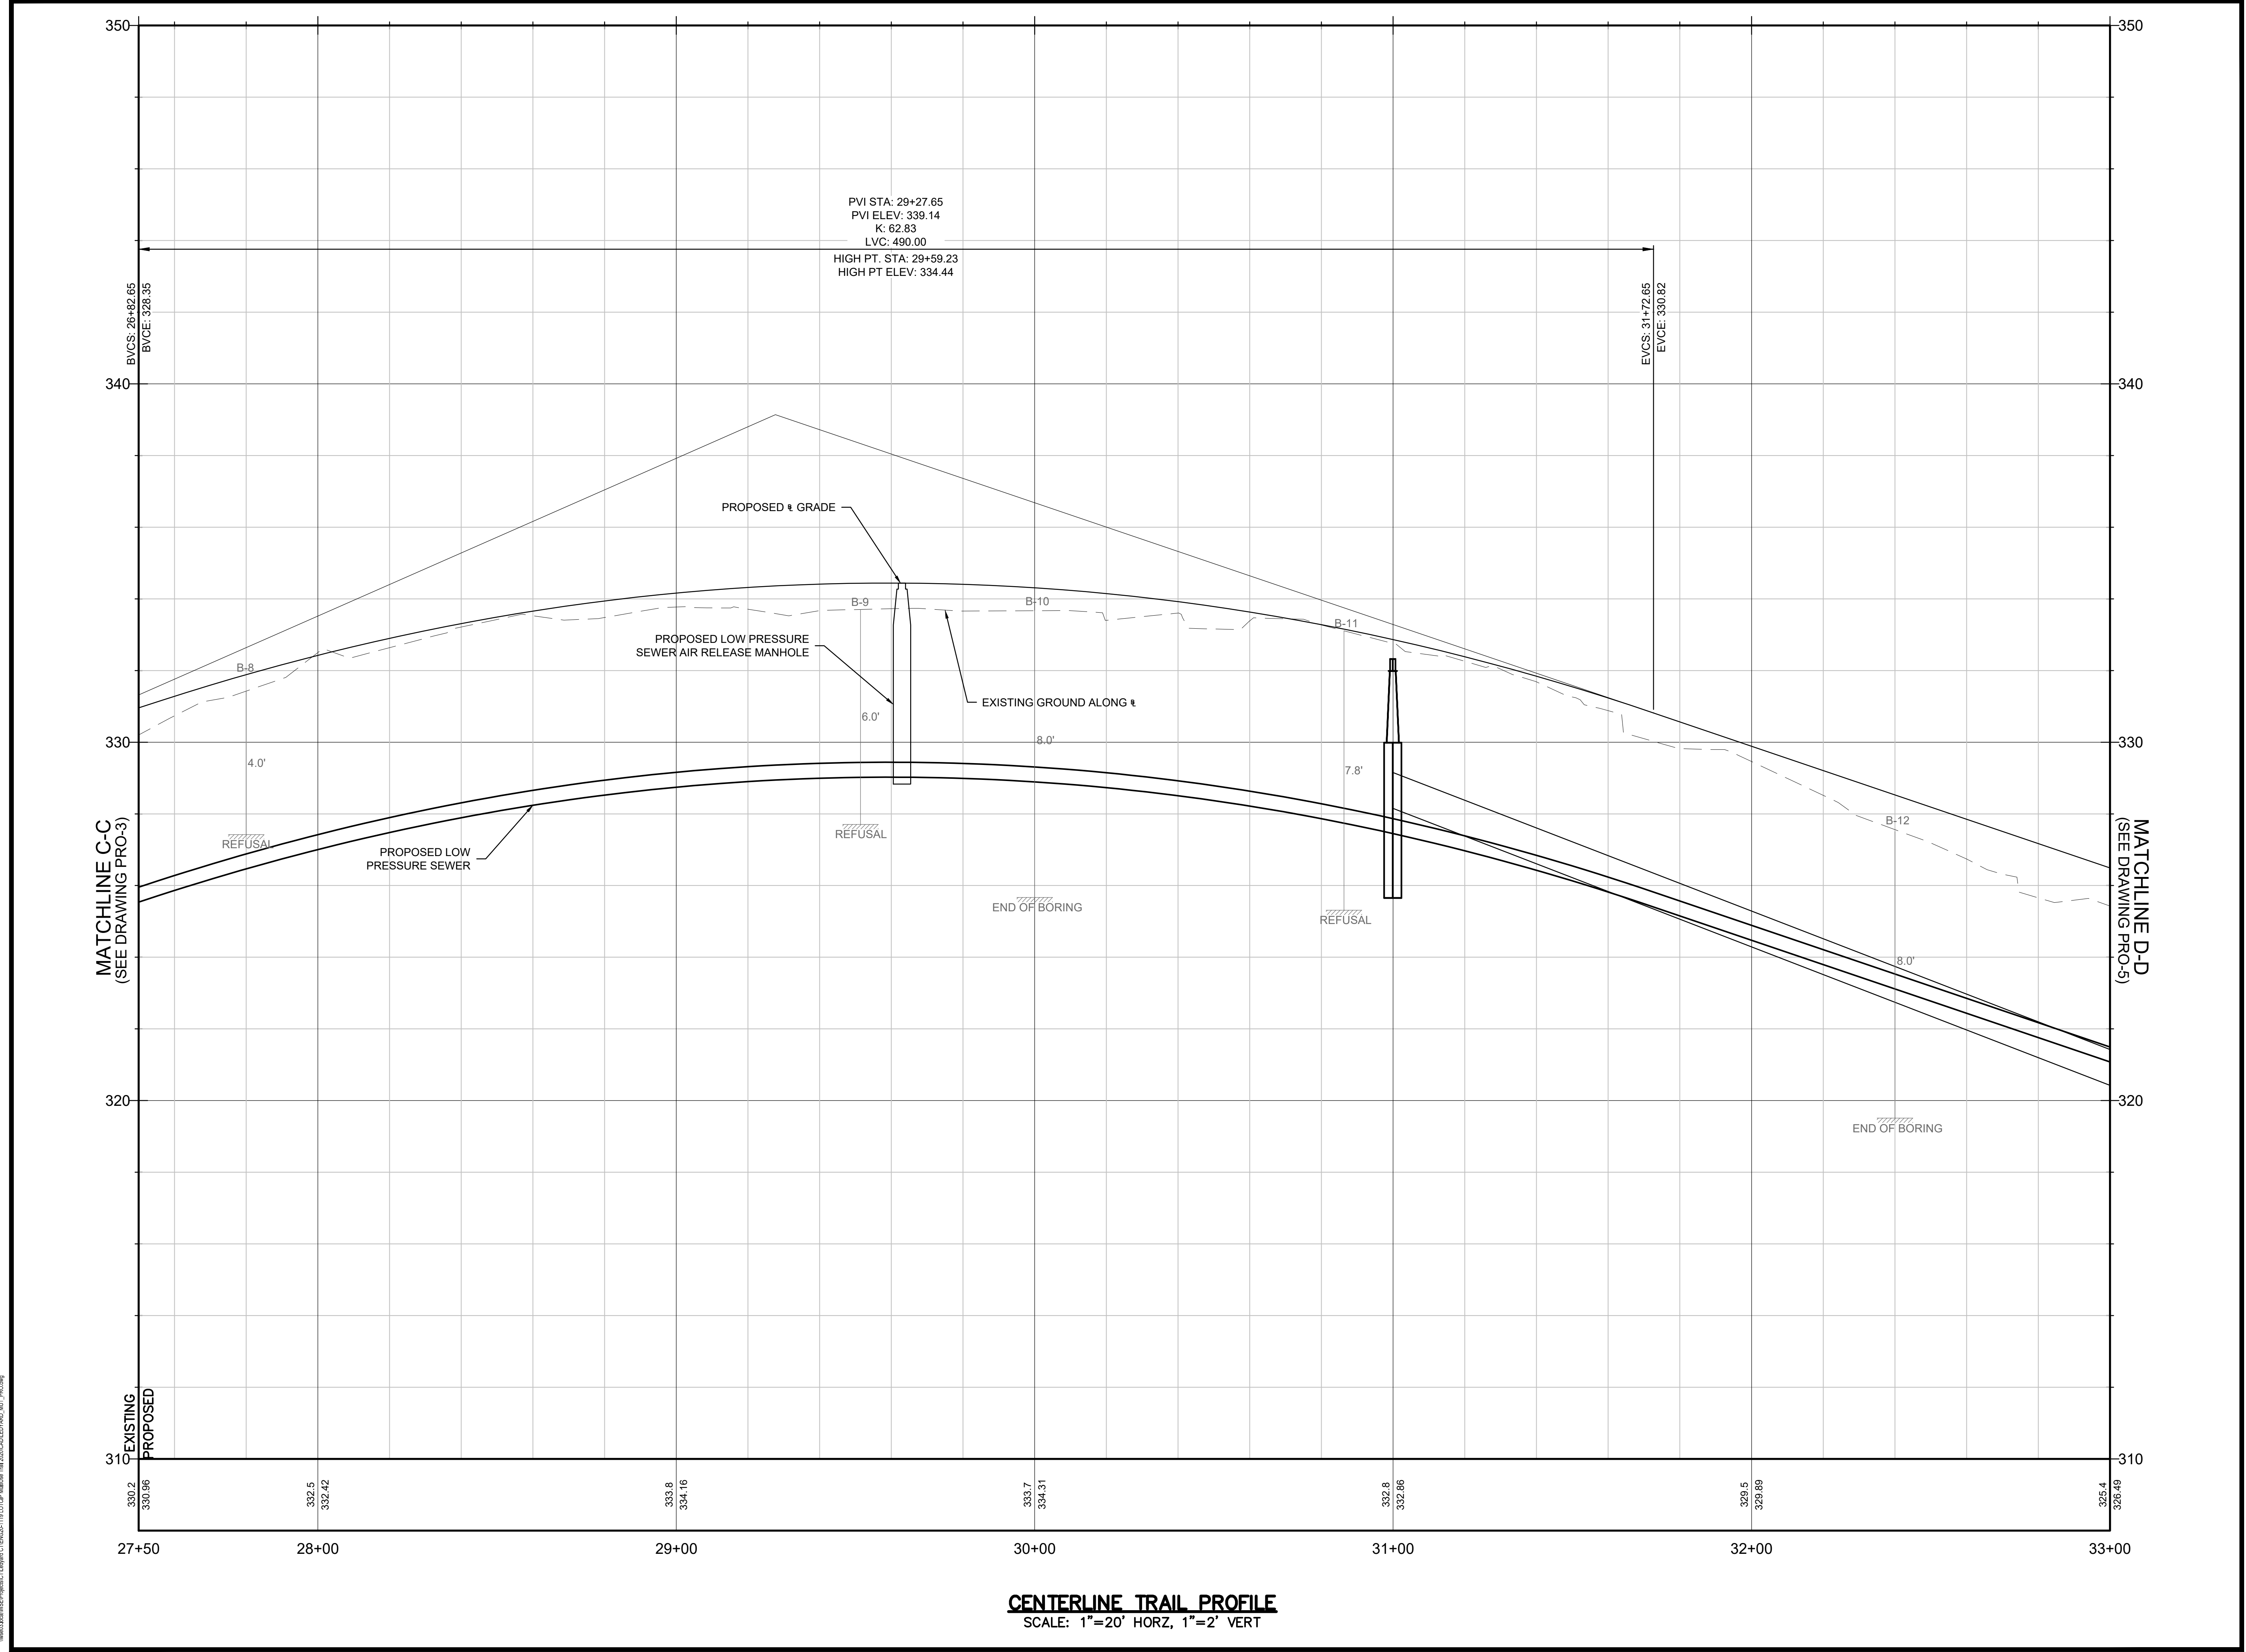
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W&S File No.:

Drawing Title:
**MULTI-USE PATHWAY PROFILE
STA. 27+50 TO 33+00**

Sheet Number:
PRO-04



CENTERLINE TRAIL PROFILE
SCALE: 1"=20' HORZ, 1"=2' VERT

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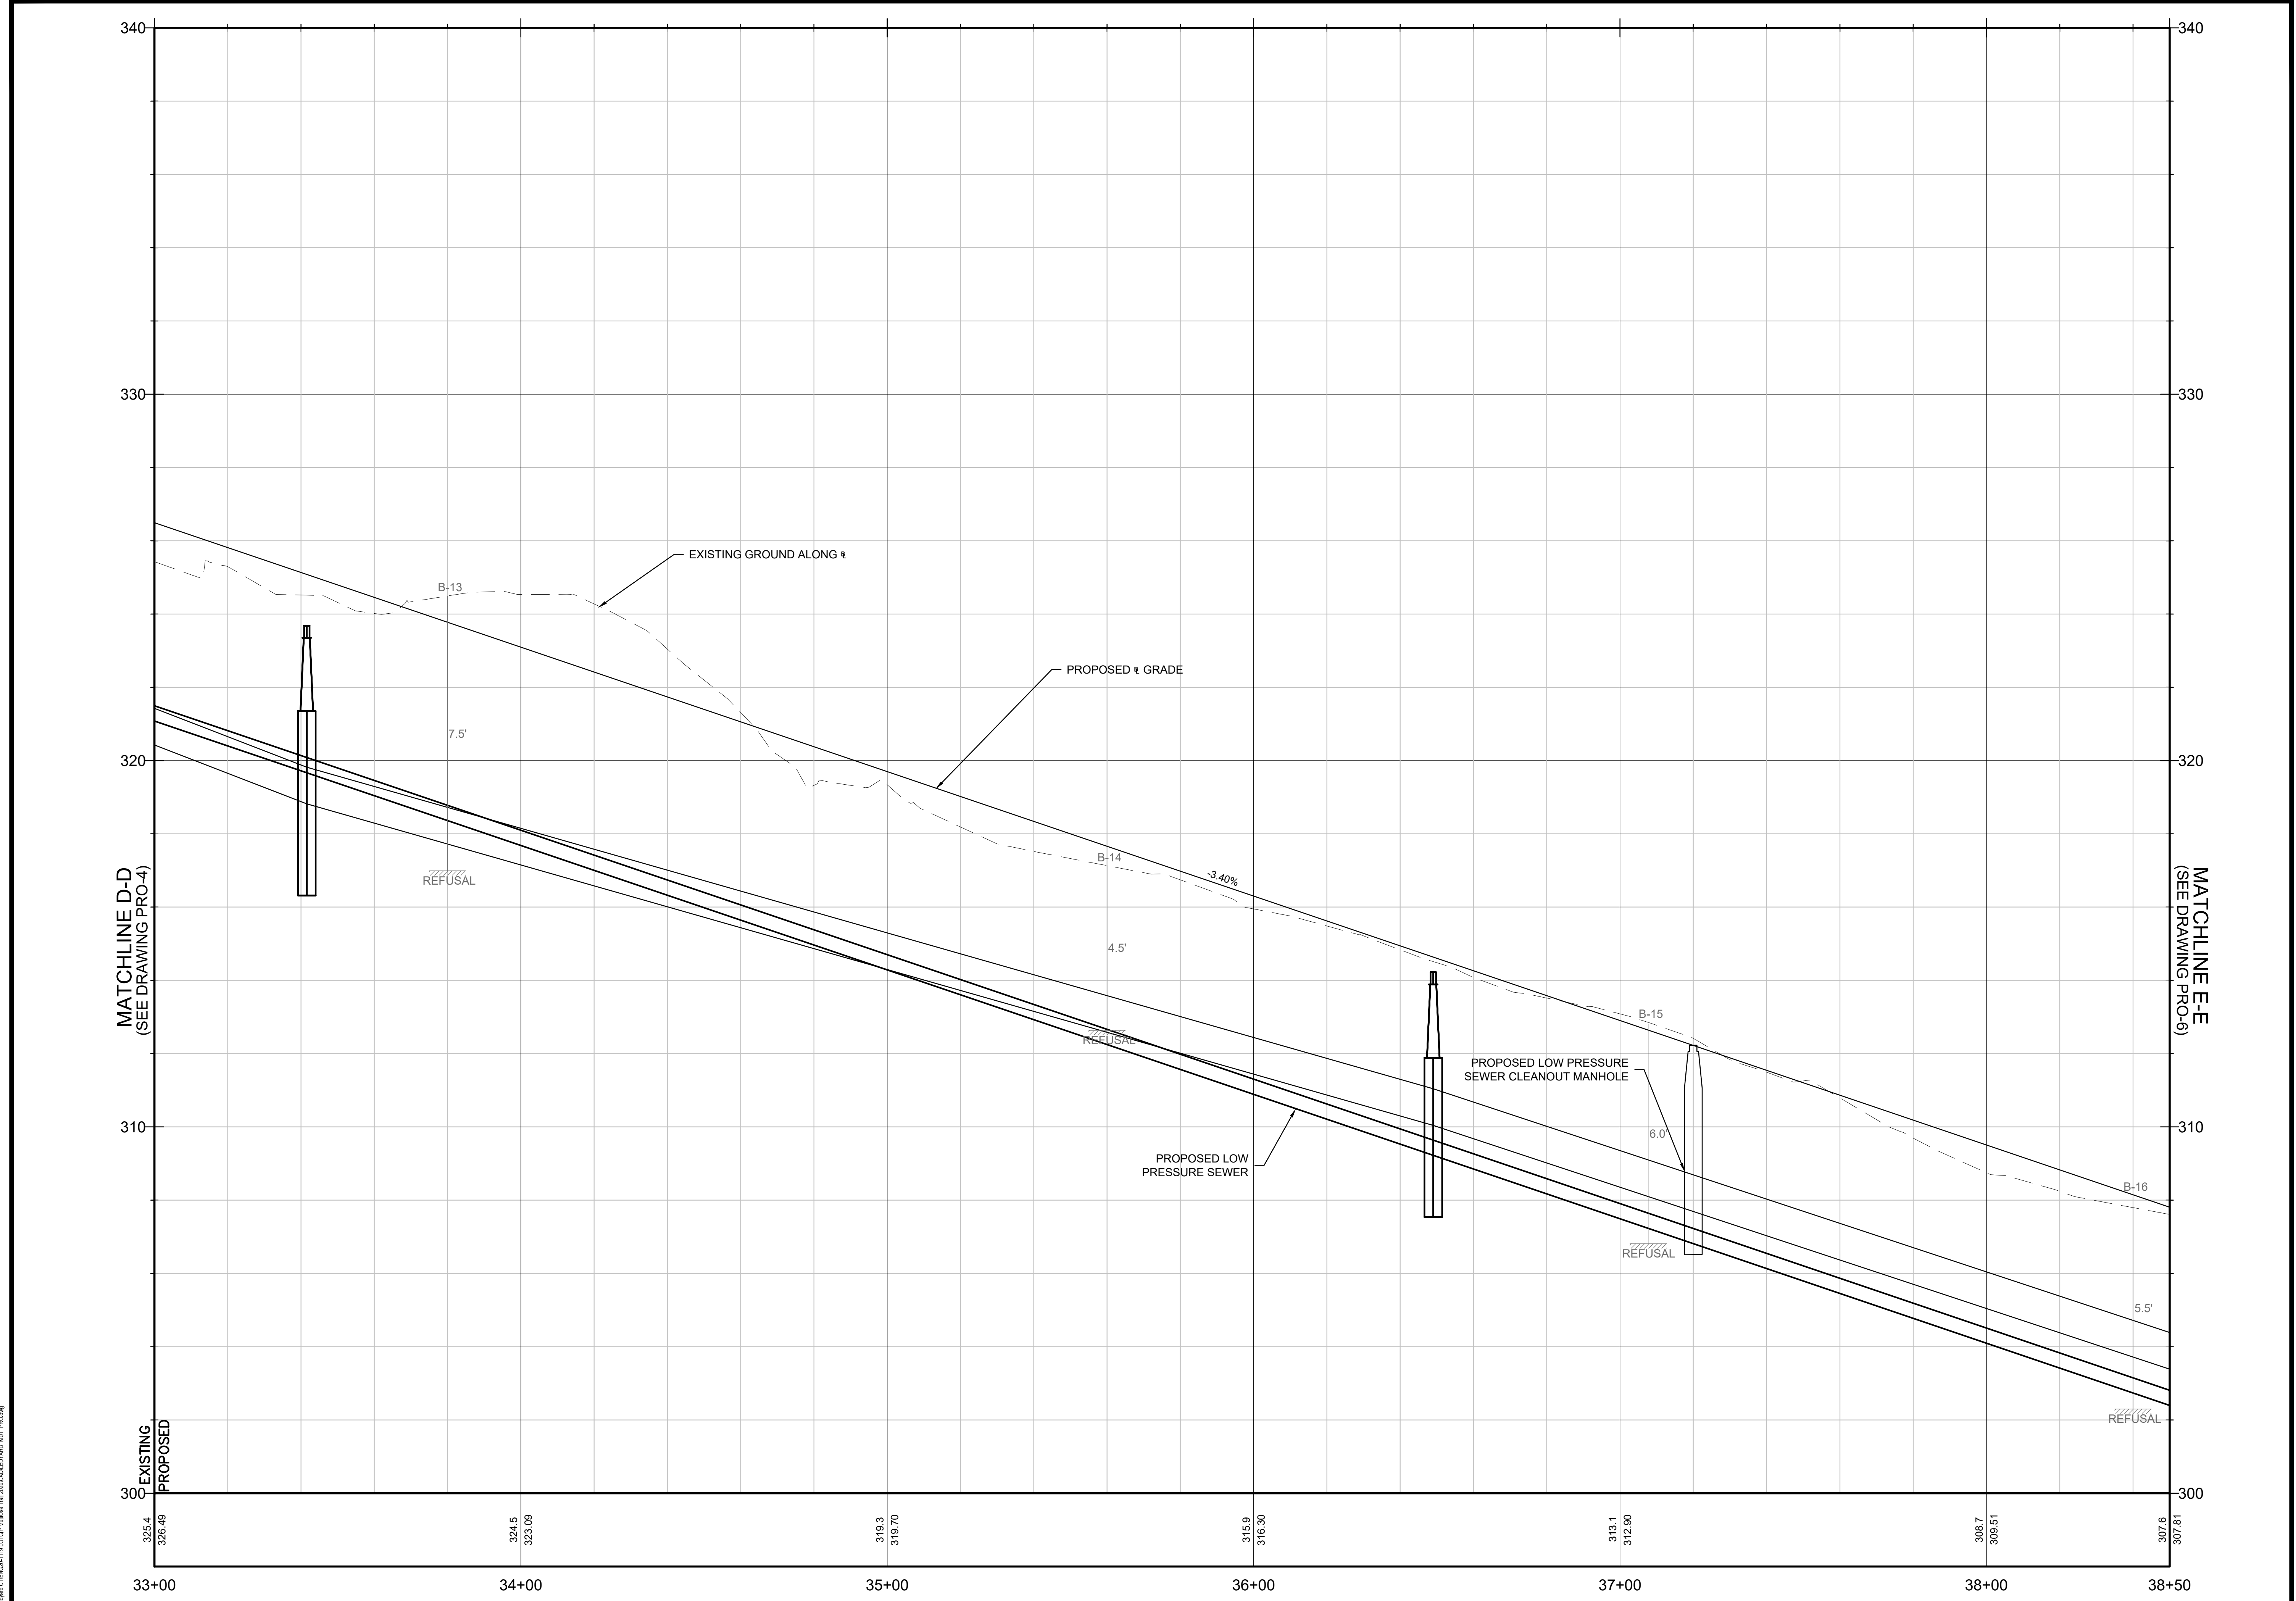
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Drawing Title:

**MULTI-USE PATHWAY
PROFILE
STA. 33+00 TO 38+50**

Sheet Number:

PRO-05



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CENTERLINE TRAIL PROFILE
SCALE: 1"=20' HORZ, 1"=2' VERT

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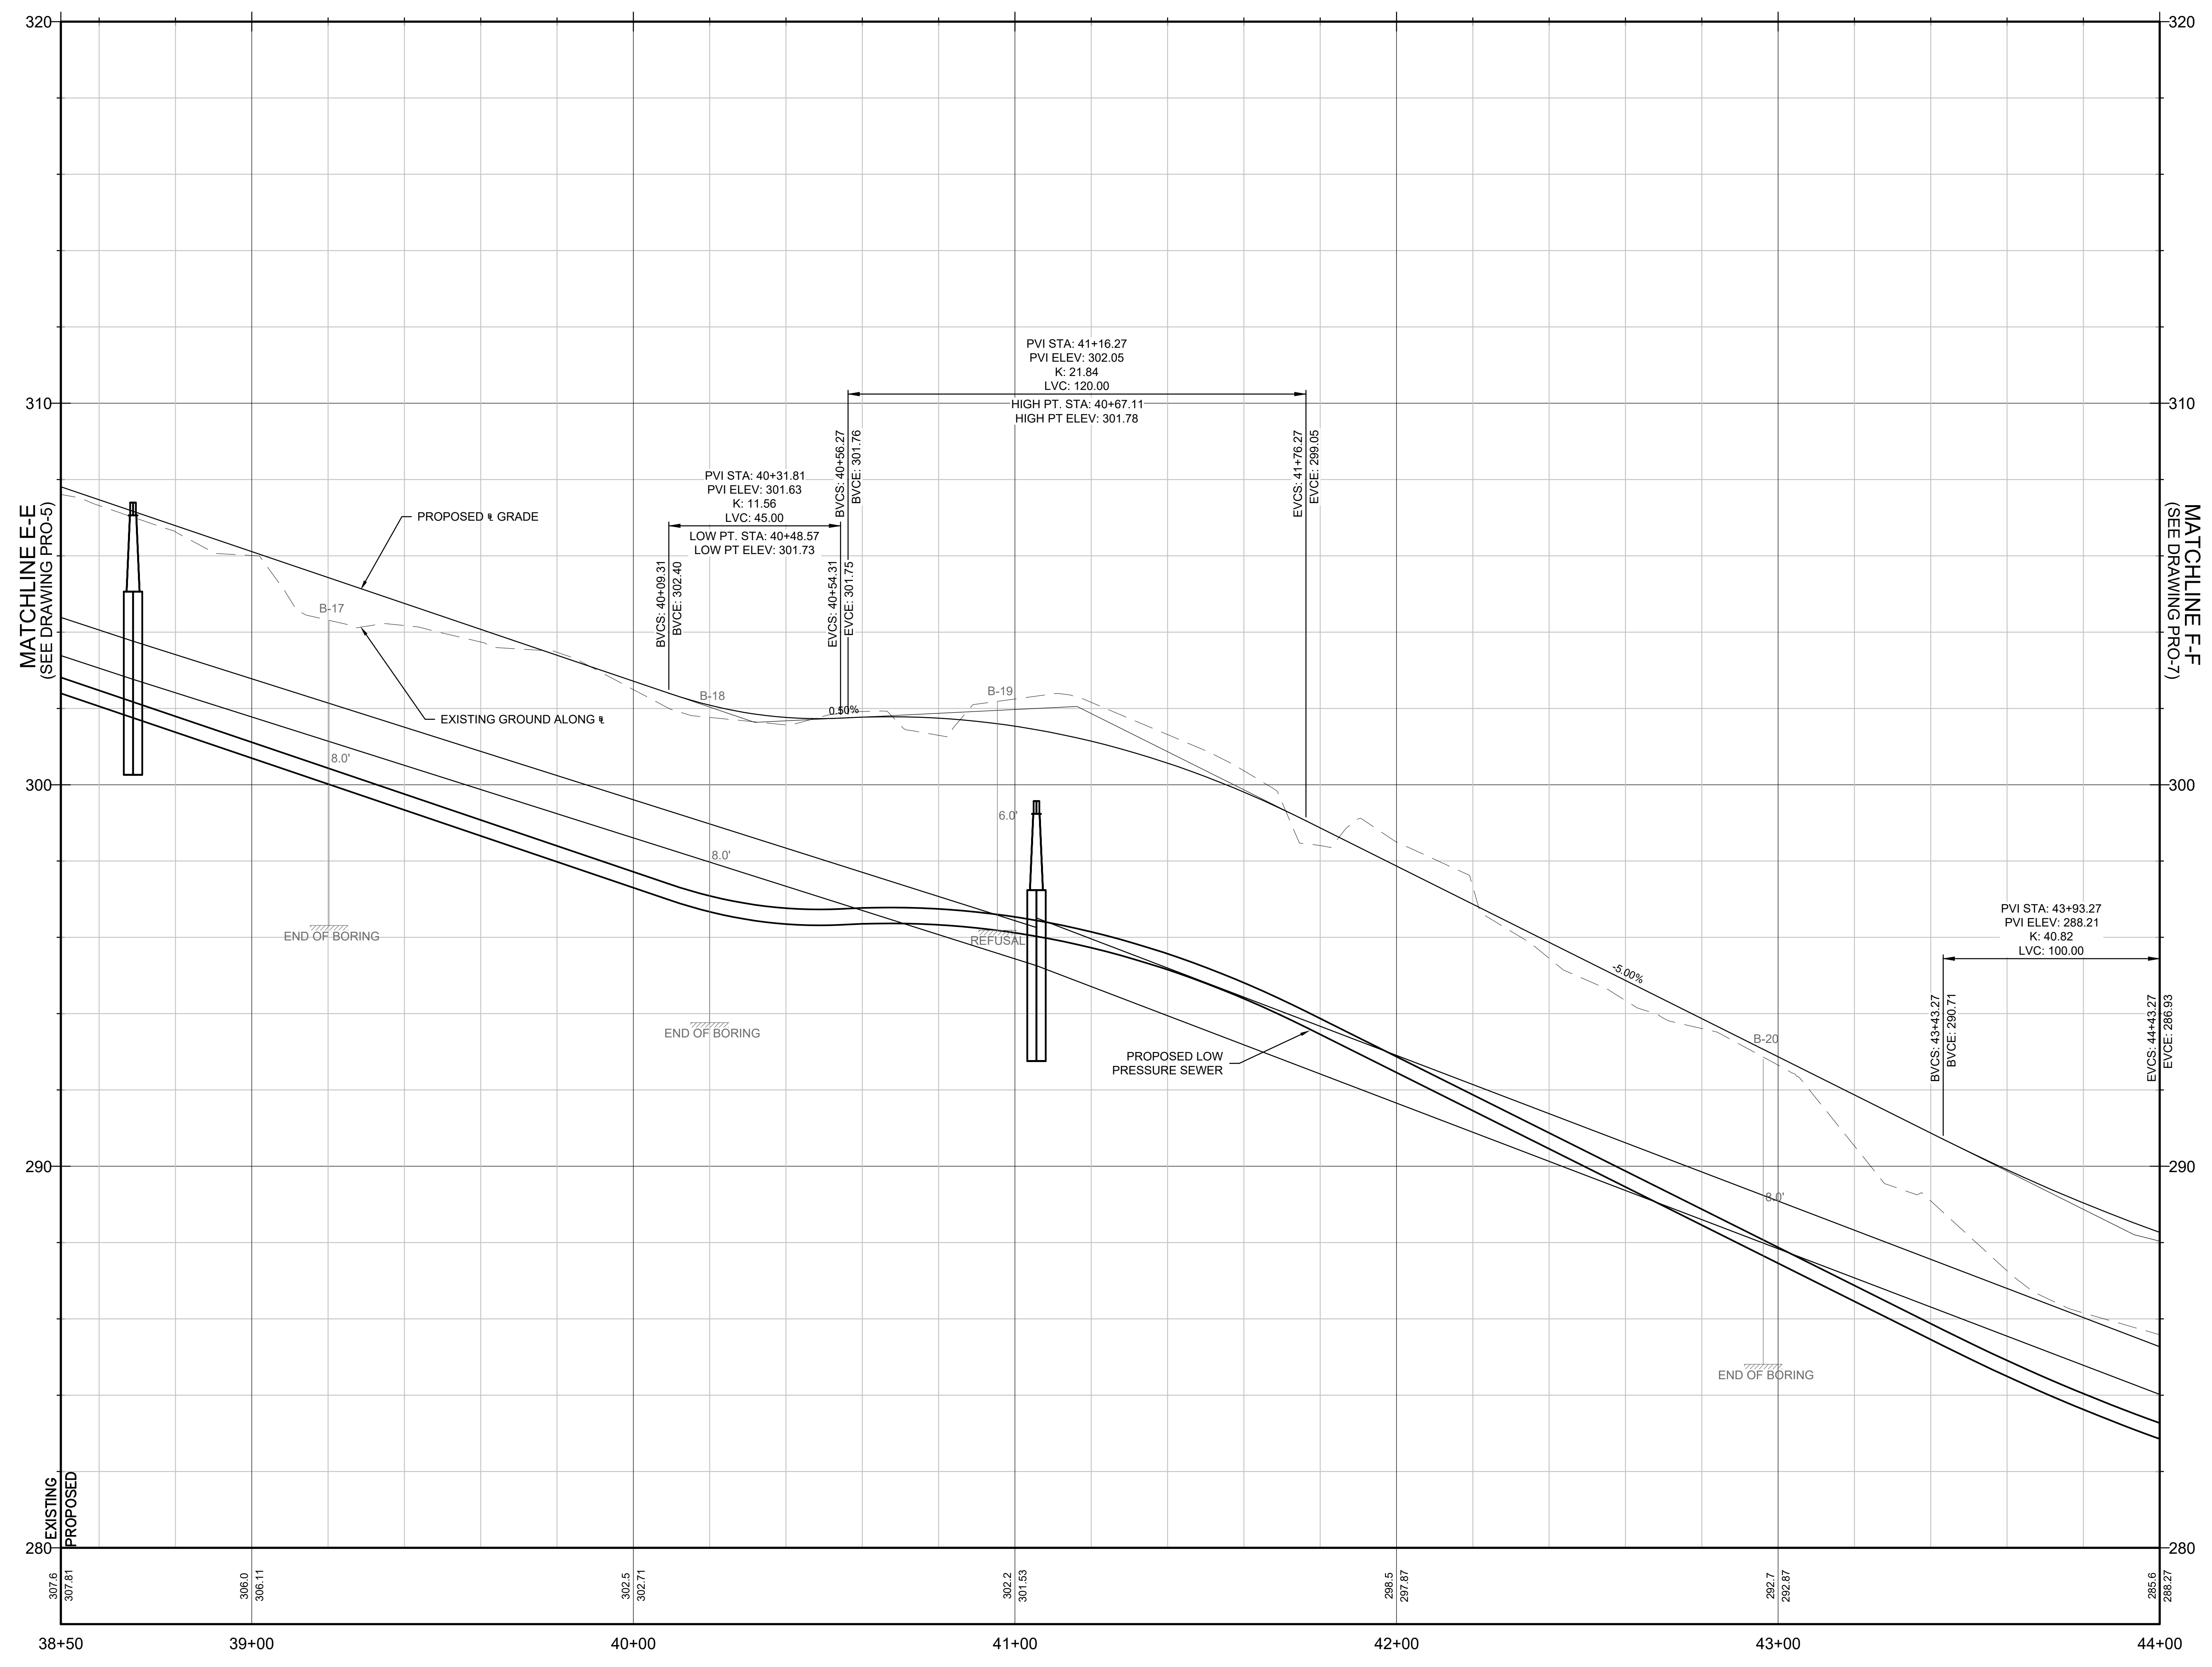
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Drawing Title:
**MULTI-USE PATHWAY
PROFILE
STA. 38+50 TO 44+00**

Sheet Number:
PRO-06



CENTERLINE TRAIL PROFILE
SCALE: 1"=20' HORZ, 1"=2' VERT

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Rev: 1.6 Date: 04/10/2019

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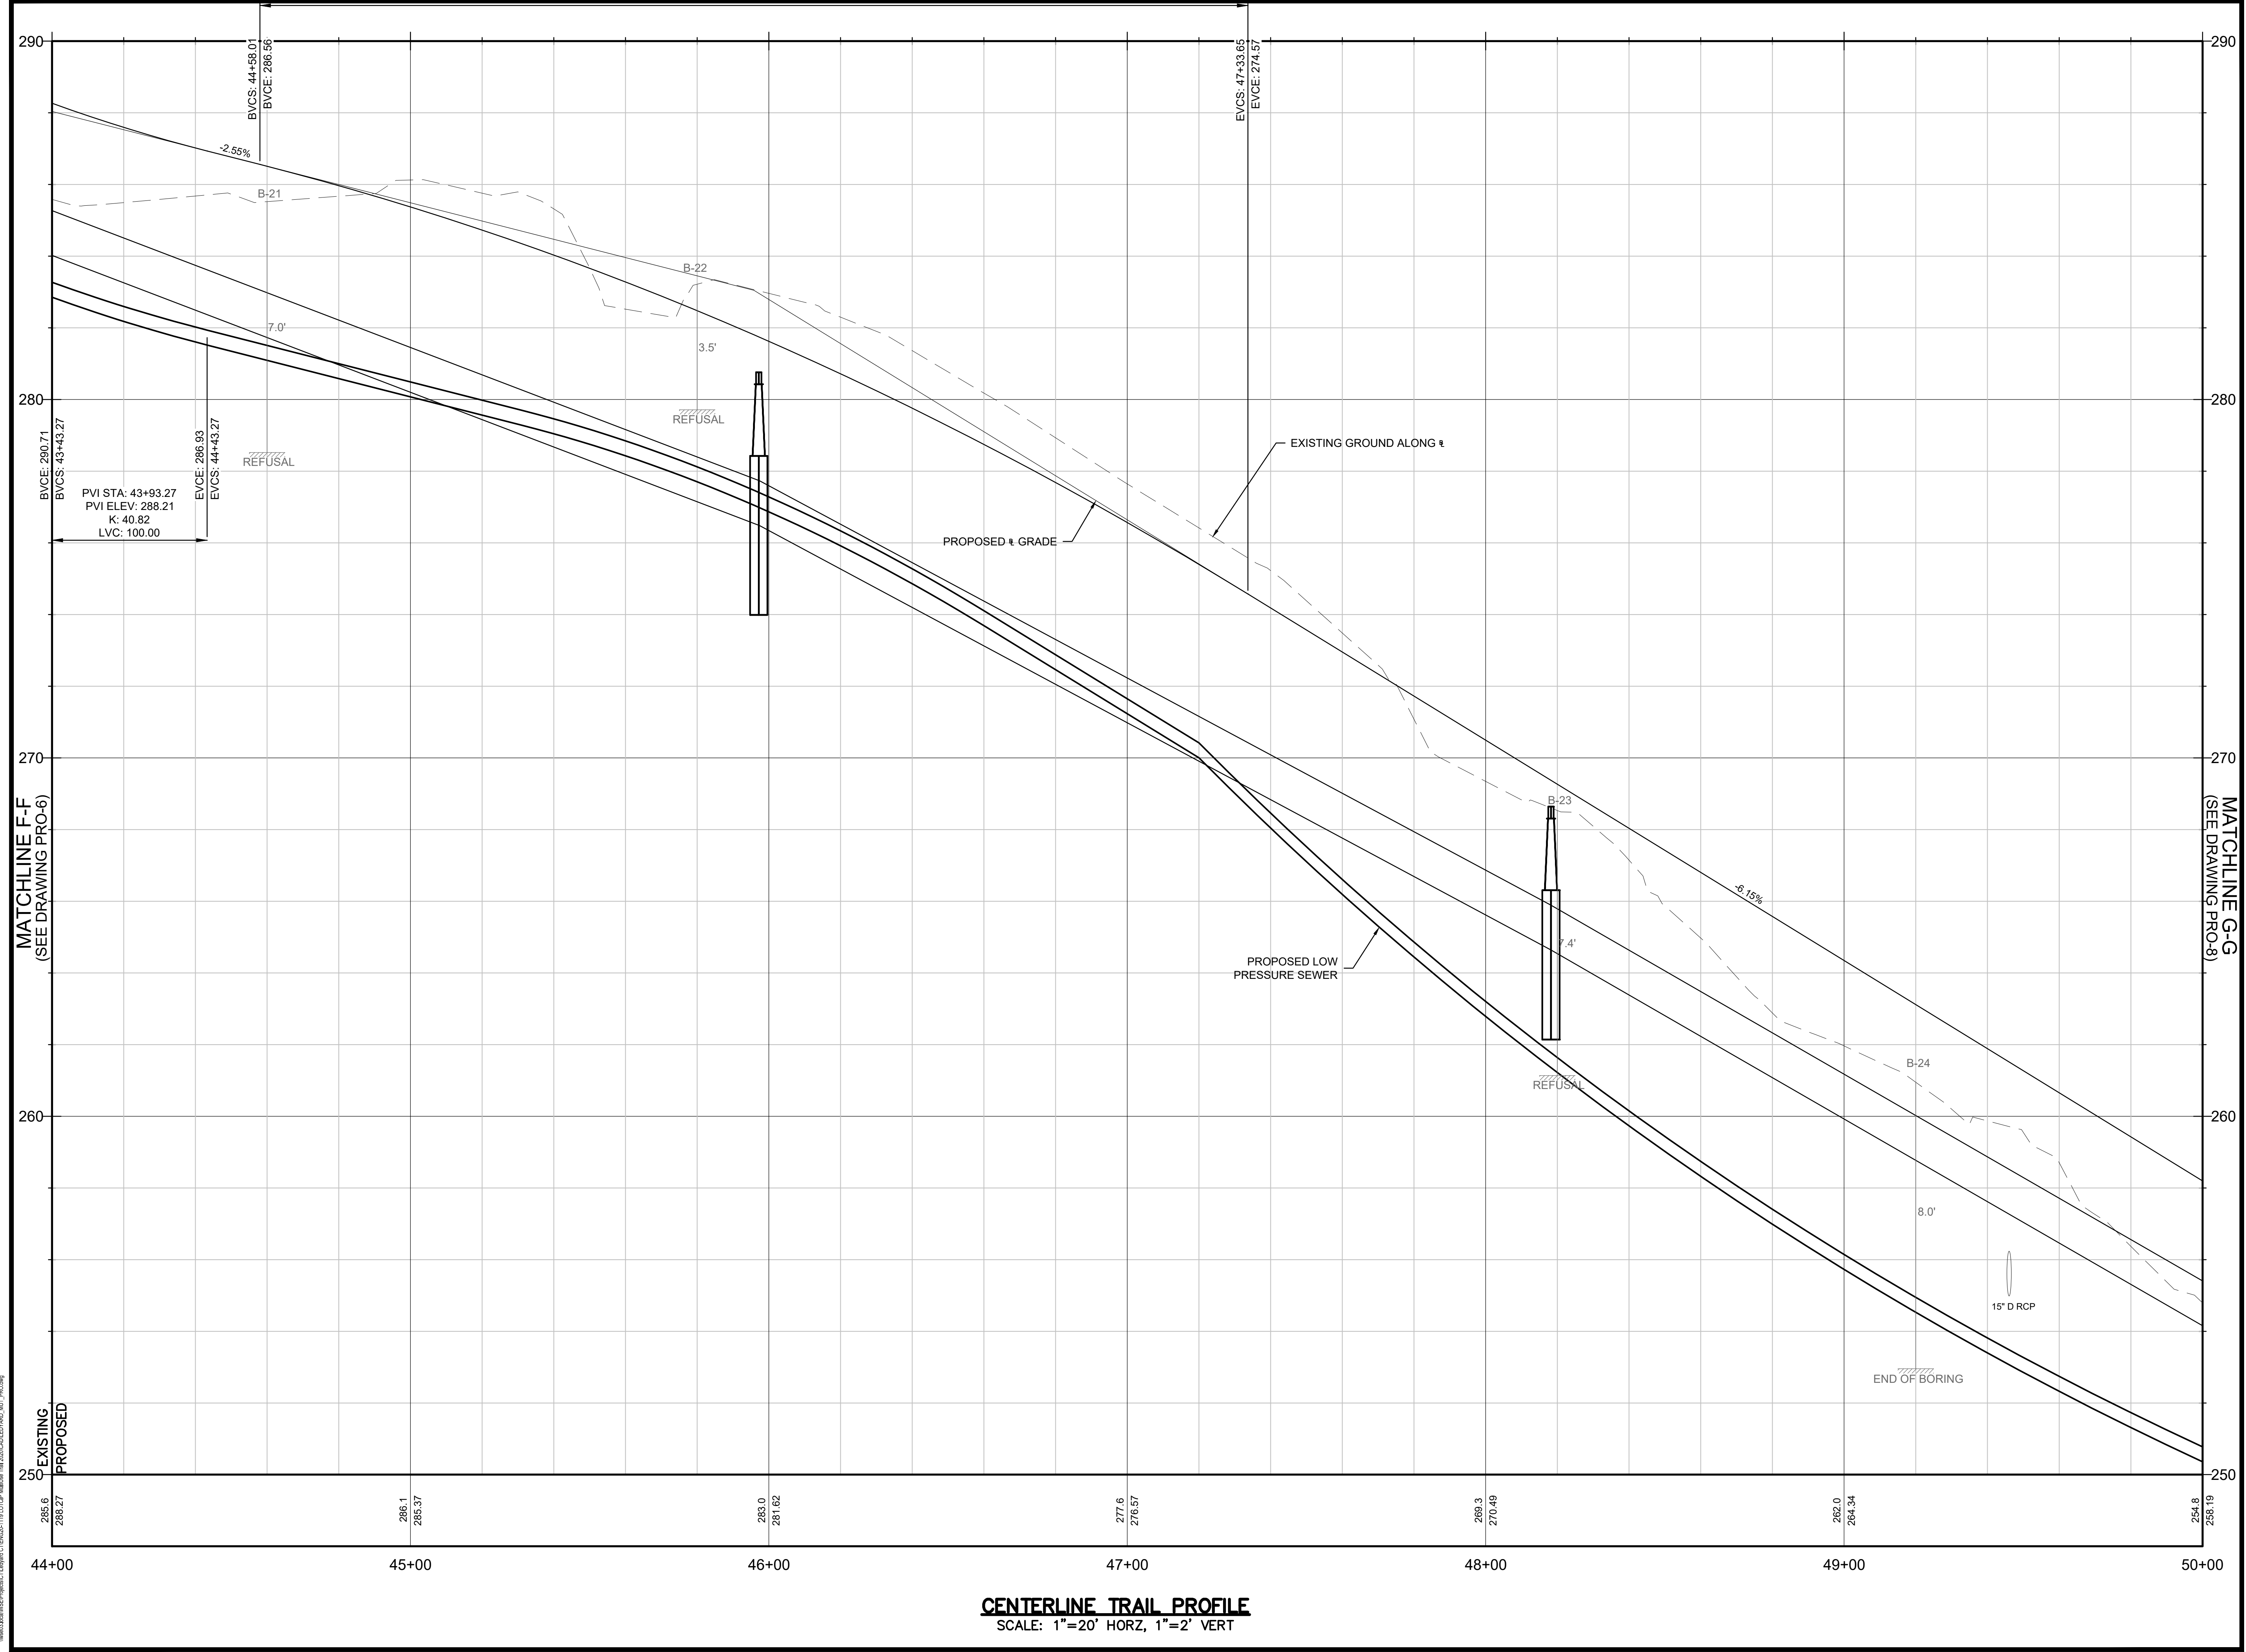
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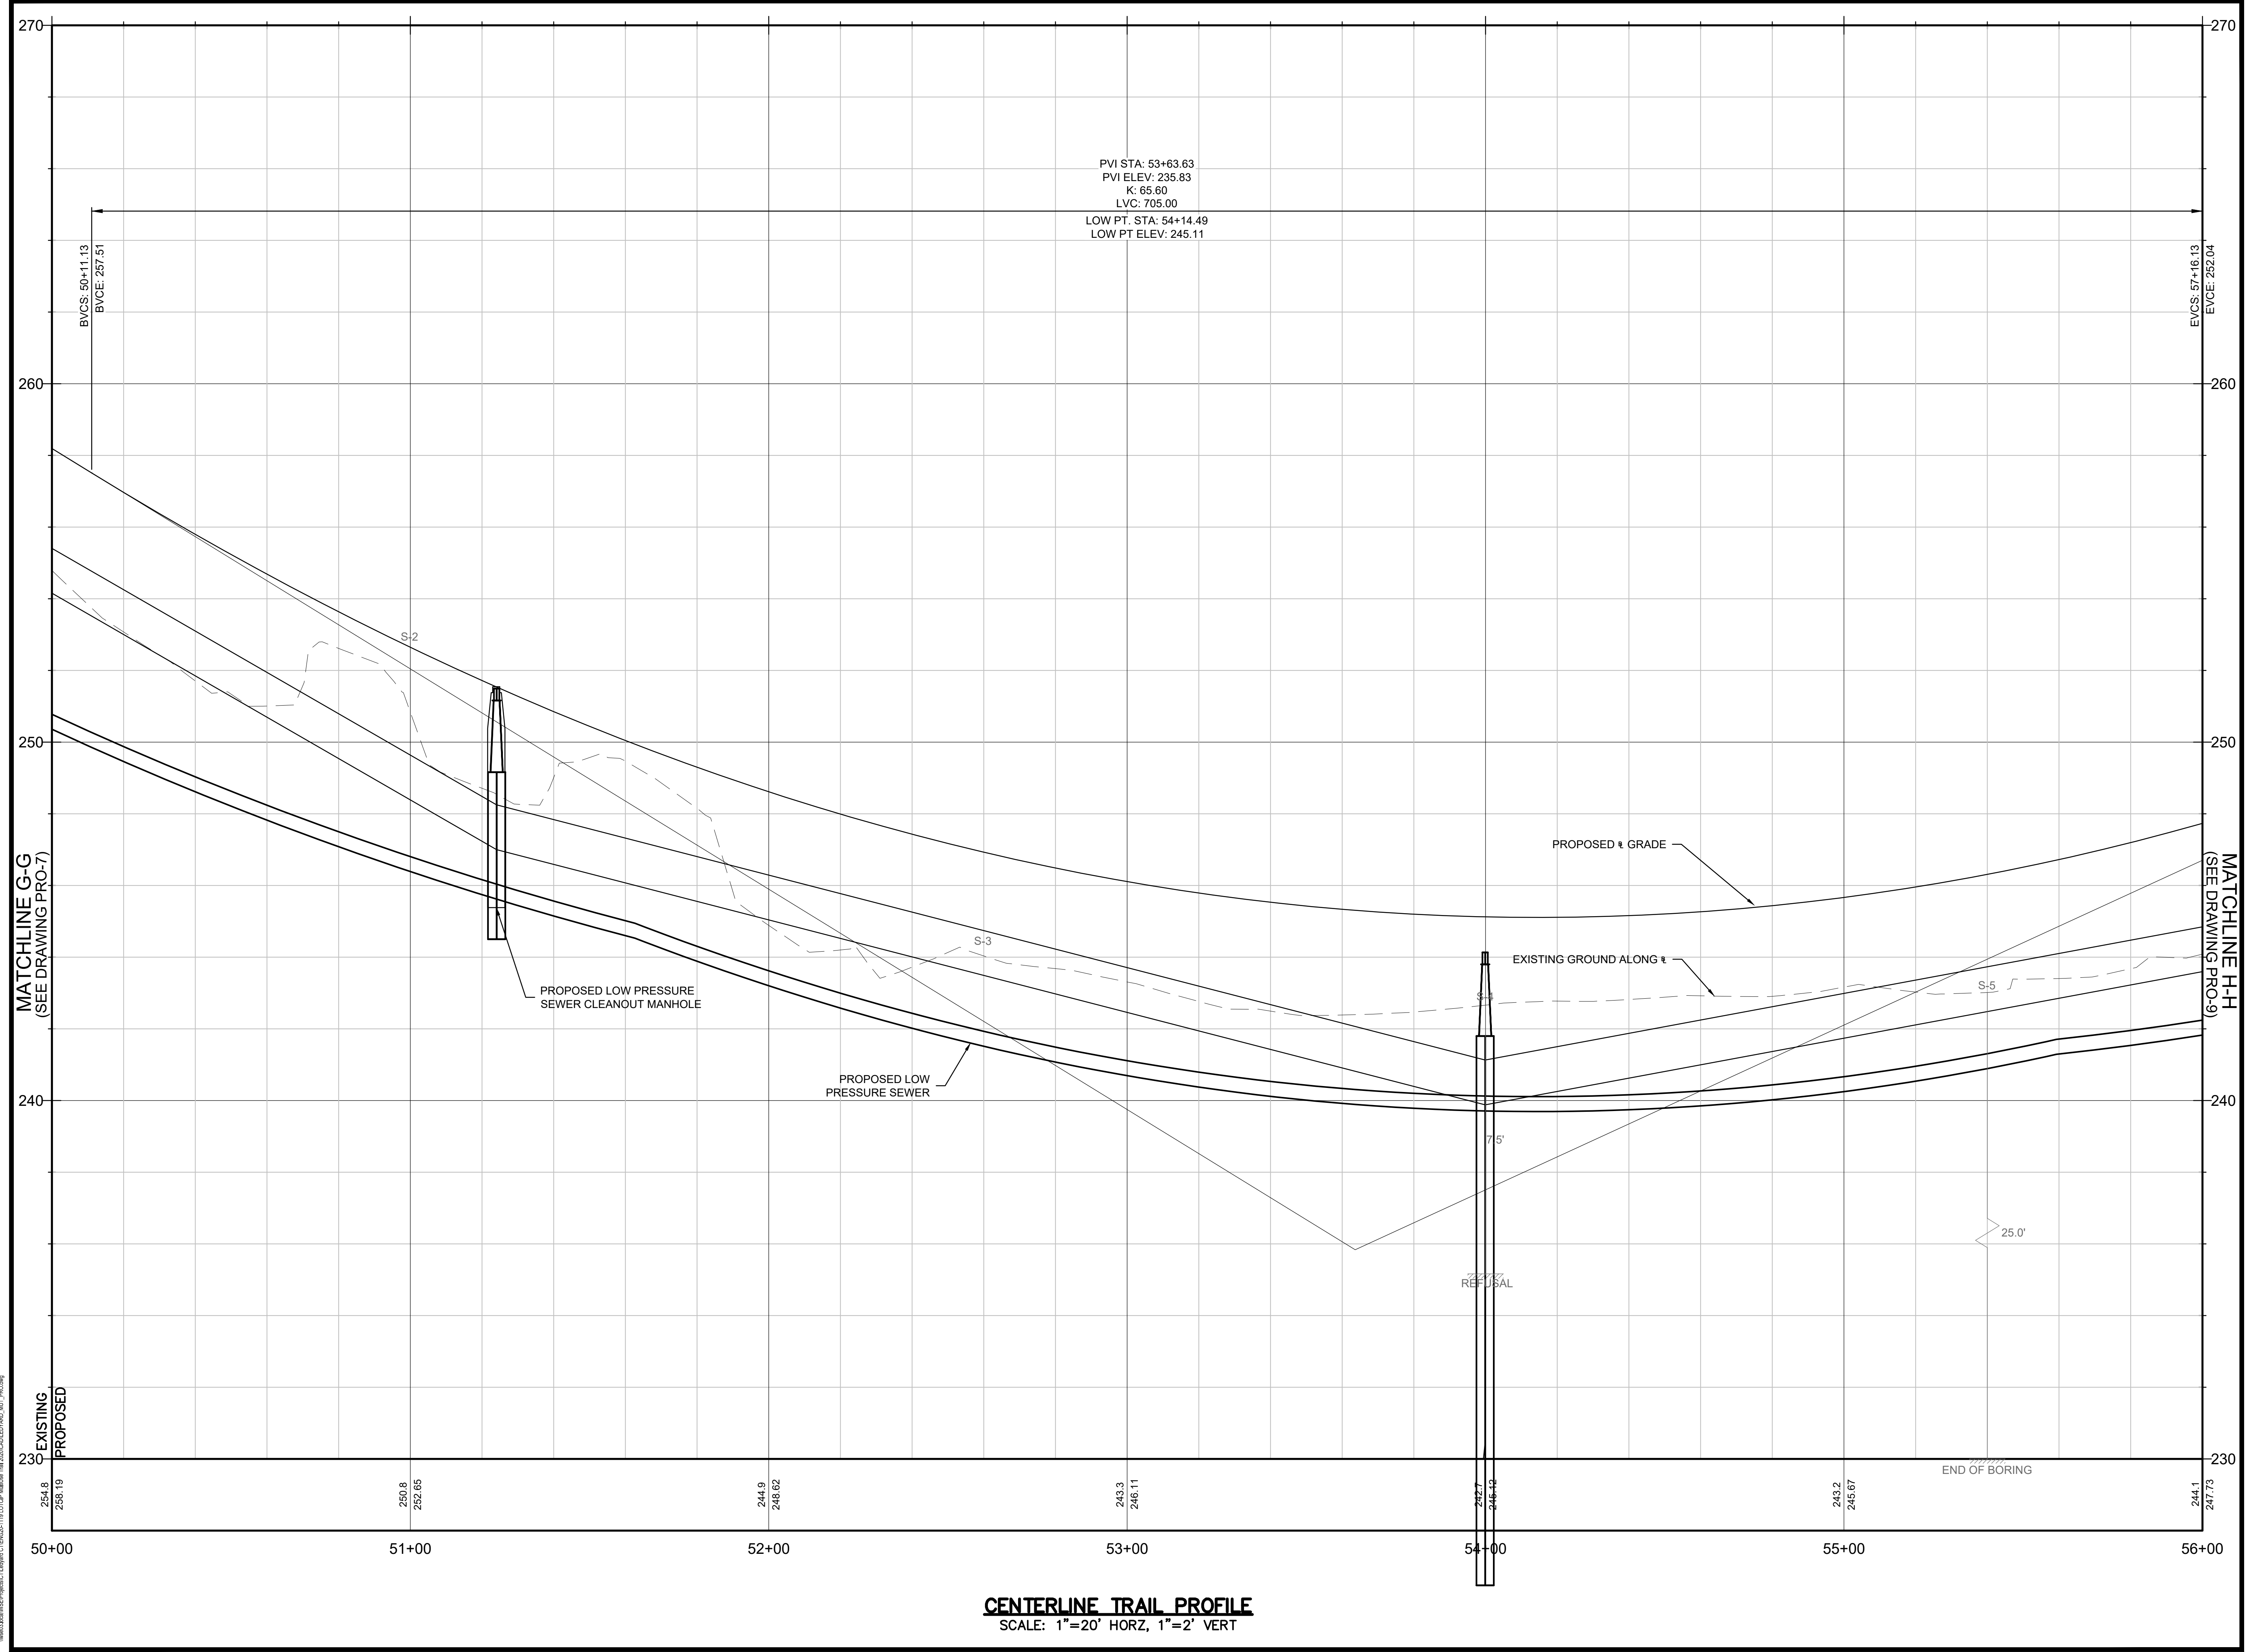
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Drawing Title:
**MULTI-USE PATHWAY
PROFILE
STA. 44+00 TO 50+00**
Sheet Number:
PRO-07




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CENTERLINE TRAIL PROFILE
SCALE: 1"=20' HORIZ, 1"=2' VERT

Project:
TOWN OF LEDYARD, CT



LEDYARD HIGH SCHOOL
MULTI-USE PATHWAY &
SIDEWALK EXTENSION
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LEDYARD, CT 06339

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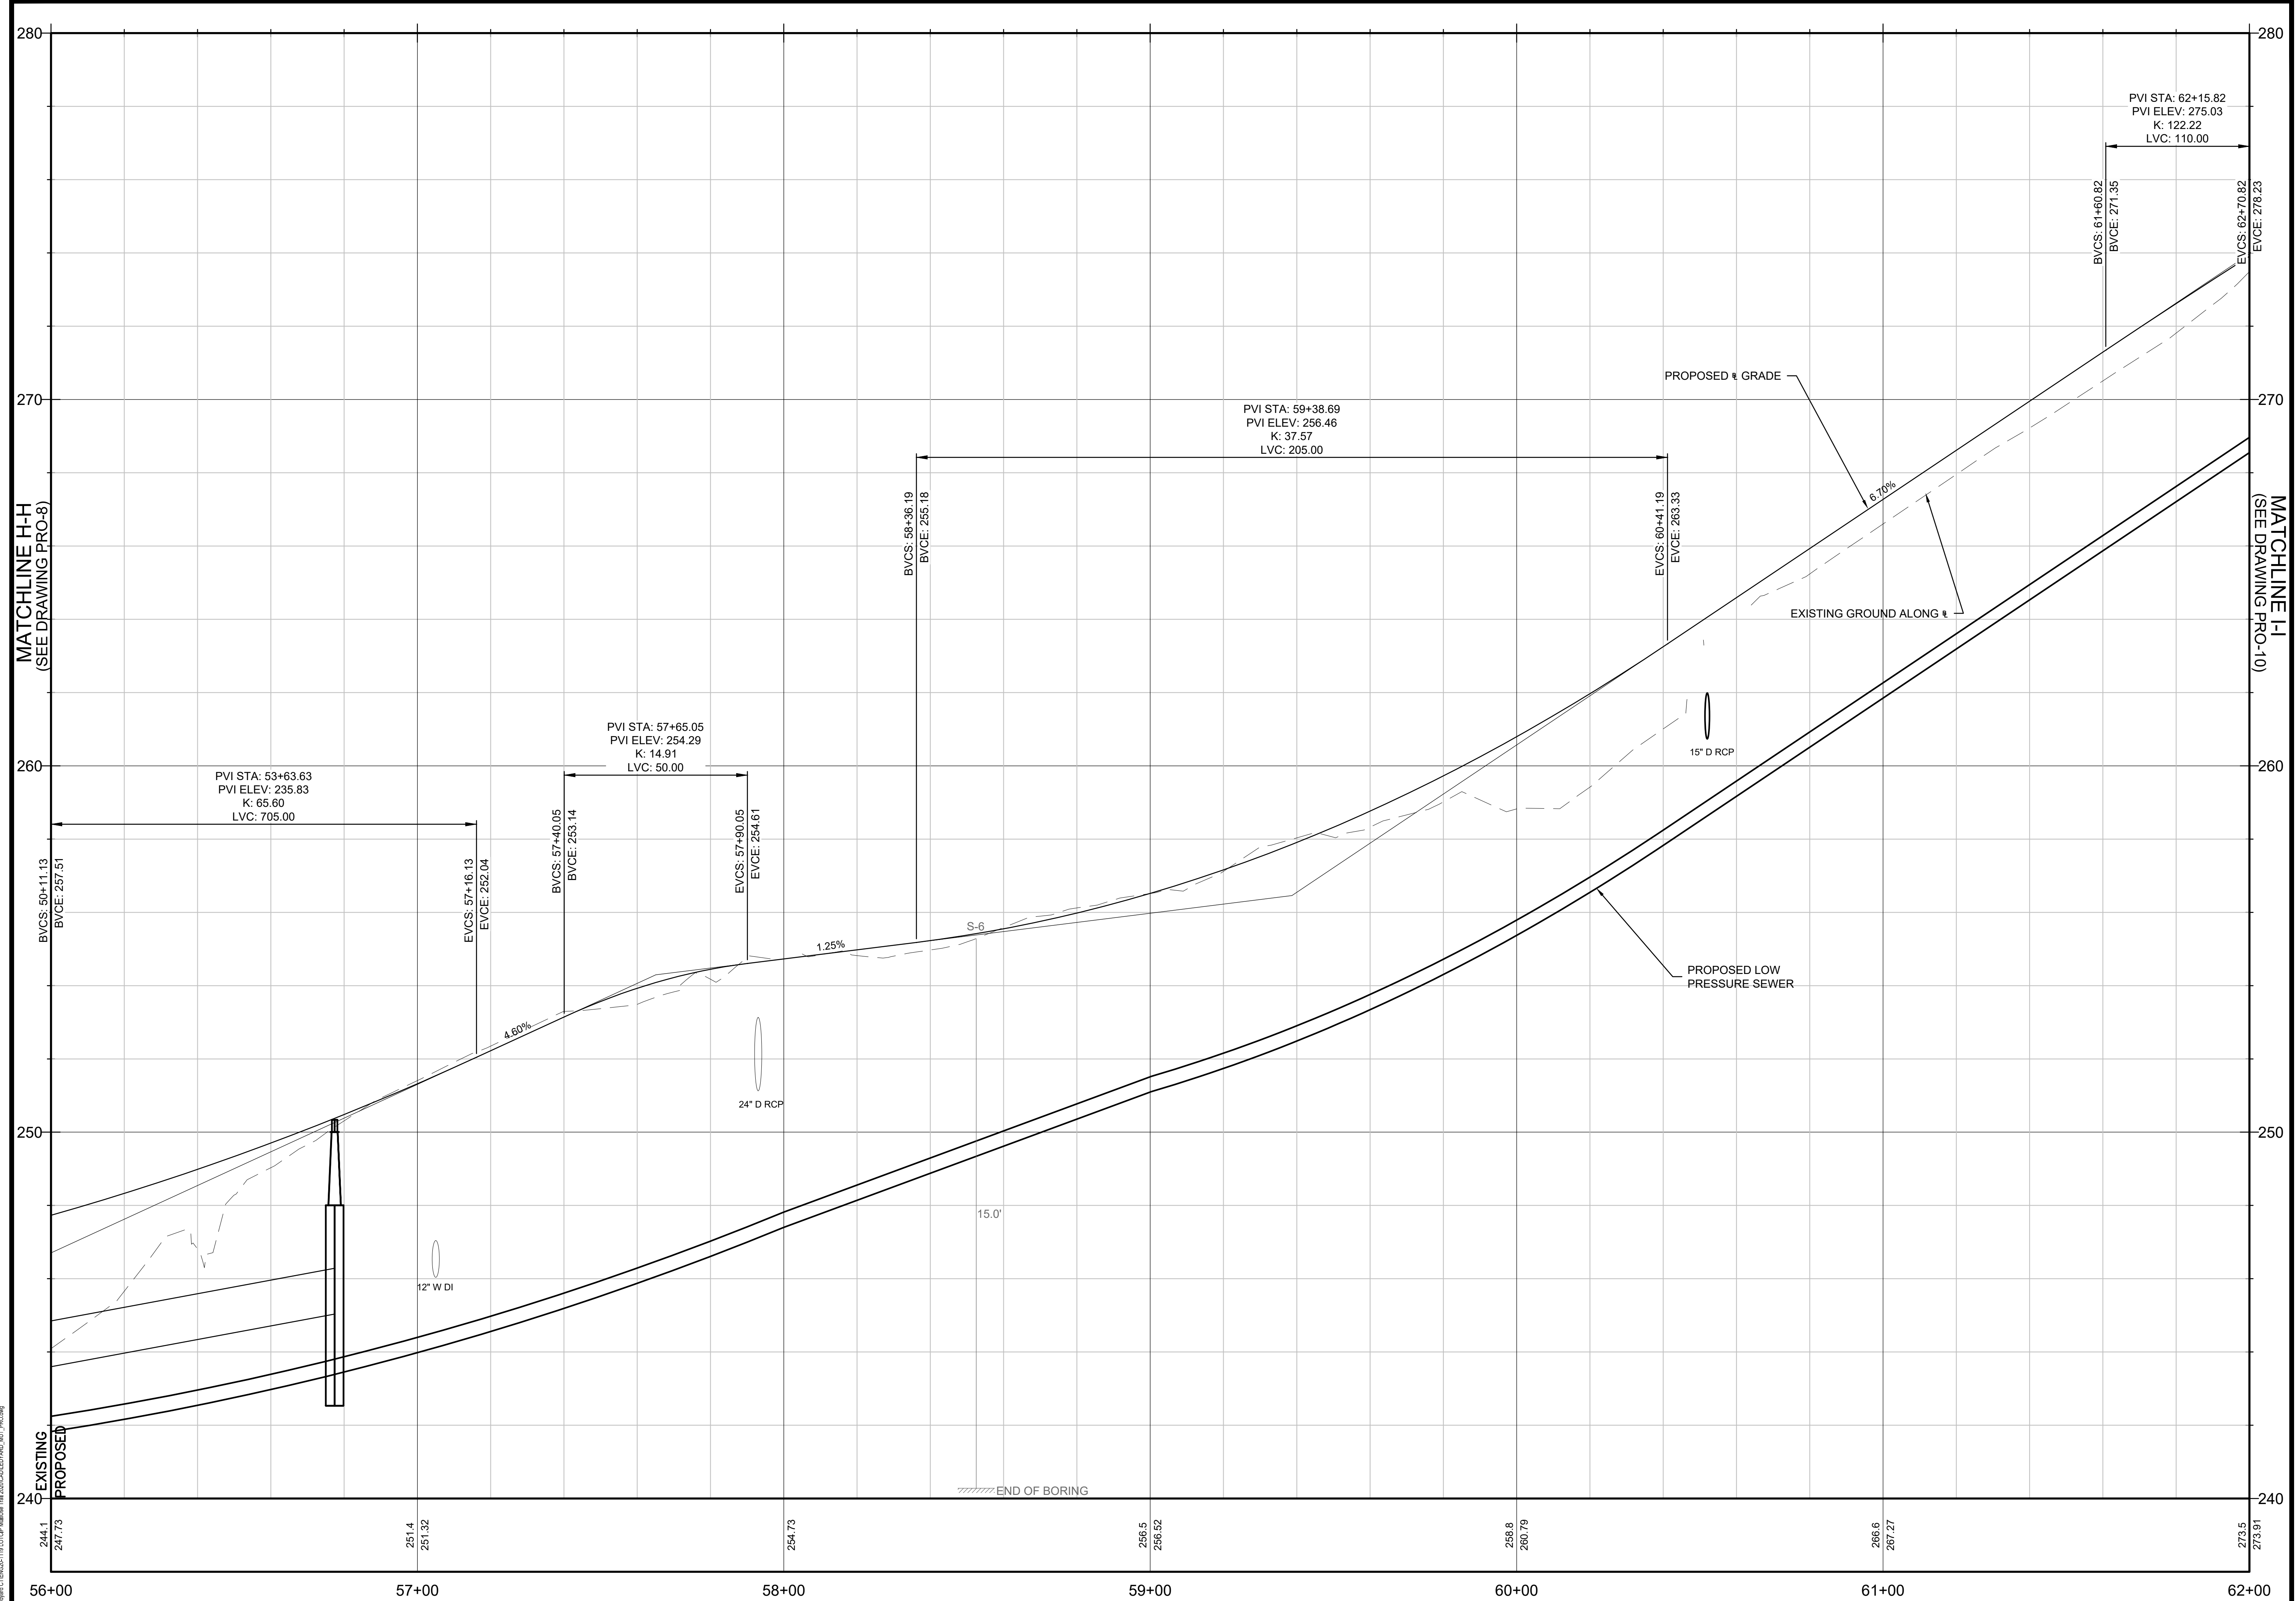
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Approved By: LAS
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W&S File No.:

Drawing Title:
**MULTI-USE PATHWAY
PROFILE
STA. 50+00 TO 56+00**

Sheet Number:
PRO-08


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Rev: 1.6 Date: 04/10/2019



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 SCALE: 1"=20' HORZ, 1"=2' VERT

Project:
 TOWN OF LEDYARD, CT



LEDYARD HIGH SCHOOL
 MULTI-USE PATHWAY &
 SIDEWALK EXTENSION
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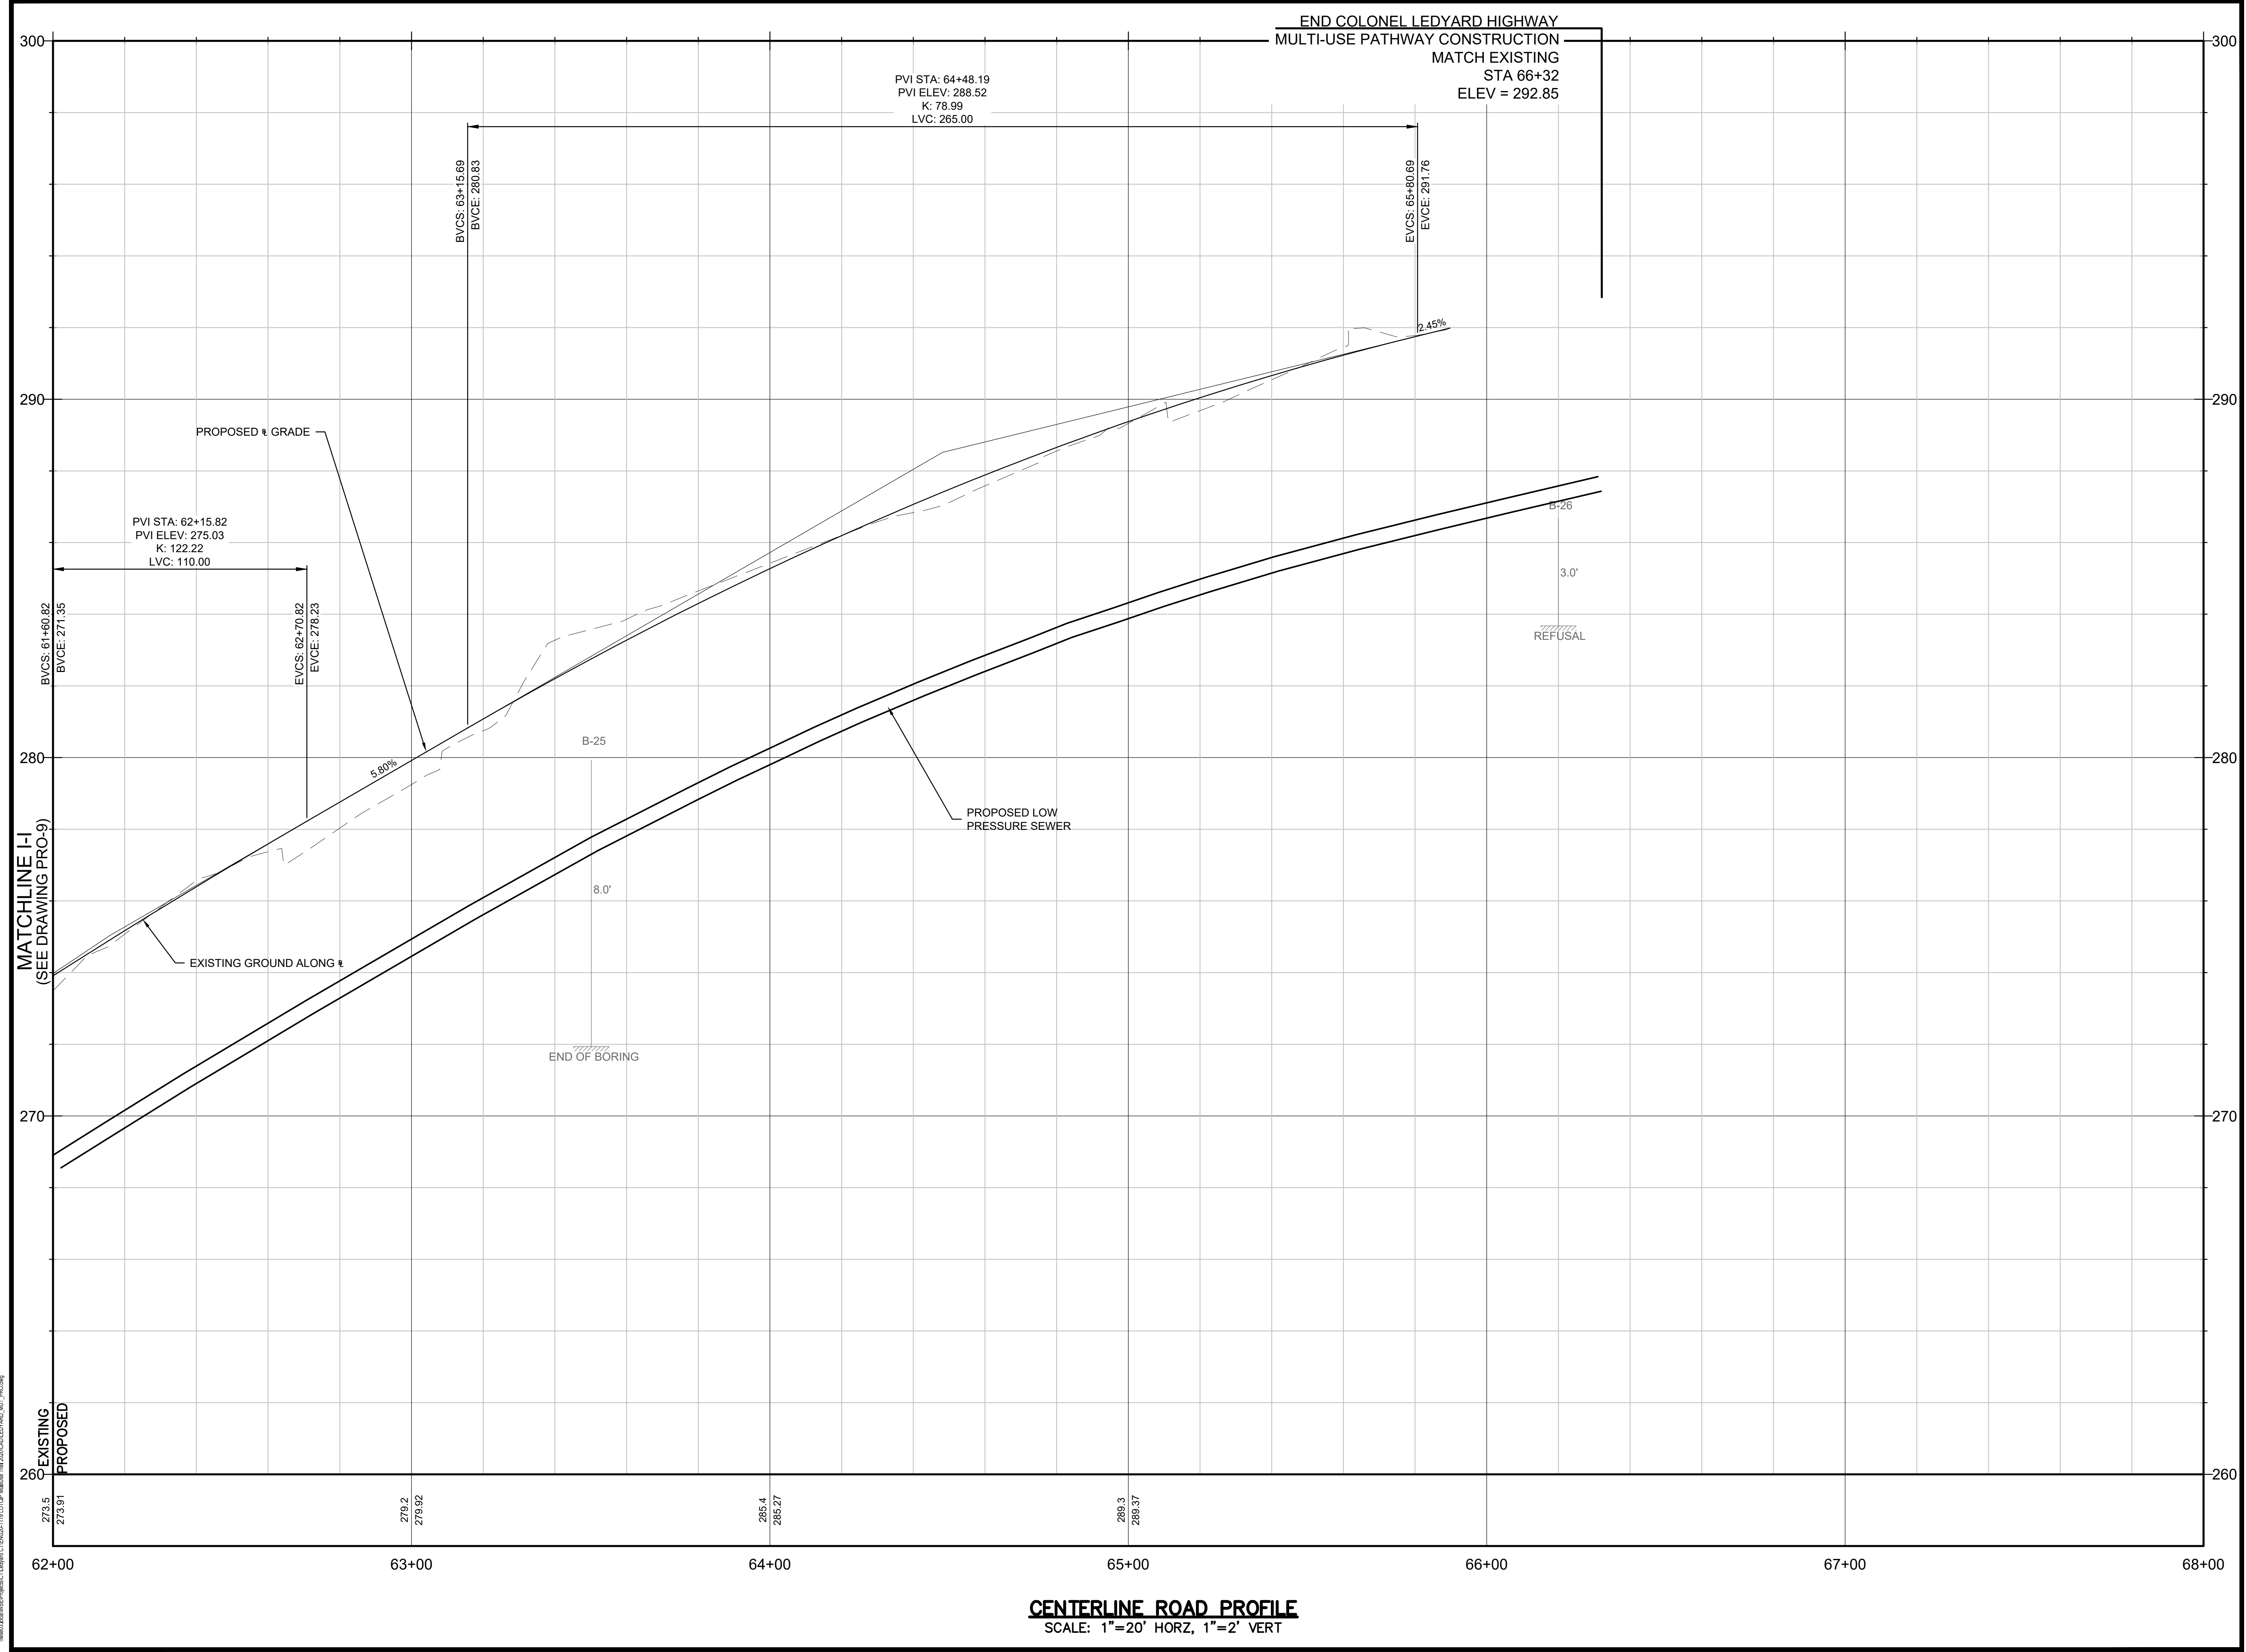
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 Reviewed By: RC
 Approved By: LAS
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 W&S File No.:

Drawing Title:
**MULTI-USE PATHWAY
 PROFILE
 STA. 56+00 TO 62+00**

Sheet Number:
PRO-09

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Project:
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LEDYARD HIGH SCHOOL
MULTI-USE PATHWAY &
SIDEWALK EXTENSION

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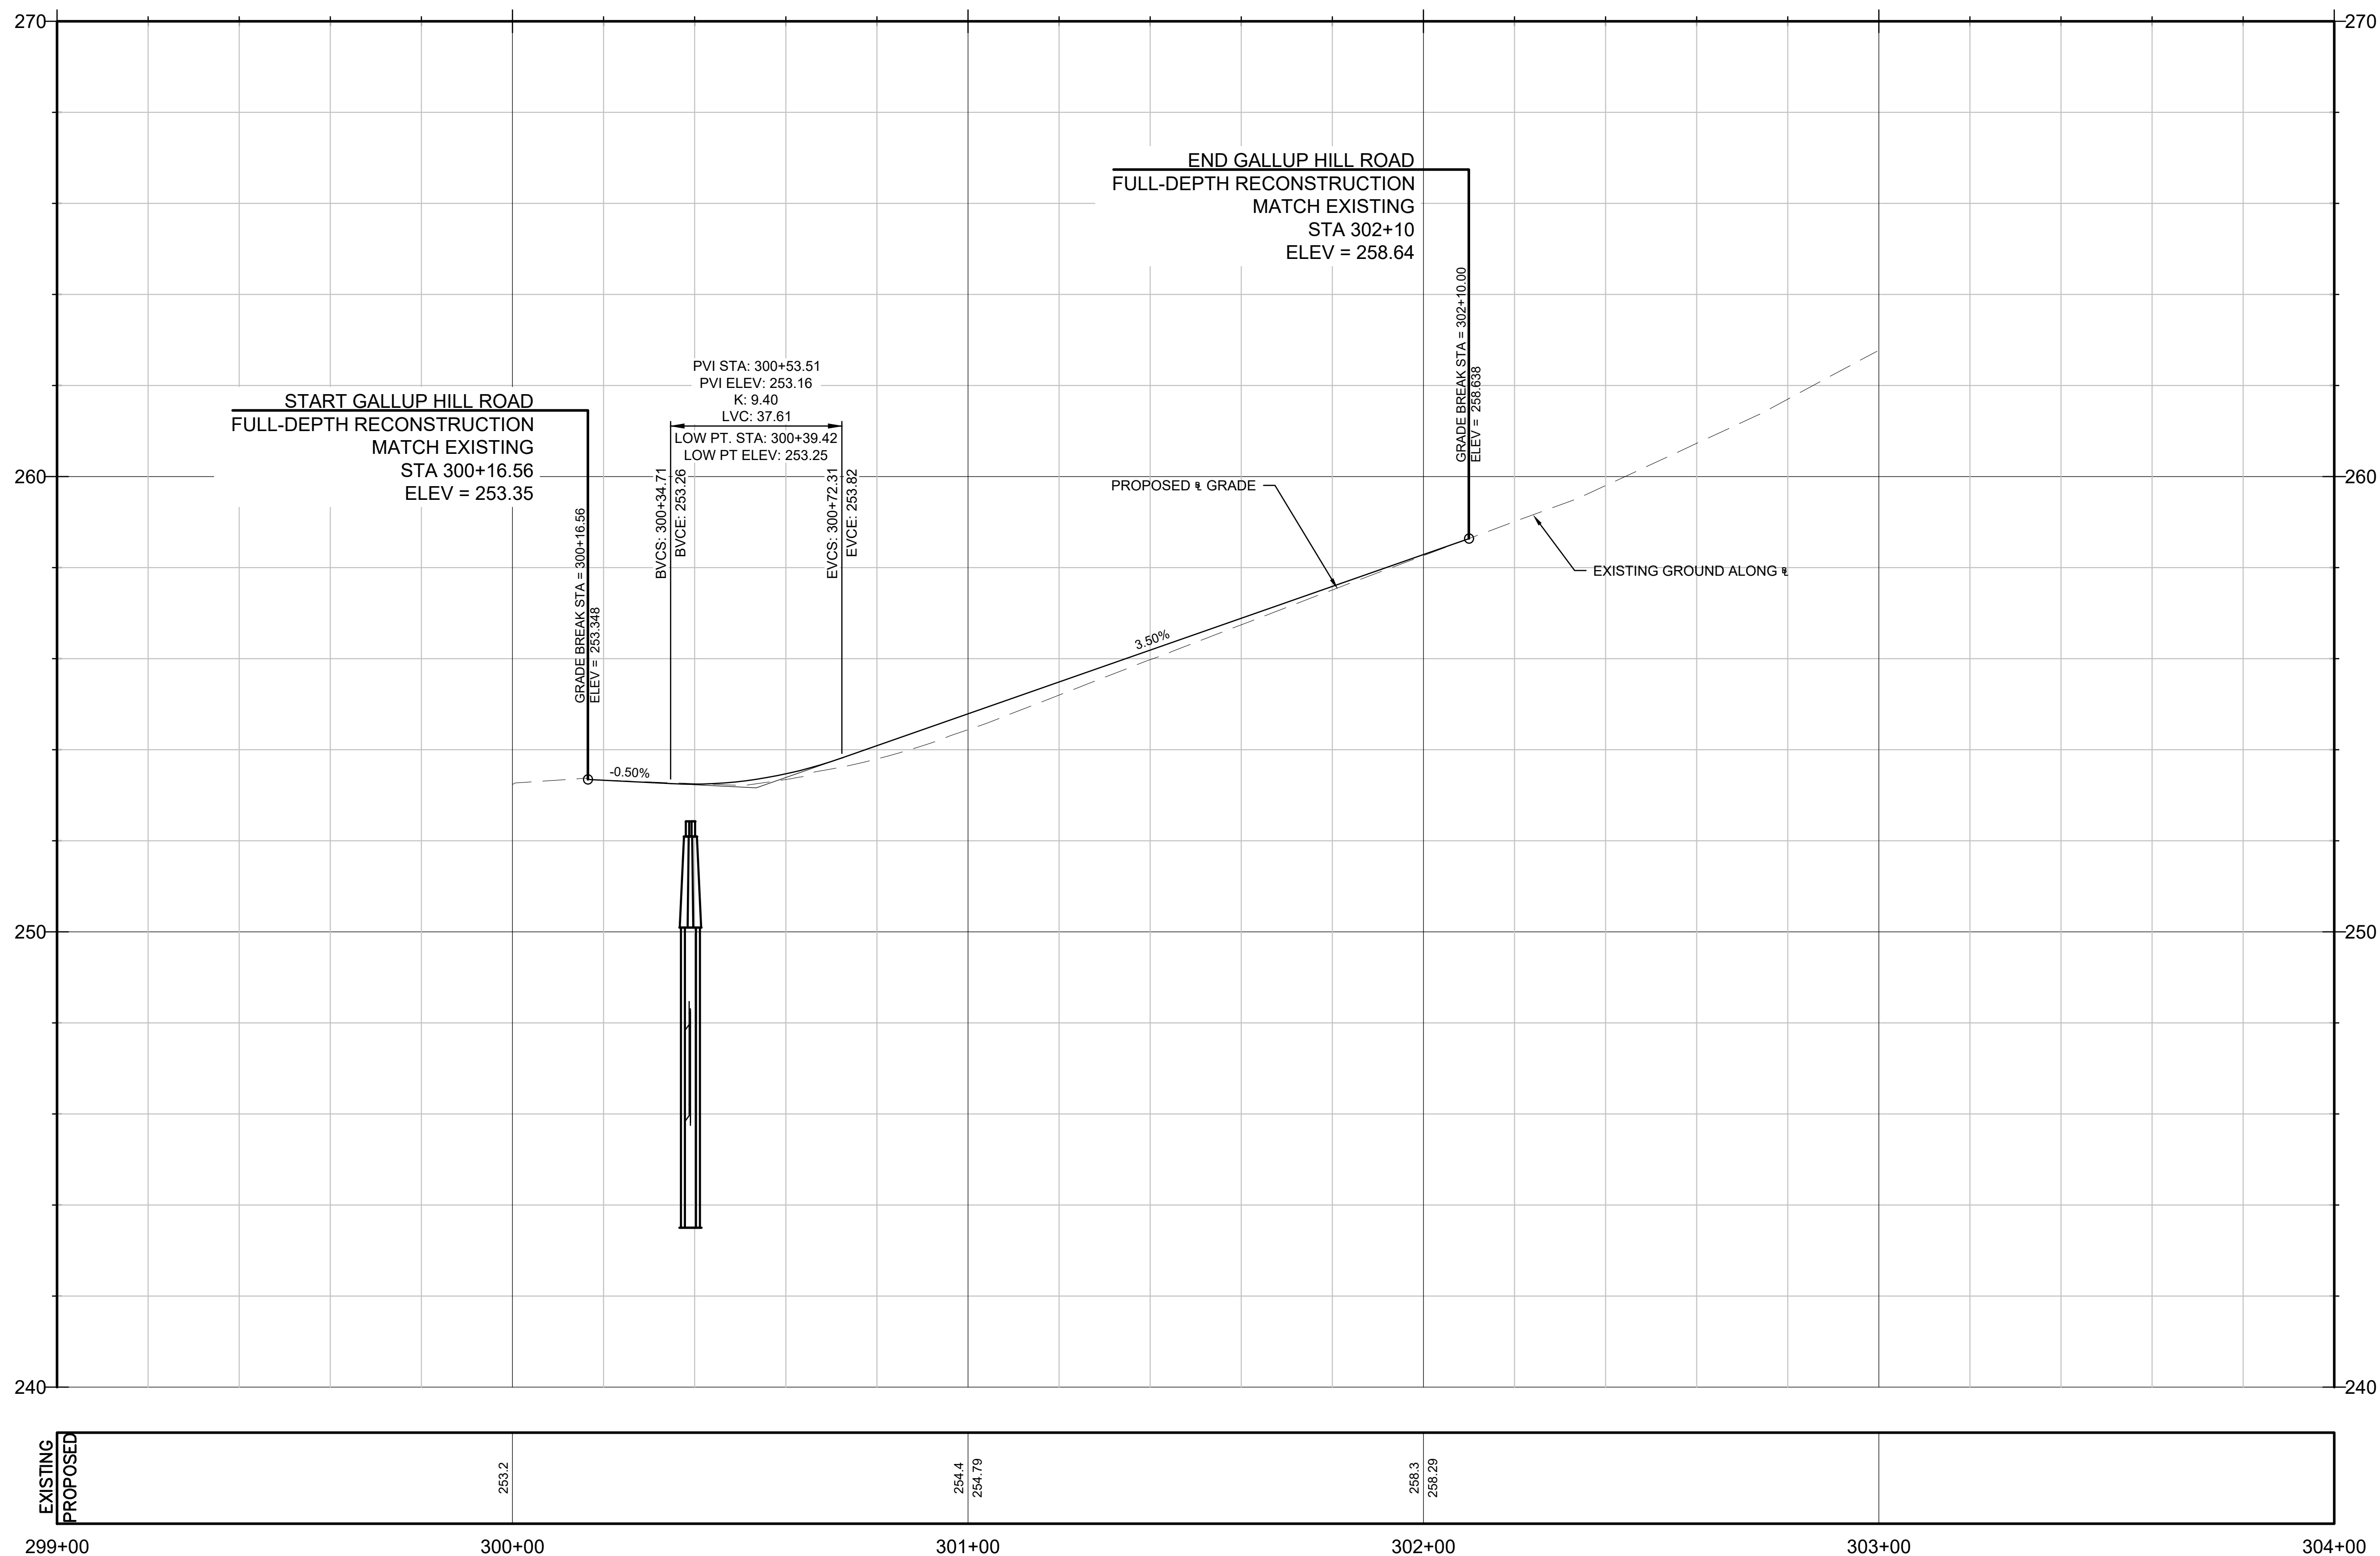
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Reviewed By: RC
Approved By: LAS
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W&S File No.:

Drawing Title:
MULTI-USE PATHWAY PROFILE
STA. 62+00 TO 68+00

Sheet Number:
PRO-10

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CENTERLINE ROAD PROFILE
 SCALE: 1"=20' HORZ, 1"=2' VERT

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 W&S File No.:

Drawing Title:
**GALLUP HILL ROAD
 PROFILE
 STA. 300+00 TO
 303+00**

Sheet Number:
PRO-11



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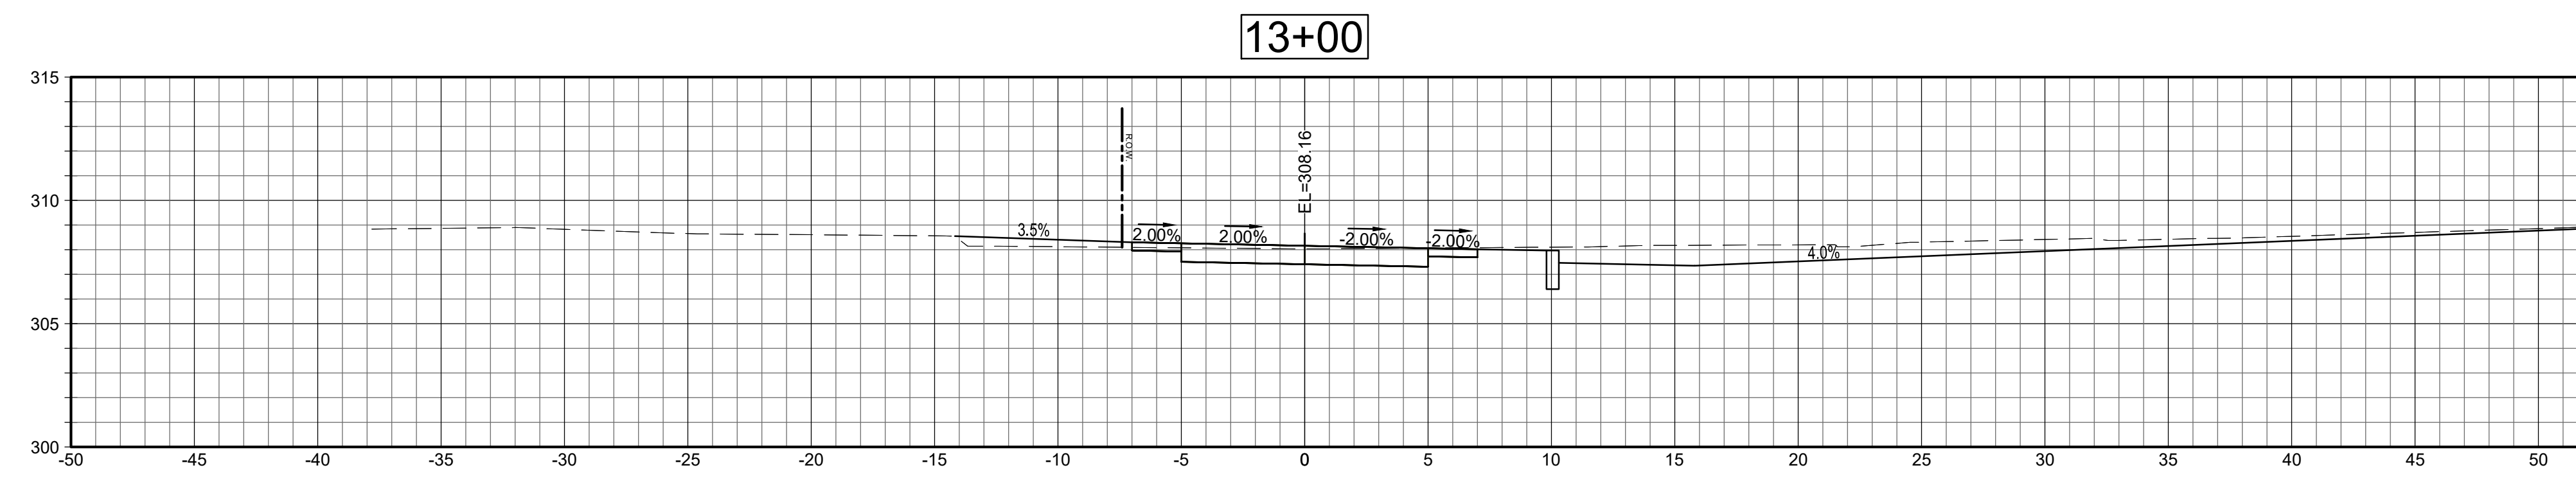
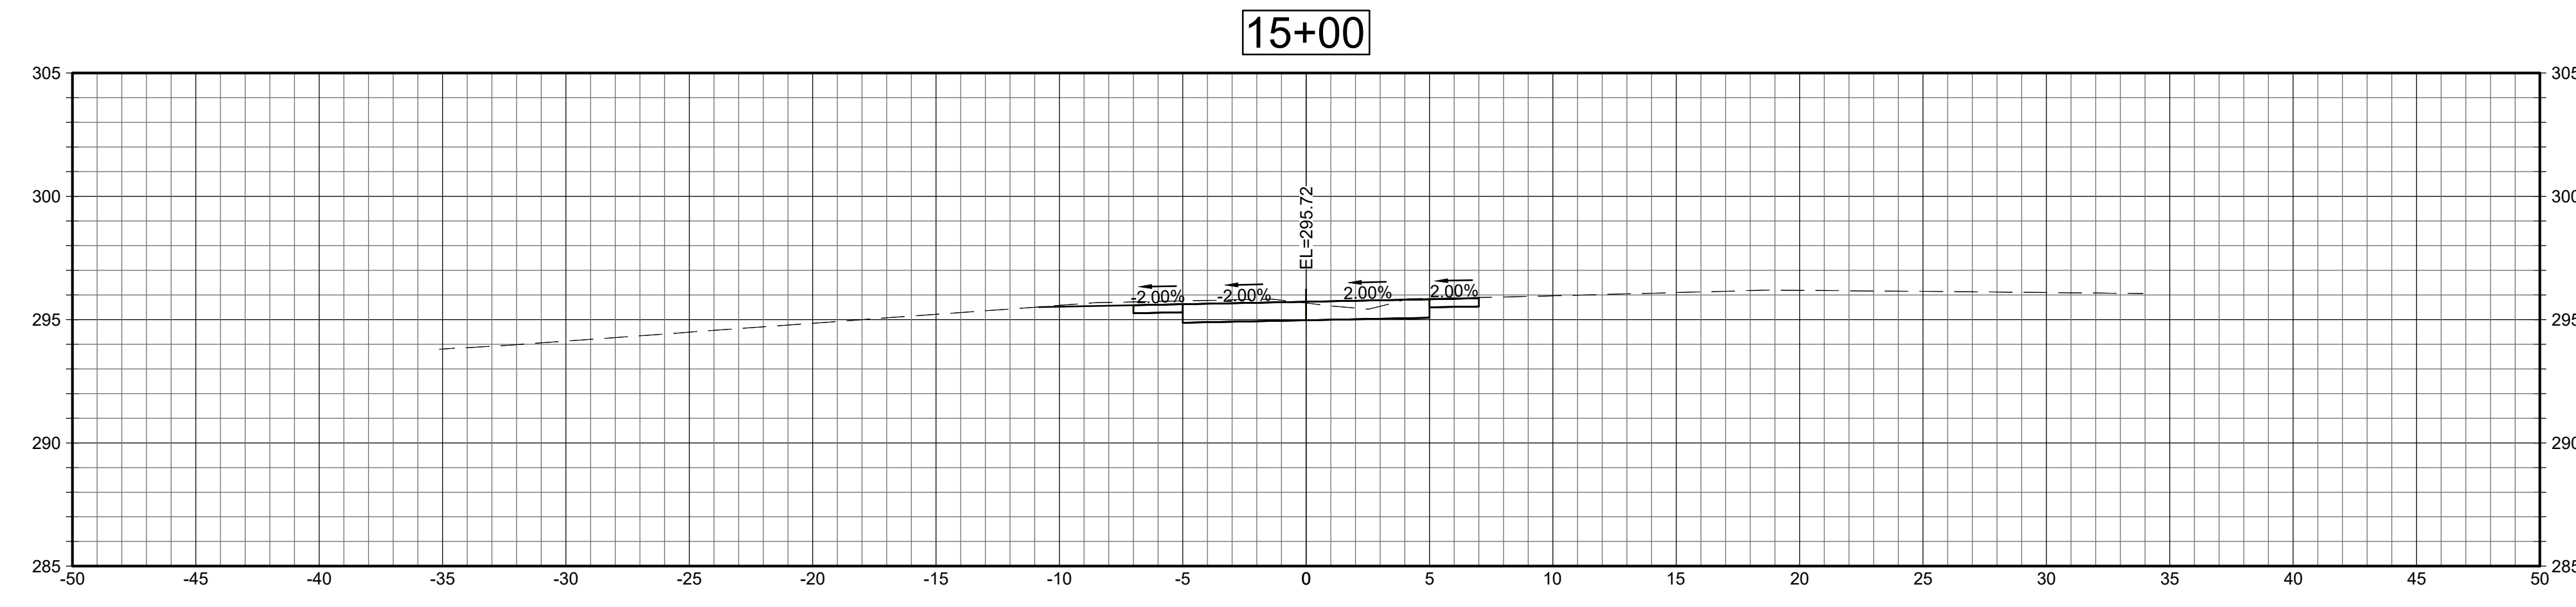
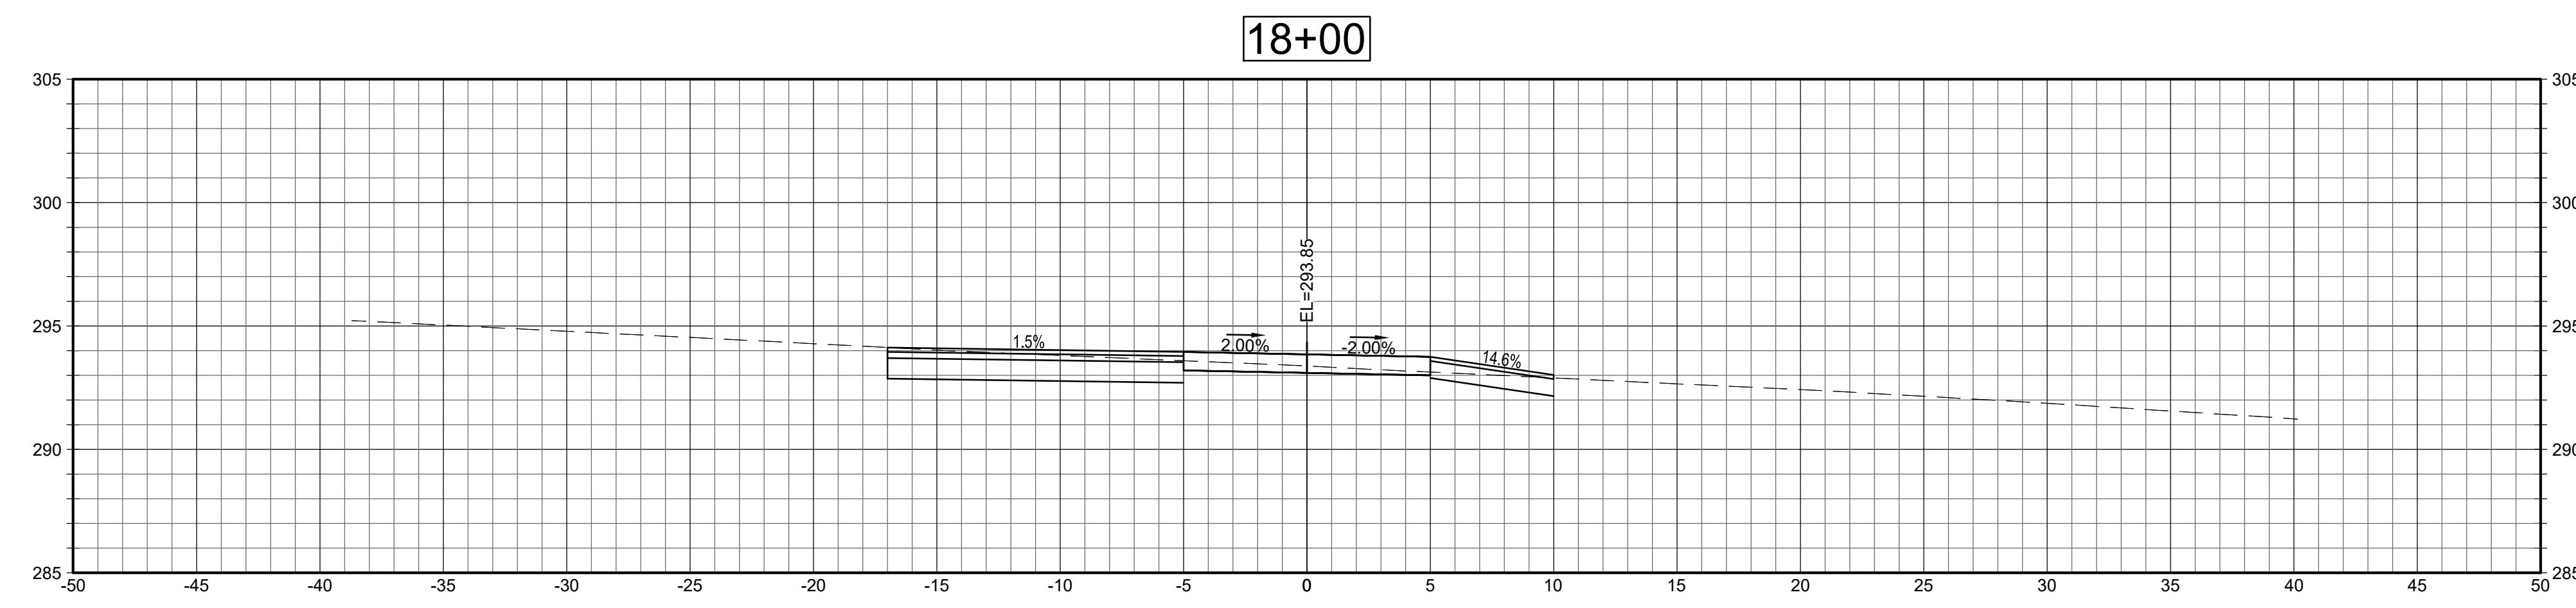
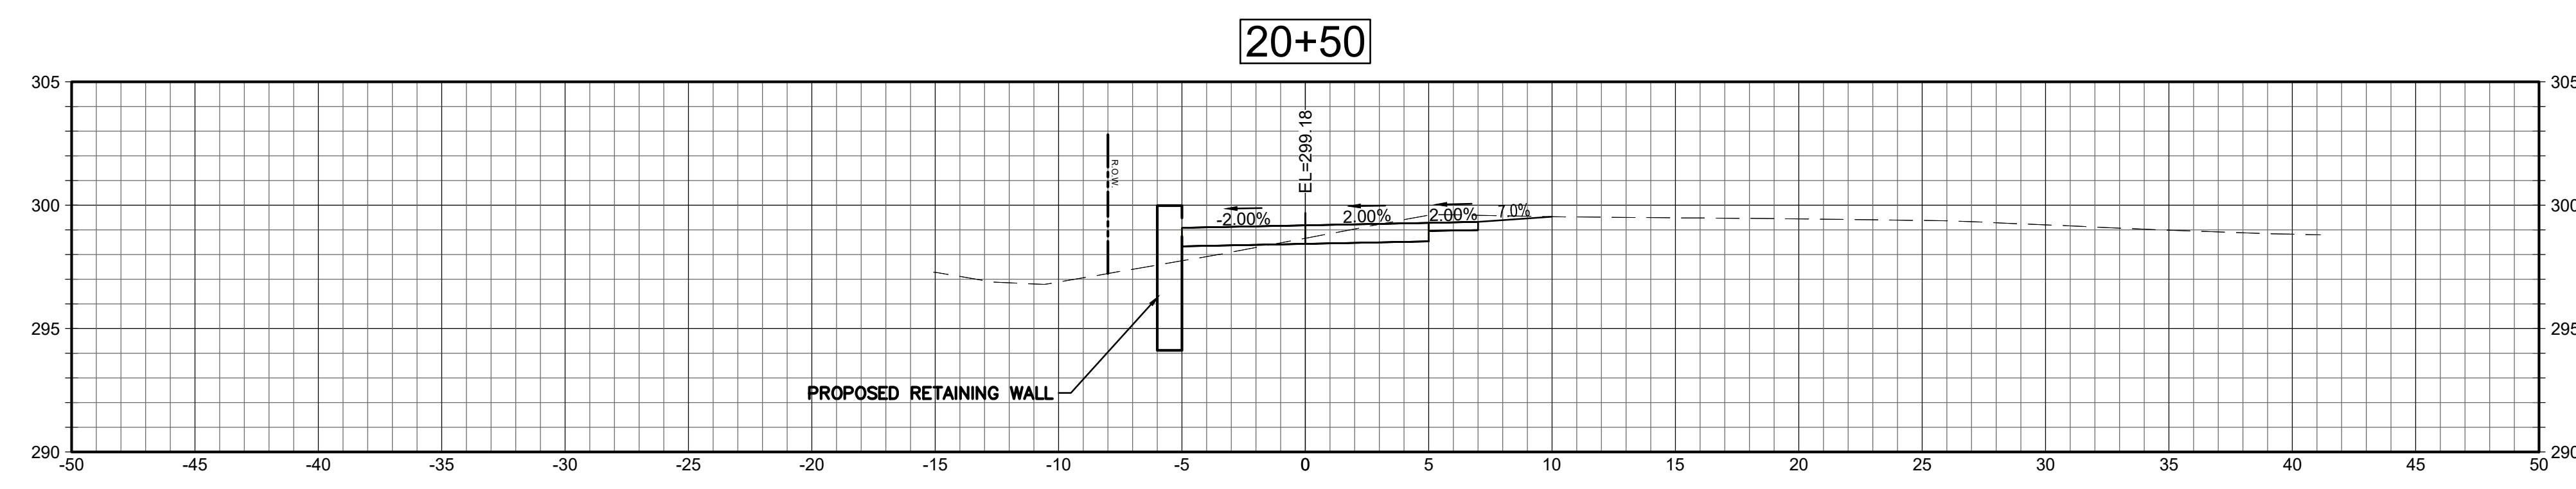
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**CRITICAL CROSS
SECTIONS**

Sheet Number:

XSC-1



SECTIONS

SCALE: 1"=5'





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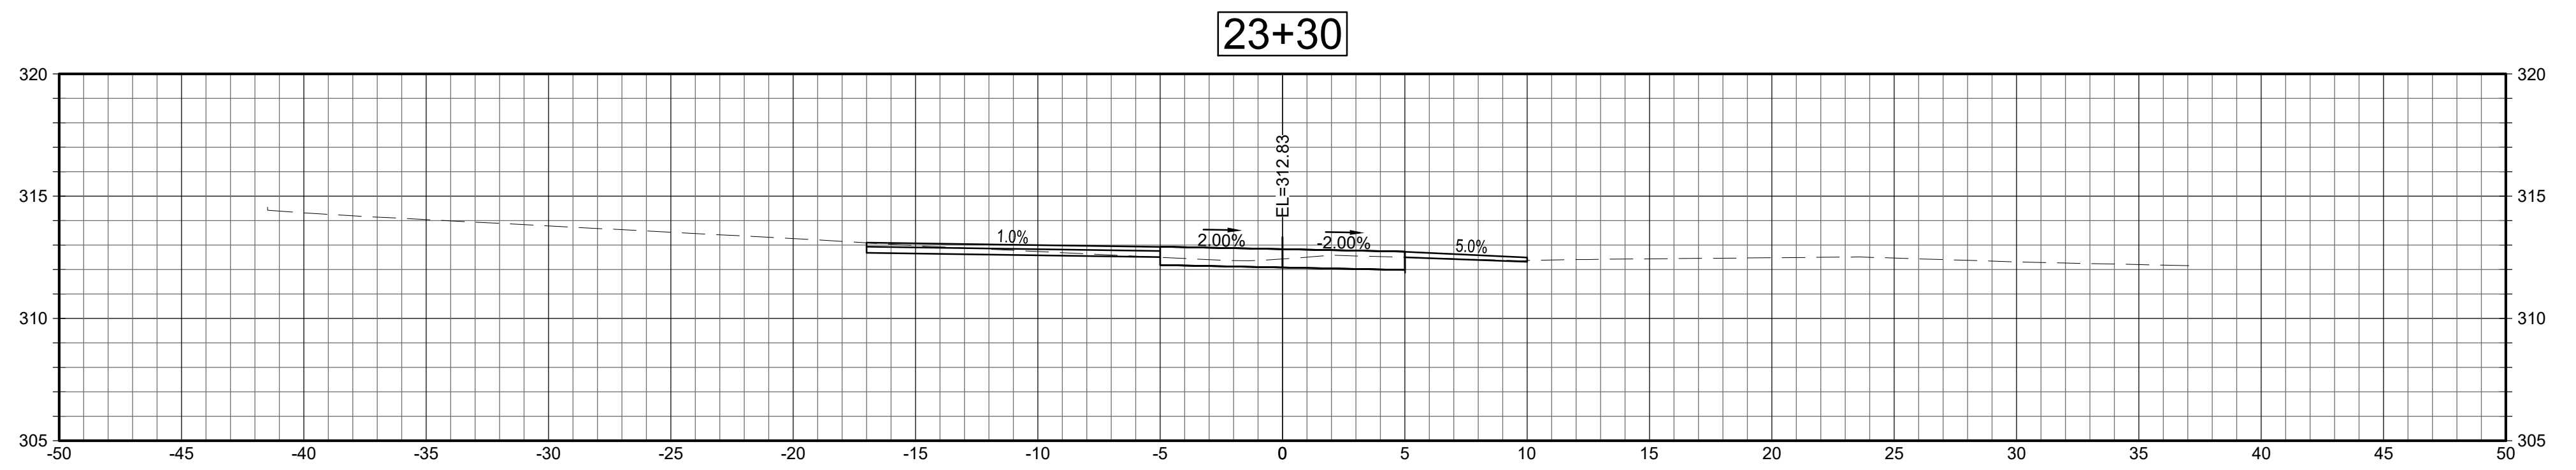
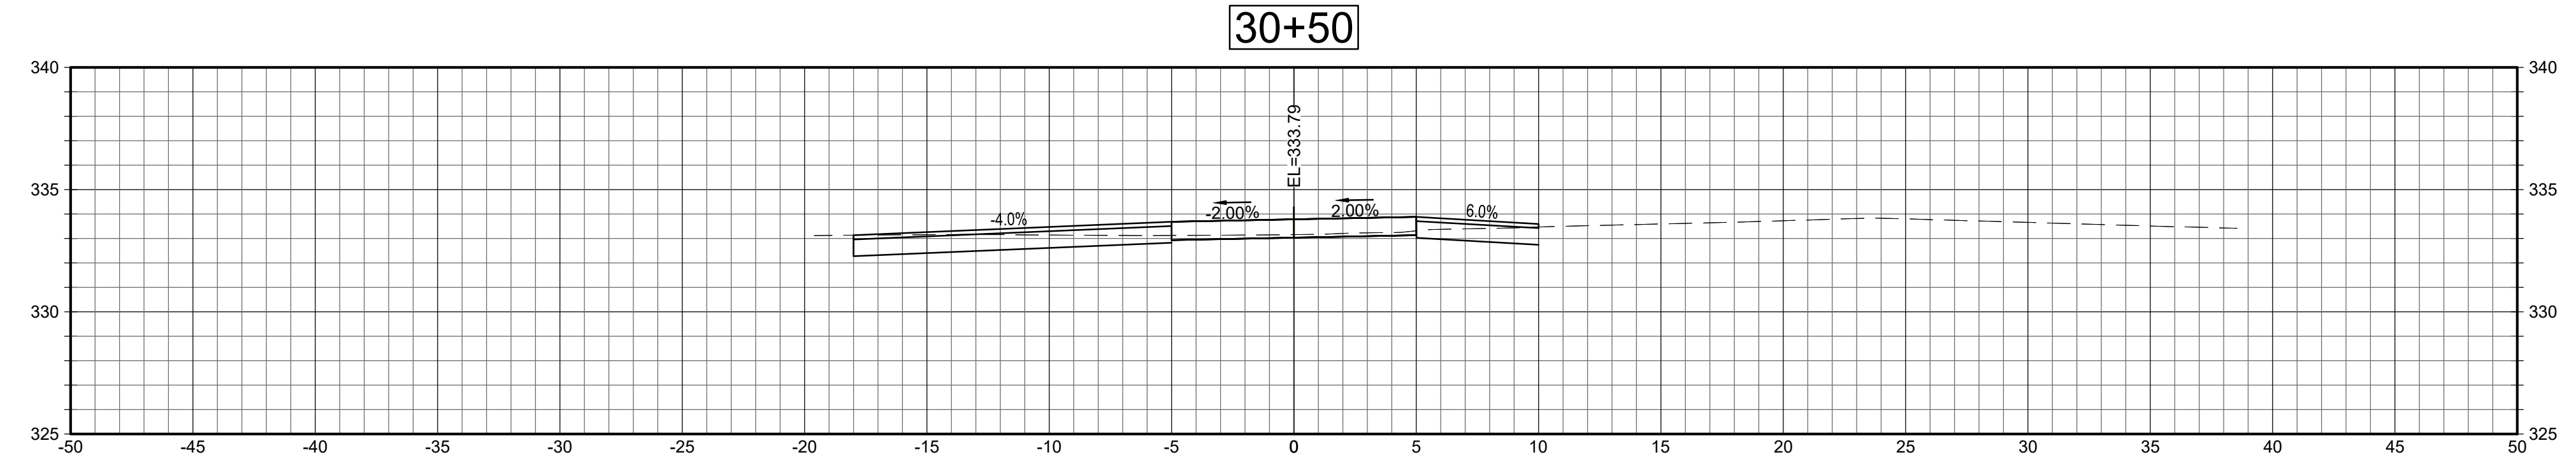
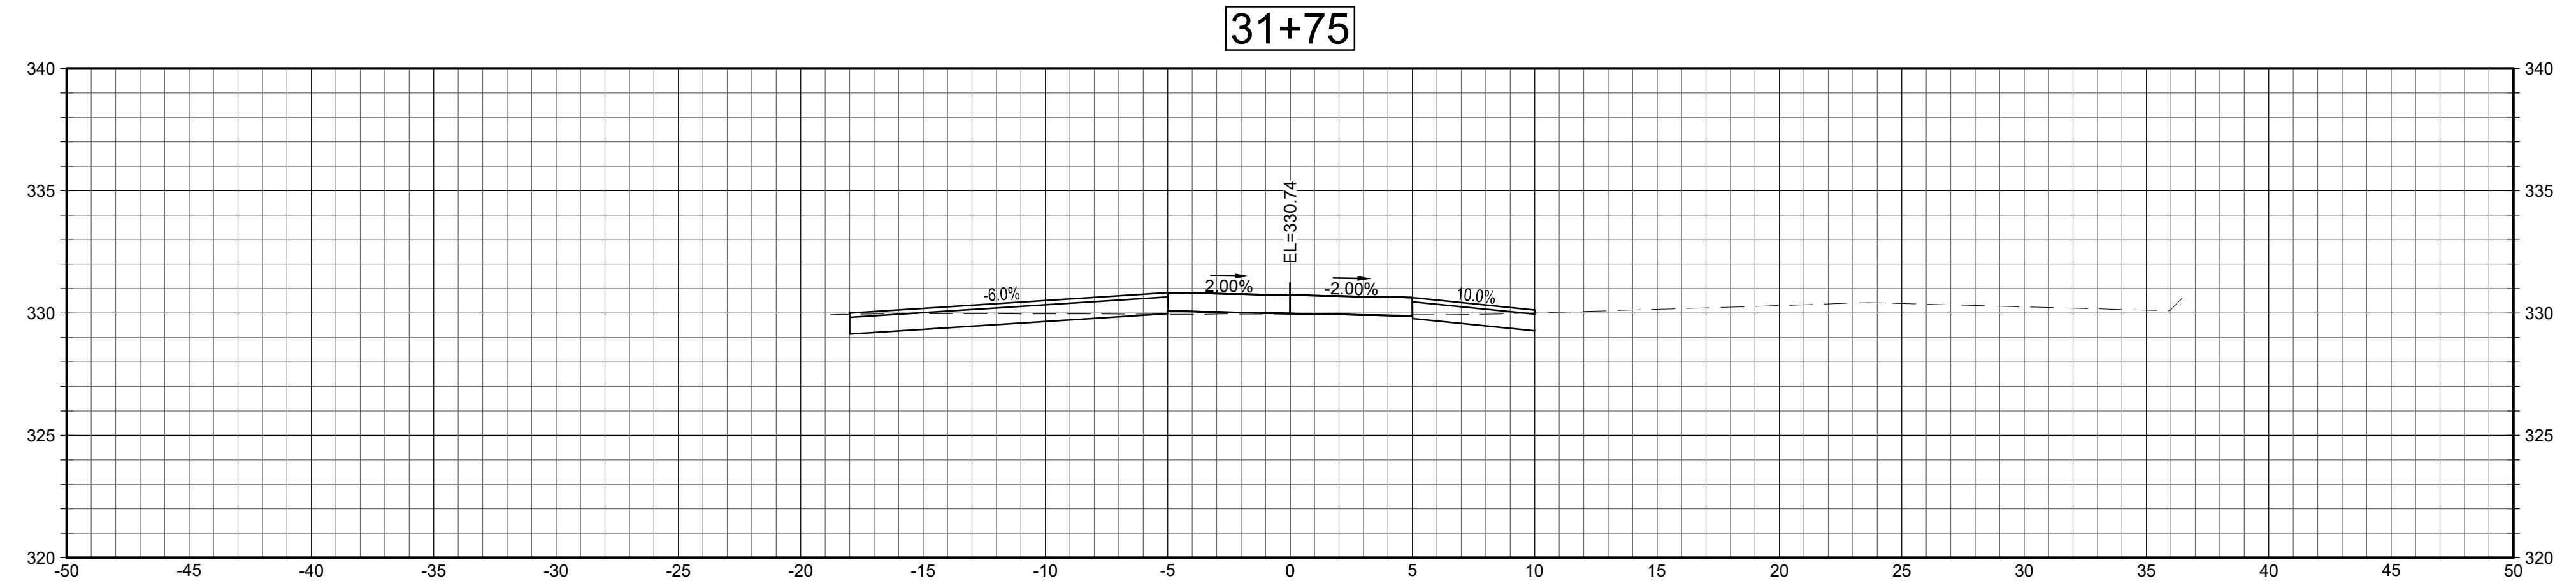
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Approved By: LAS
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W&S File No.:

Drawing Title:
CRITICAL CROSS SECTIONS

Sheet Number:
XSC-2



SECTIONS

SCALE: 1"=5'





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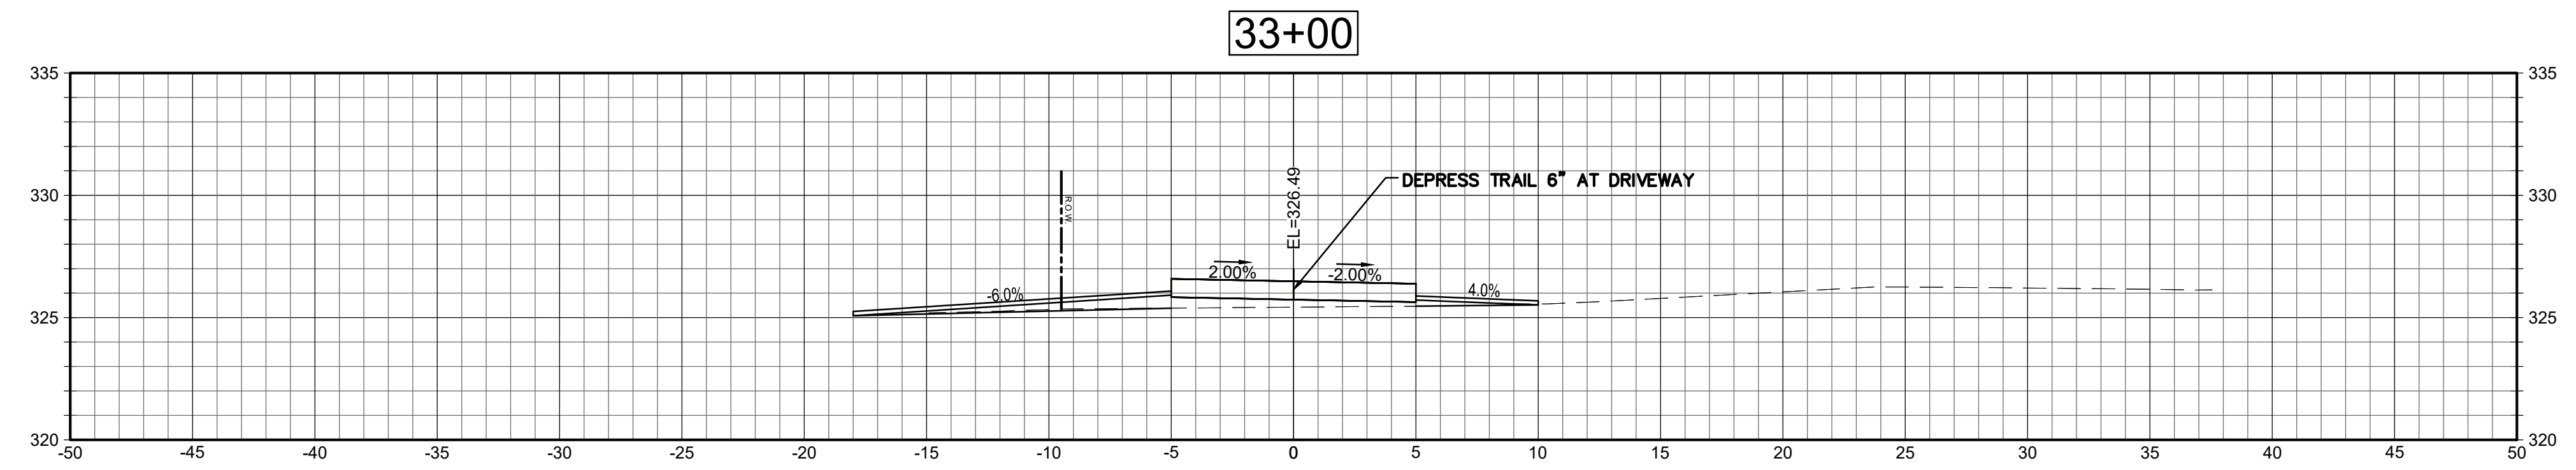
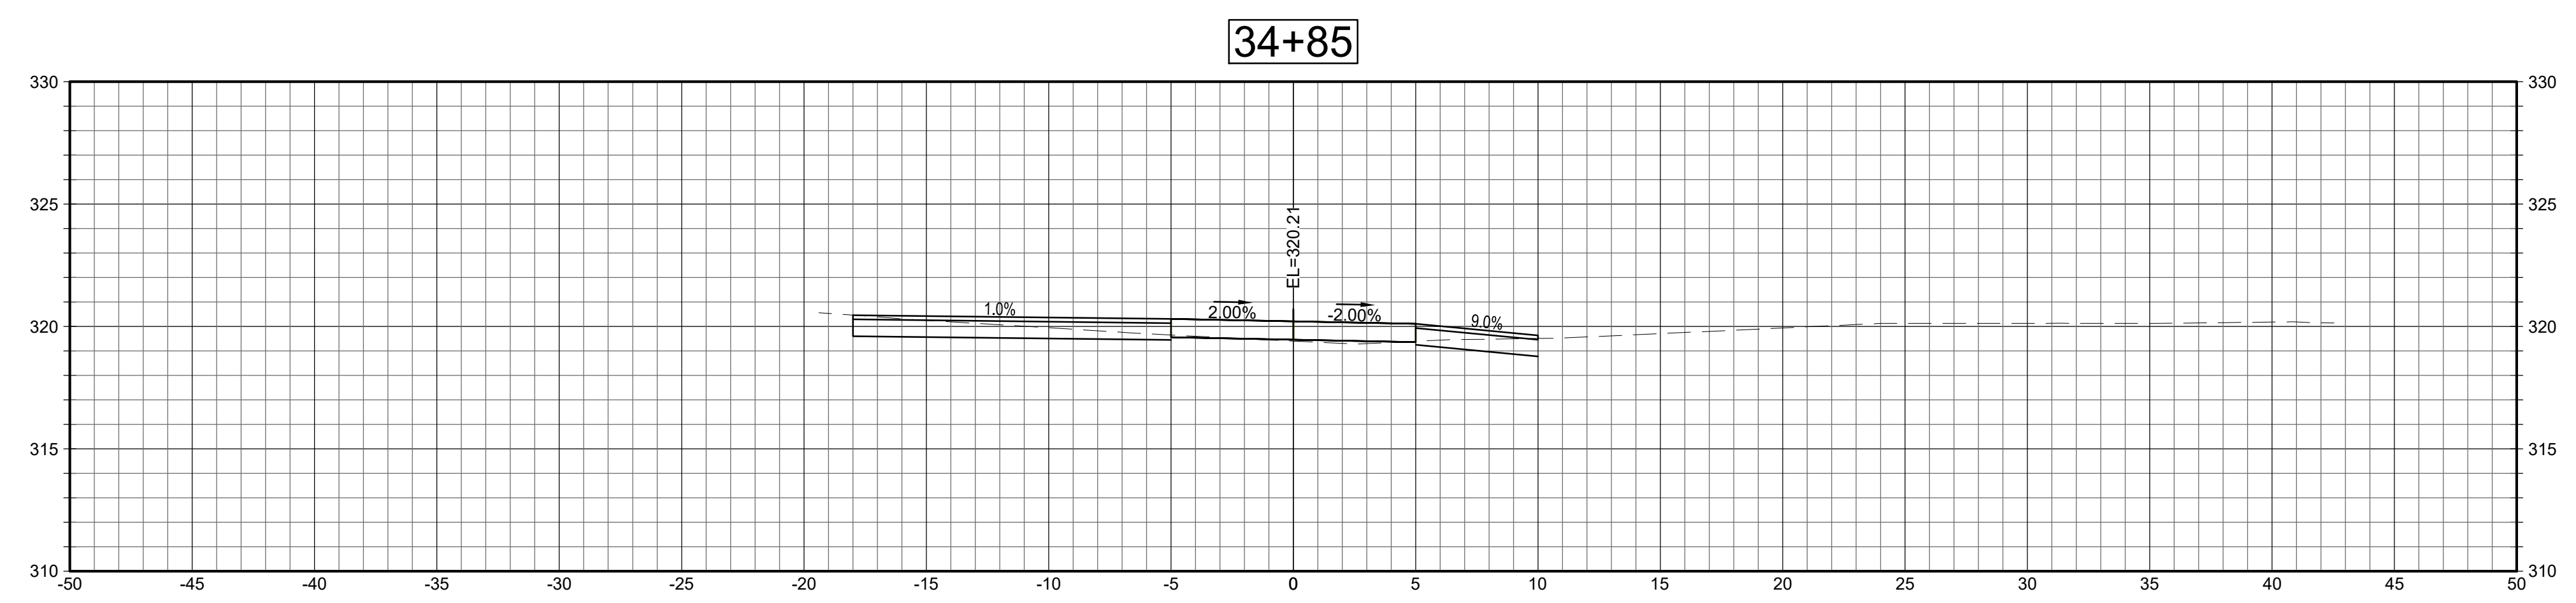
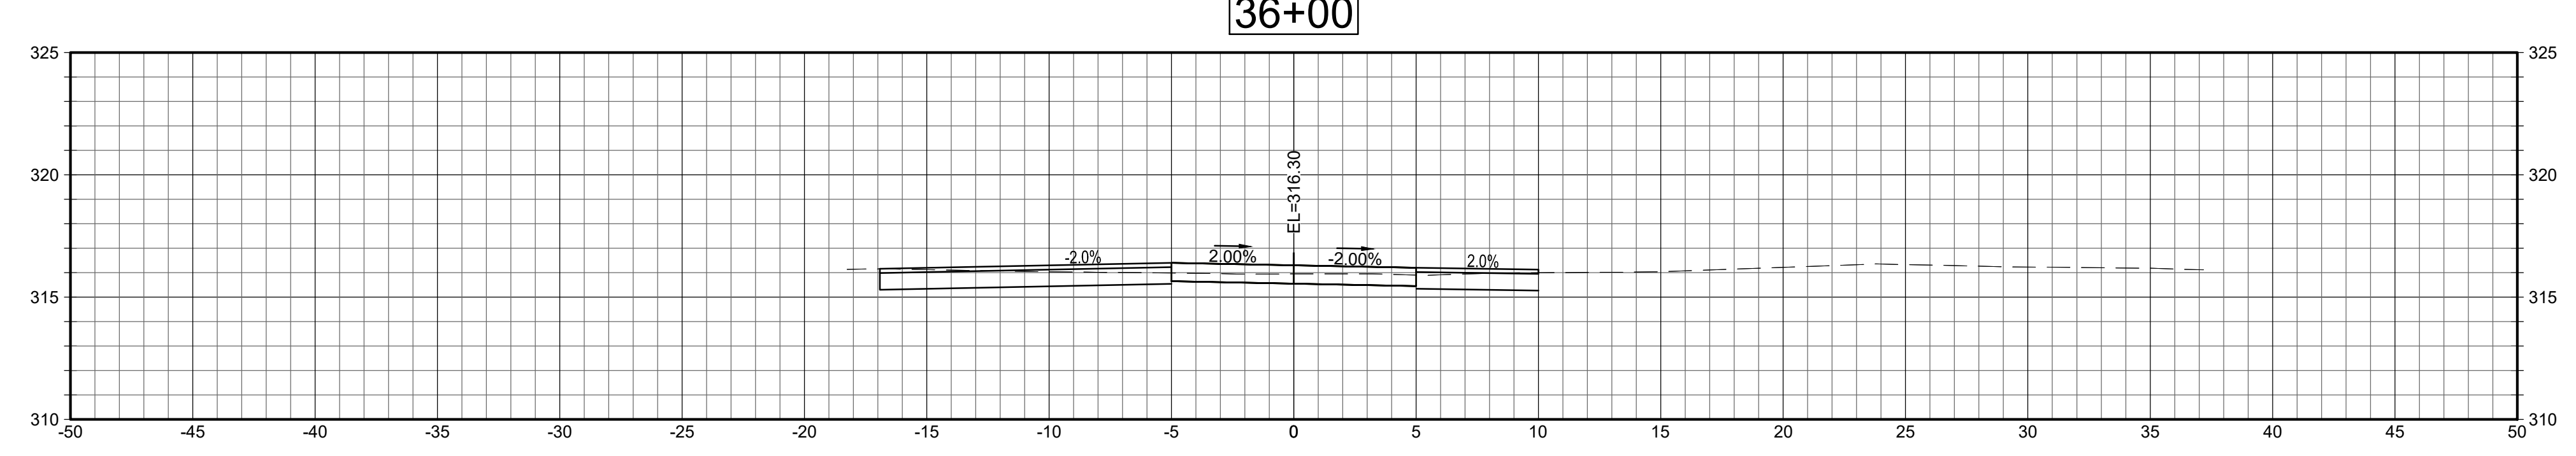
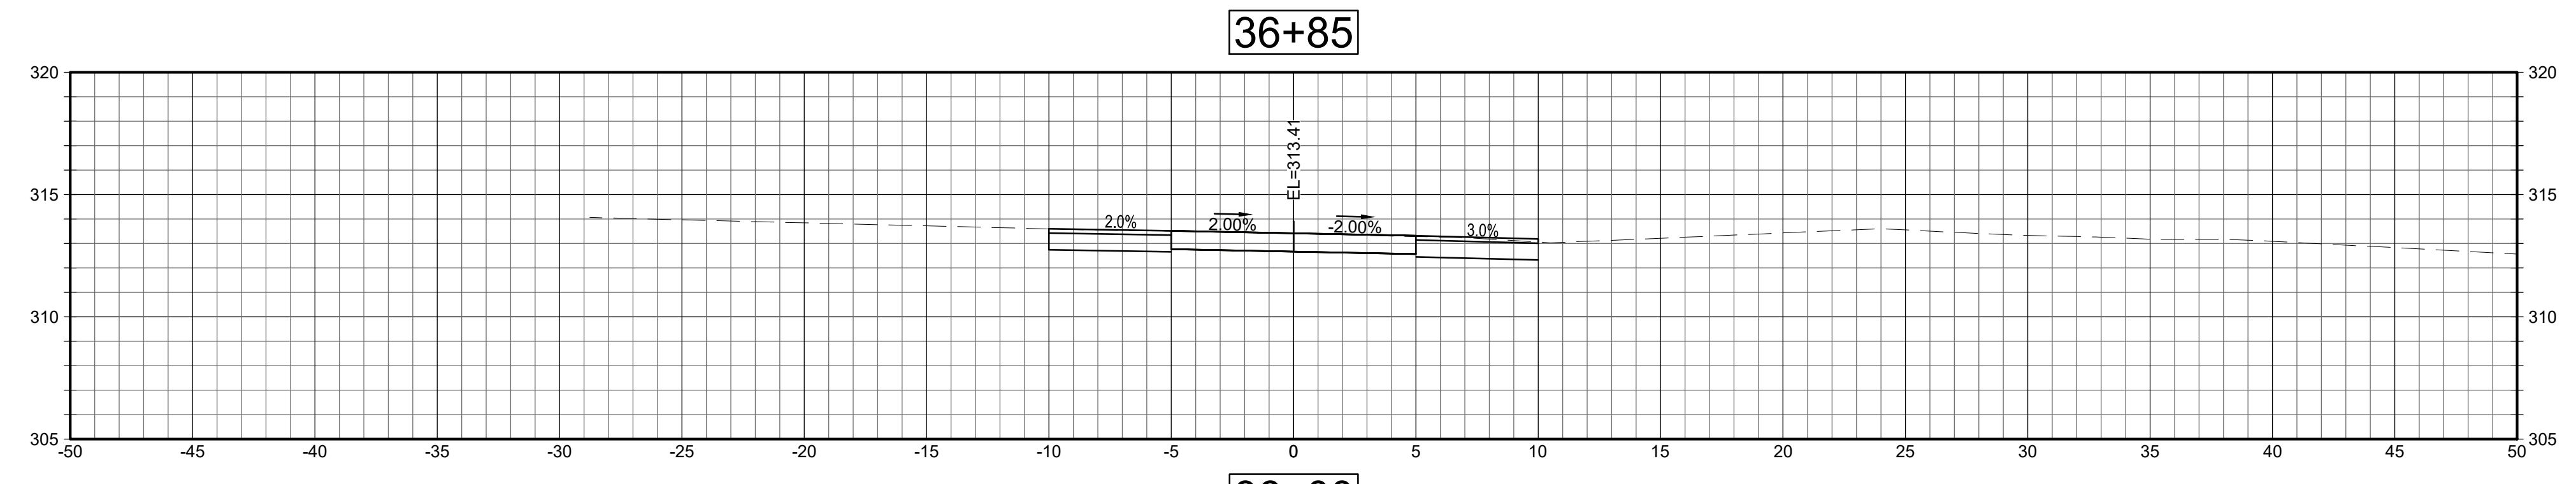
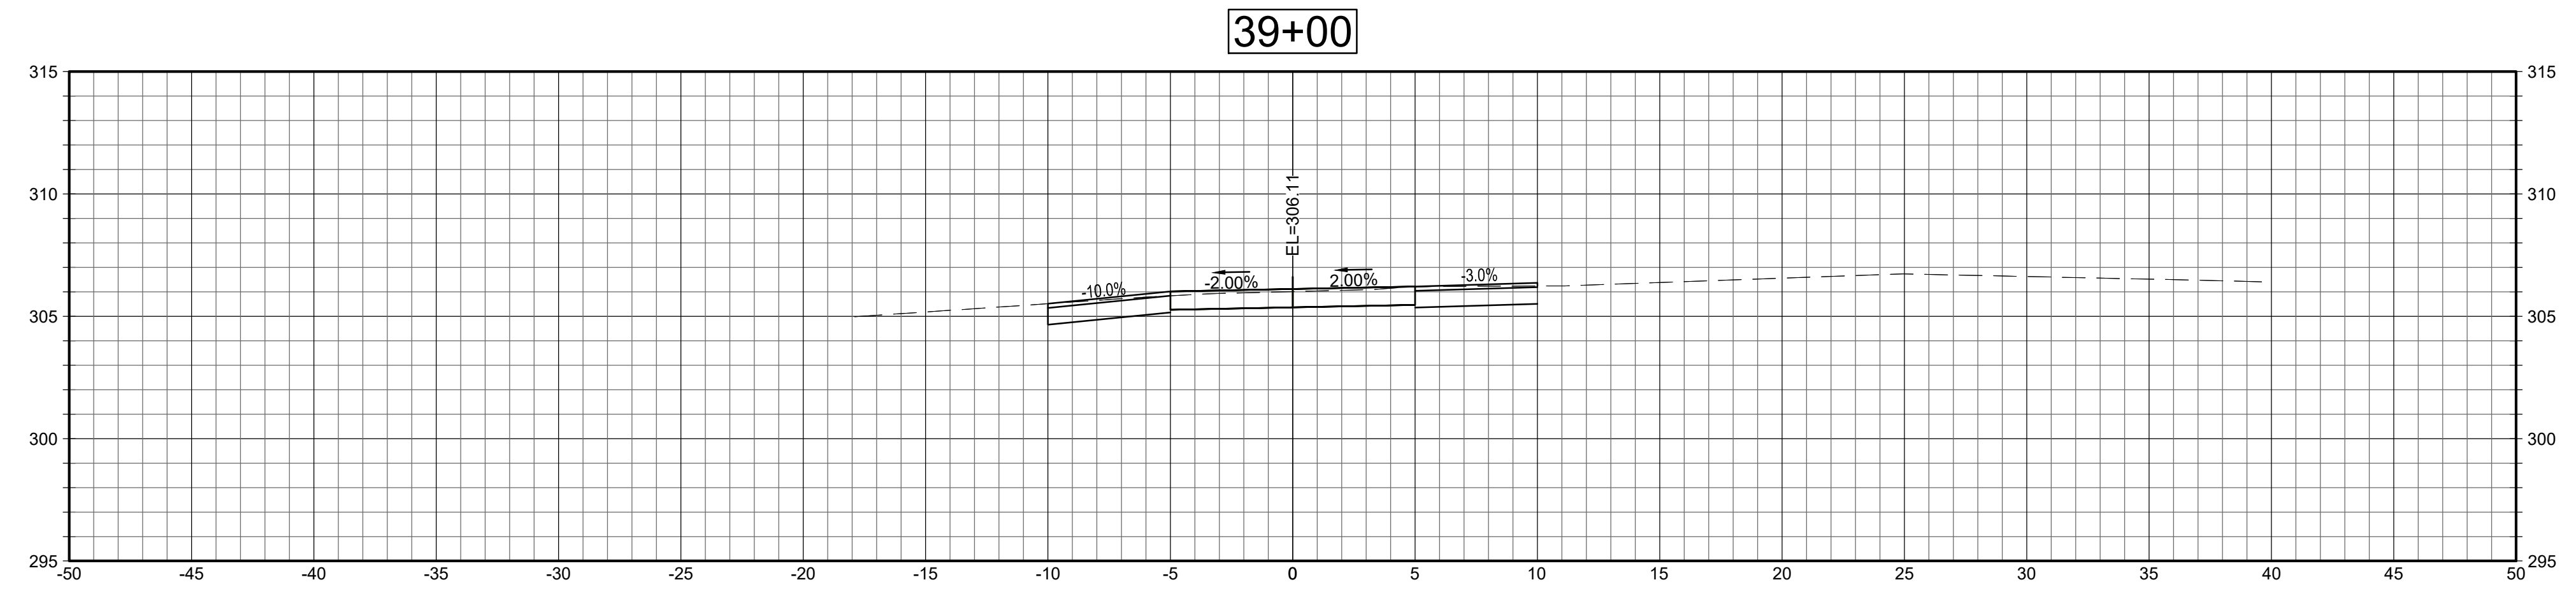
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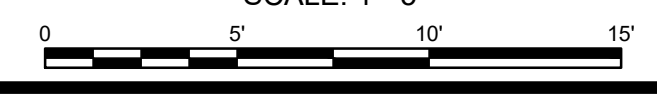
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**CRITICAL CROSS
SECTIONS**

Sheet Number:
XSC-3



SECTIONS
SCALE: 1"=5'





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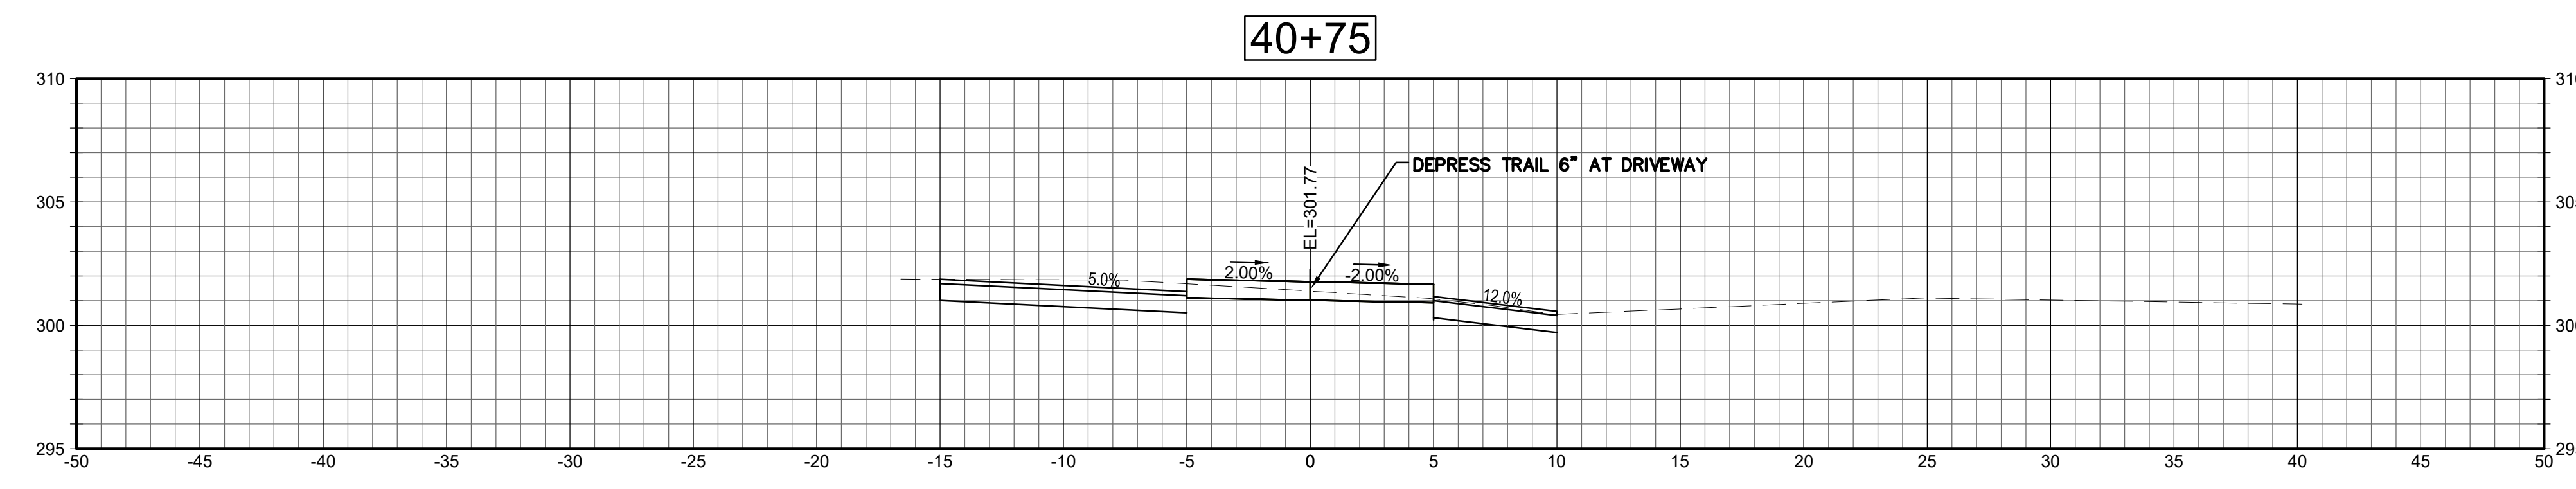
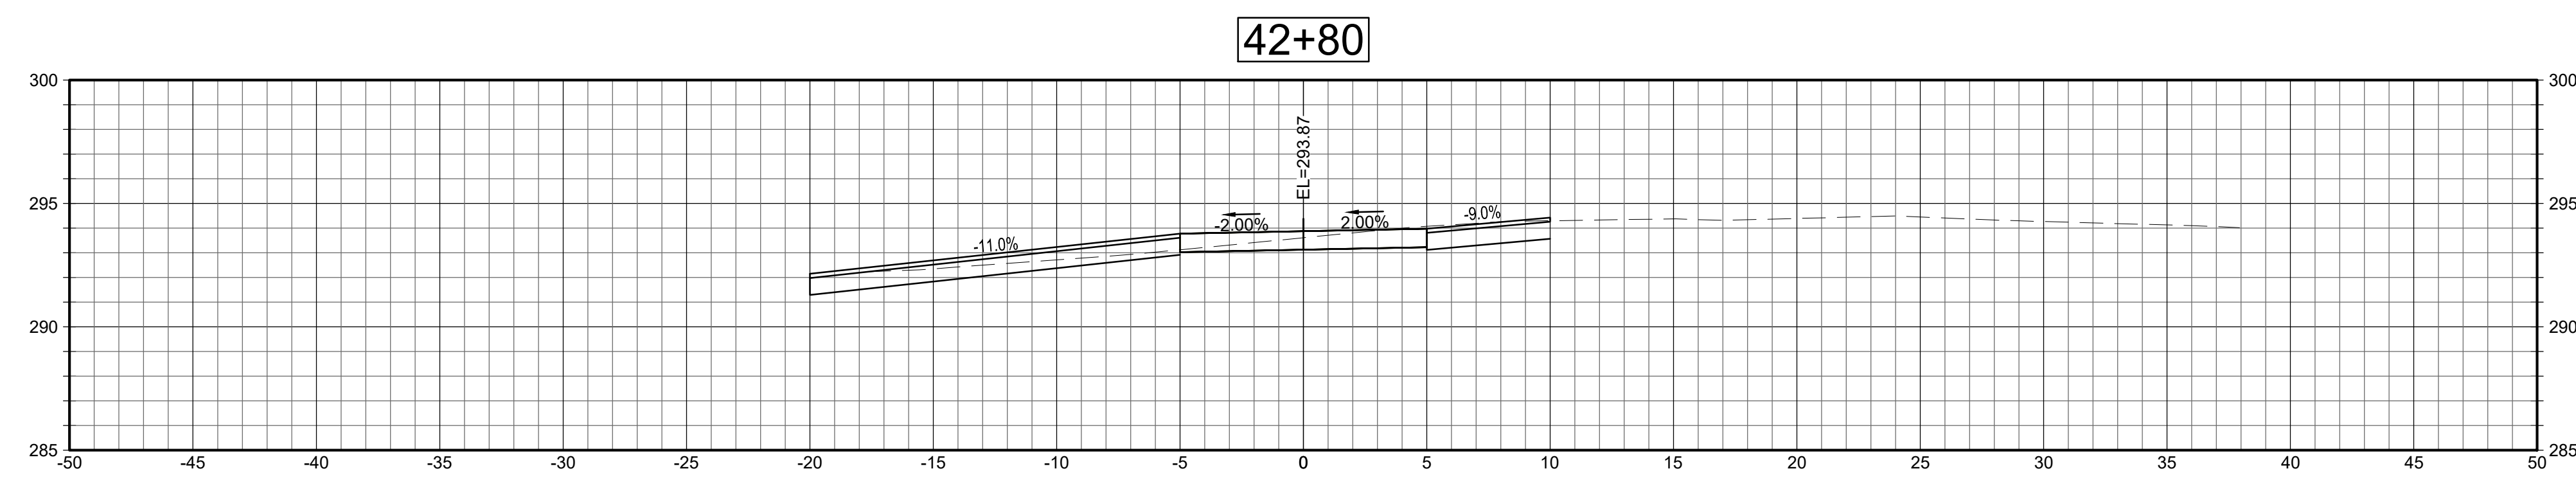
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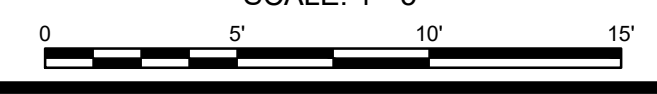
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Sheet Number:
XSC-4



SECTIONS

SCALE: 1"=5'





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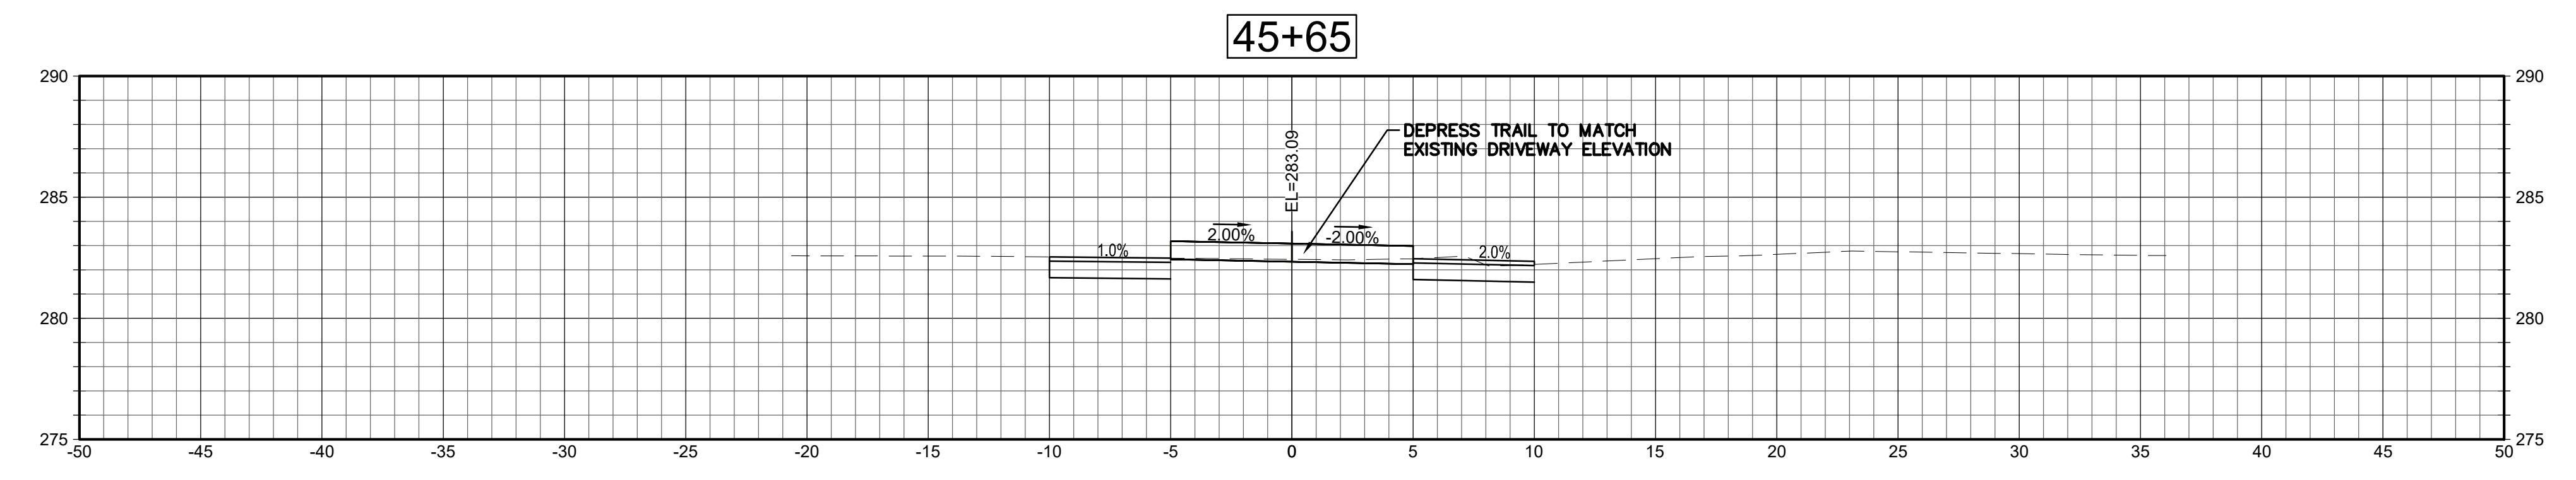
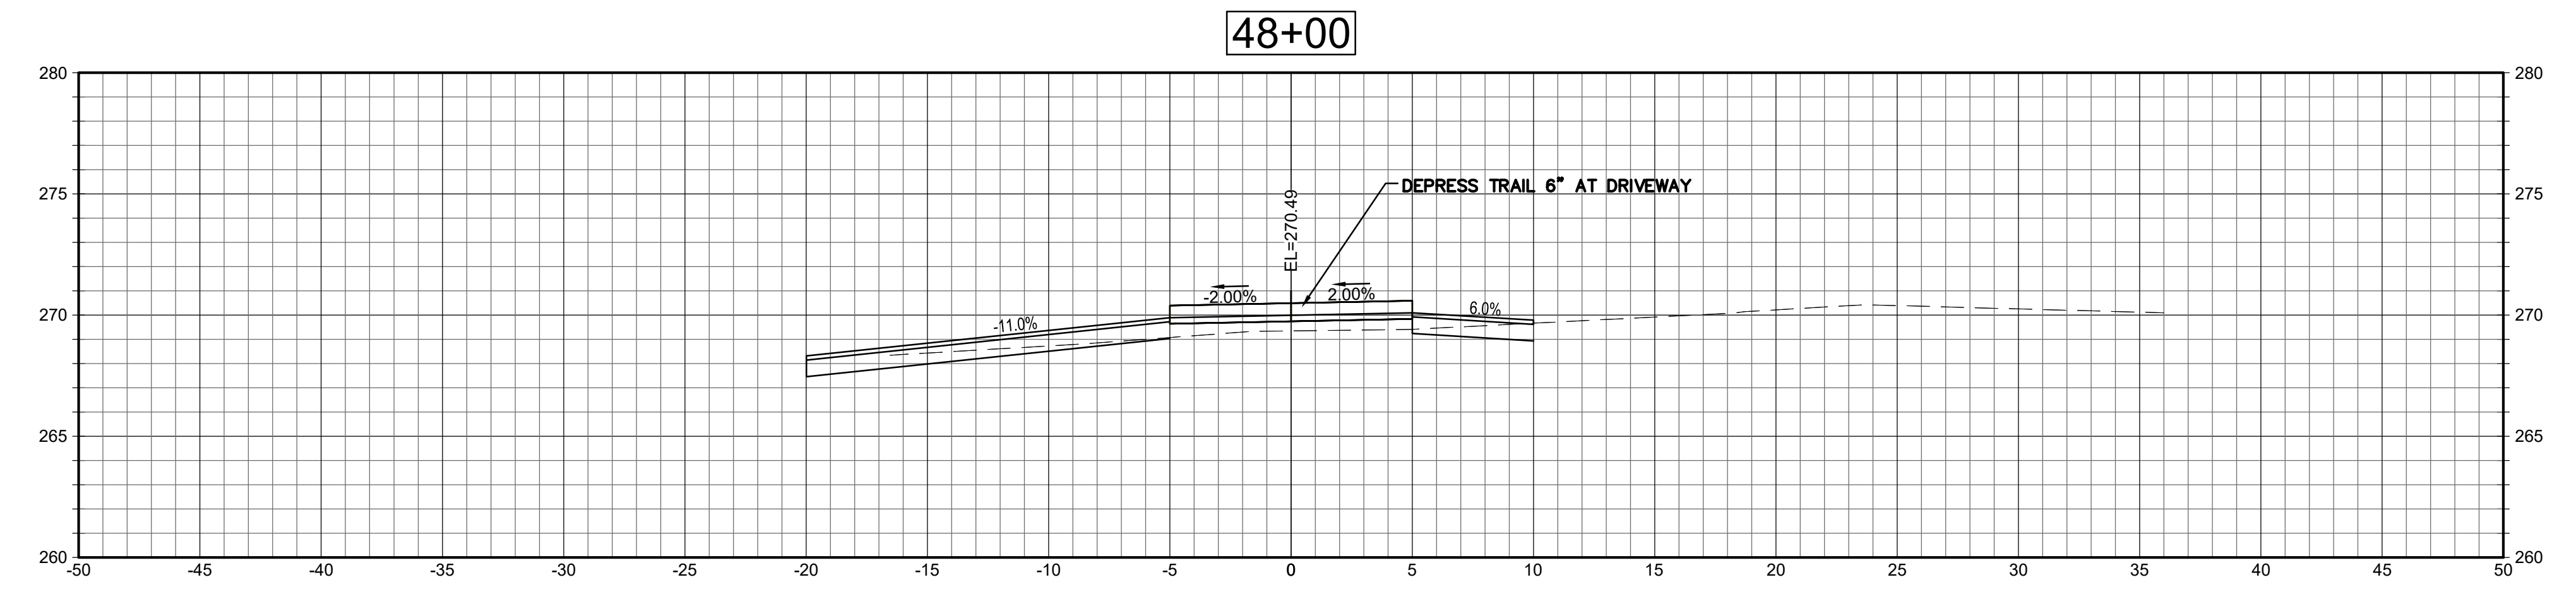
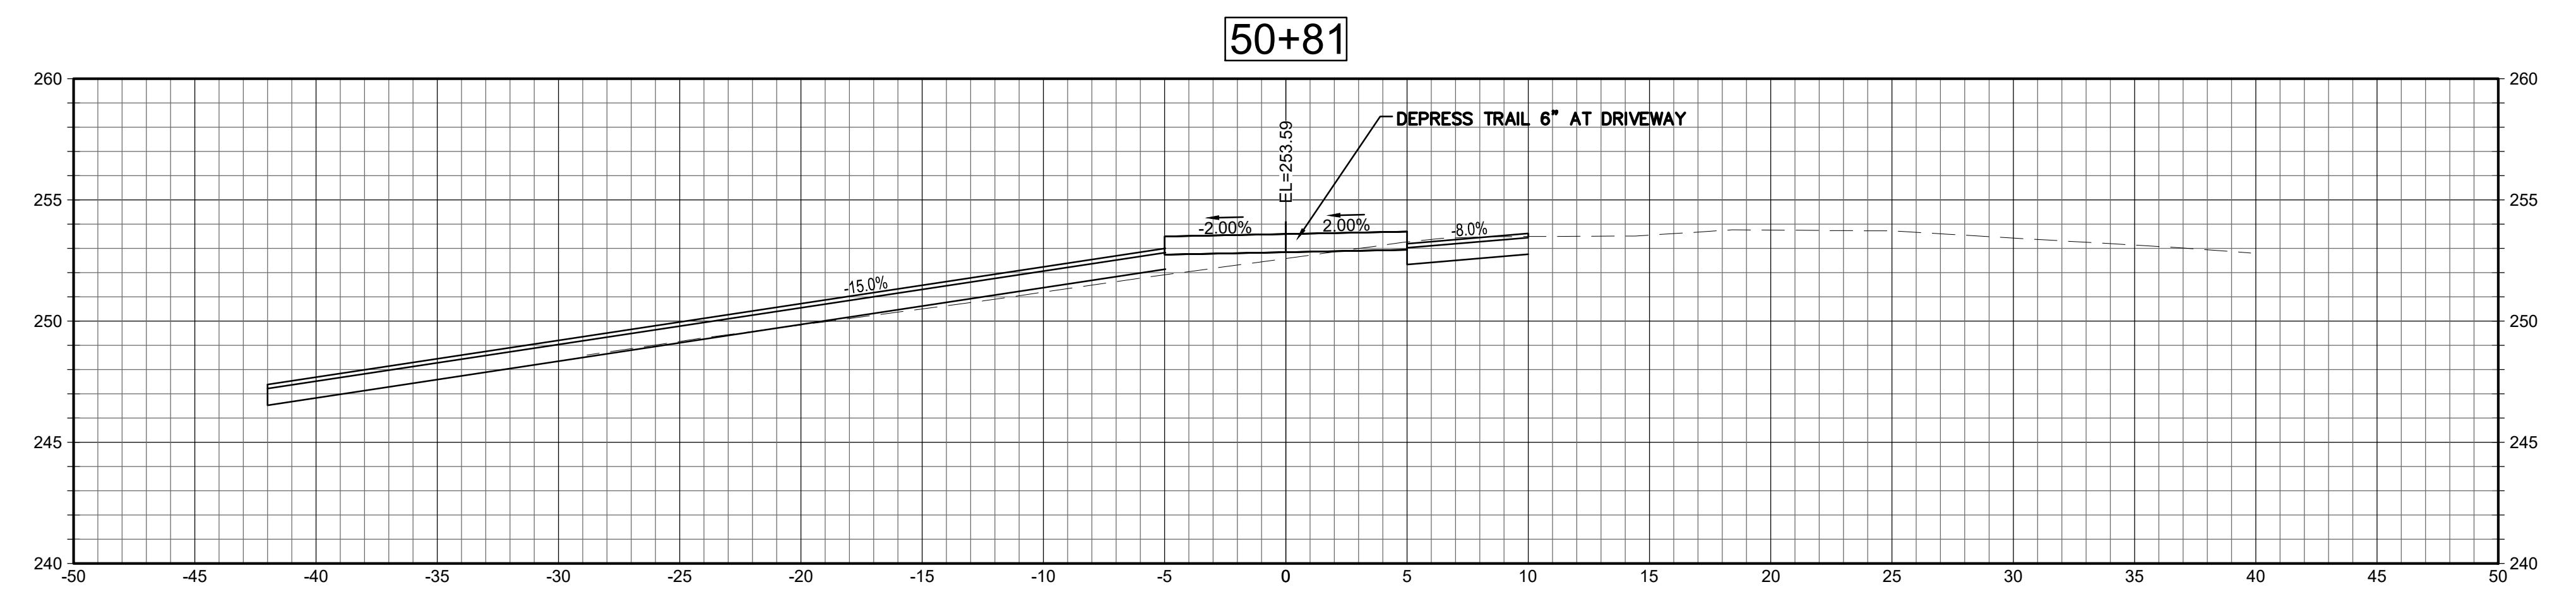
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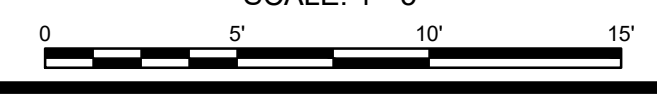
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SECTIONS**

Sheet Number:
XSC-5



SECTIONS
SCALE: 1"=5'





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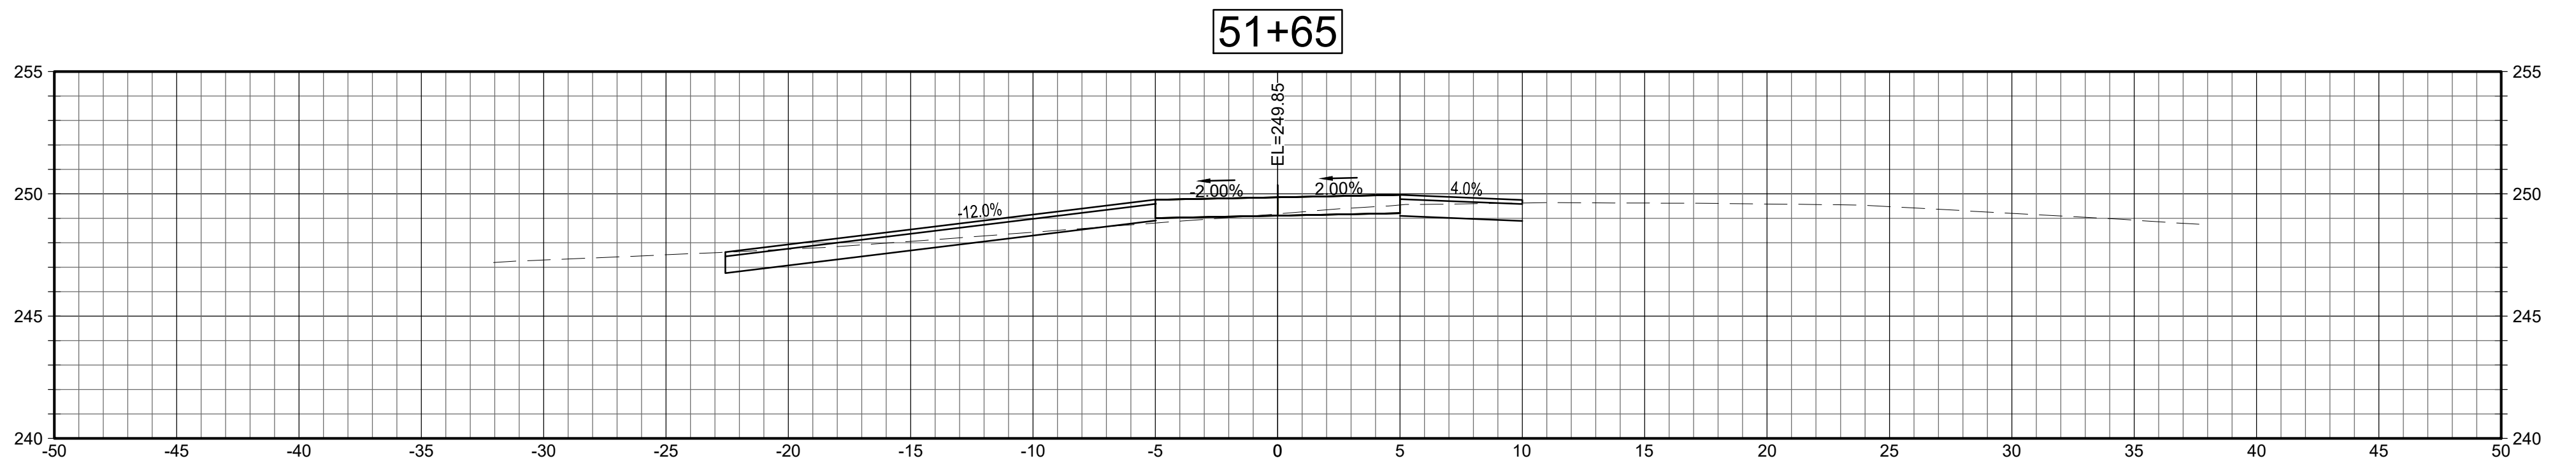
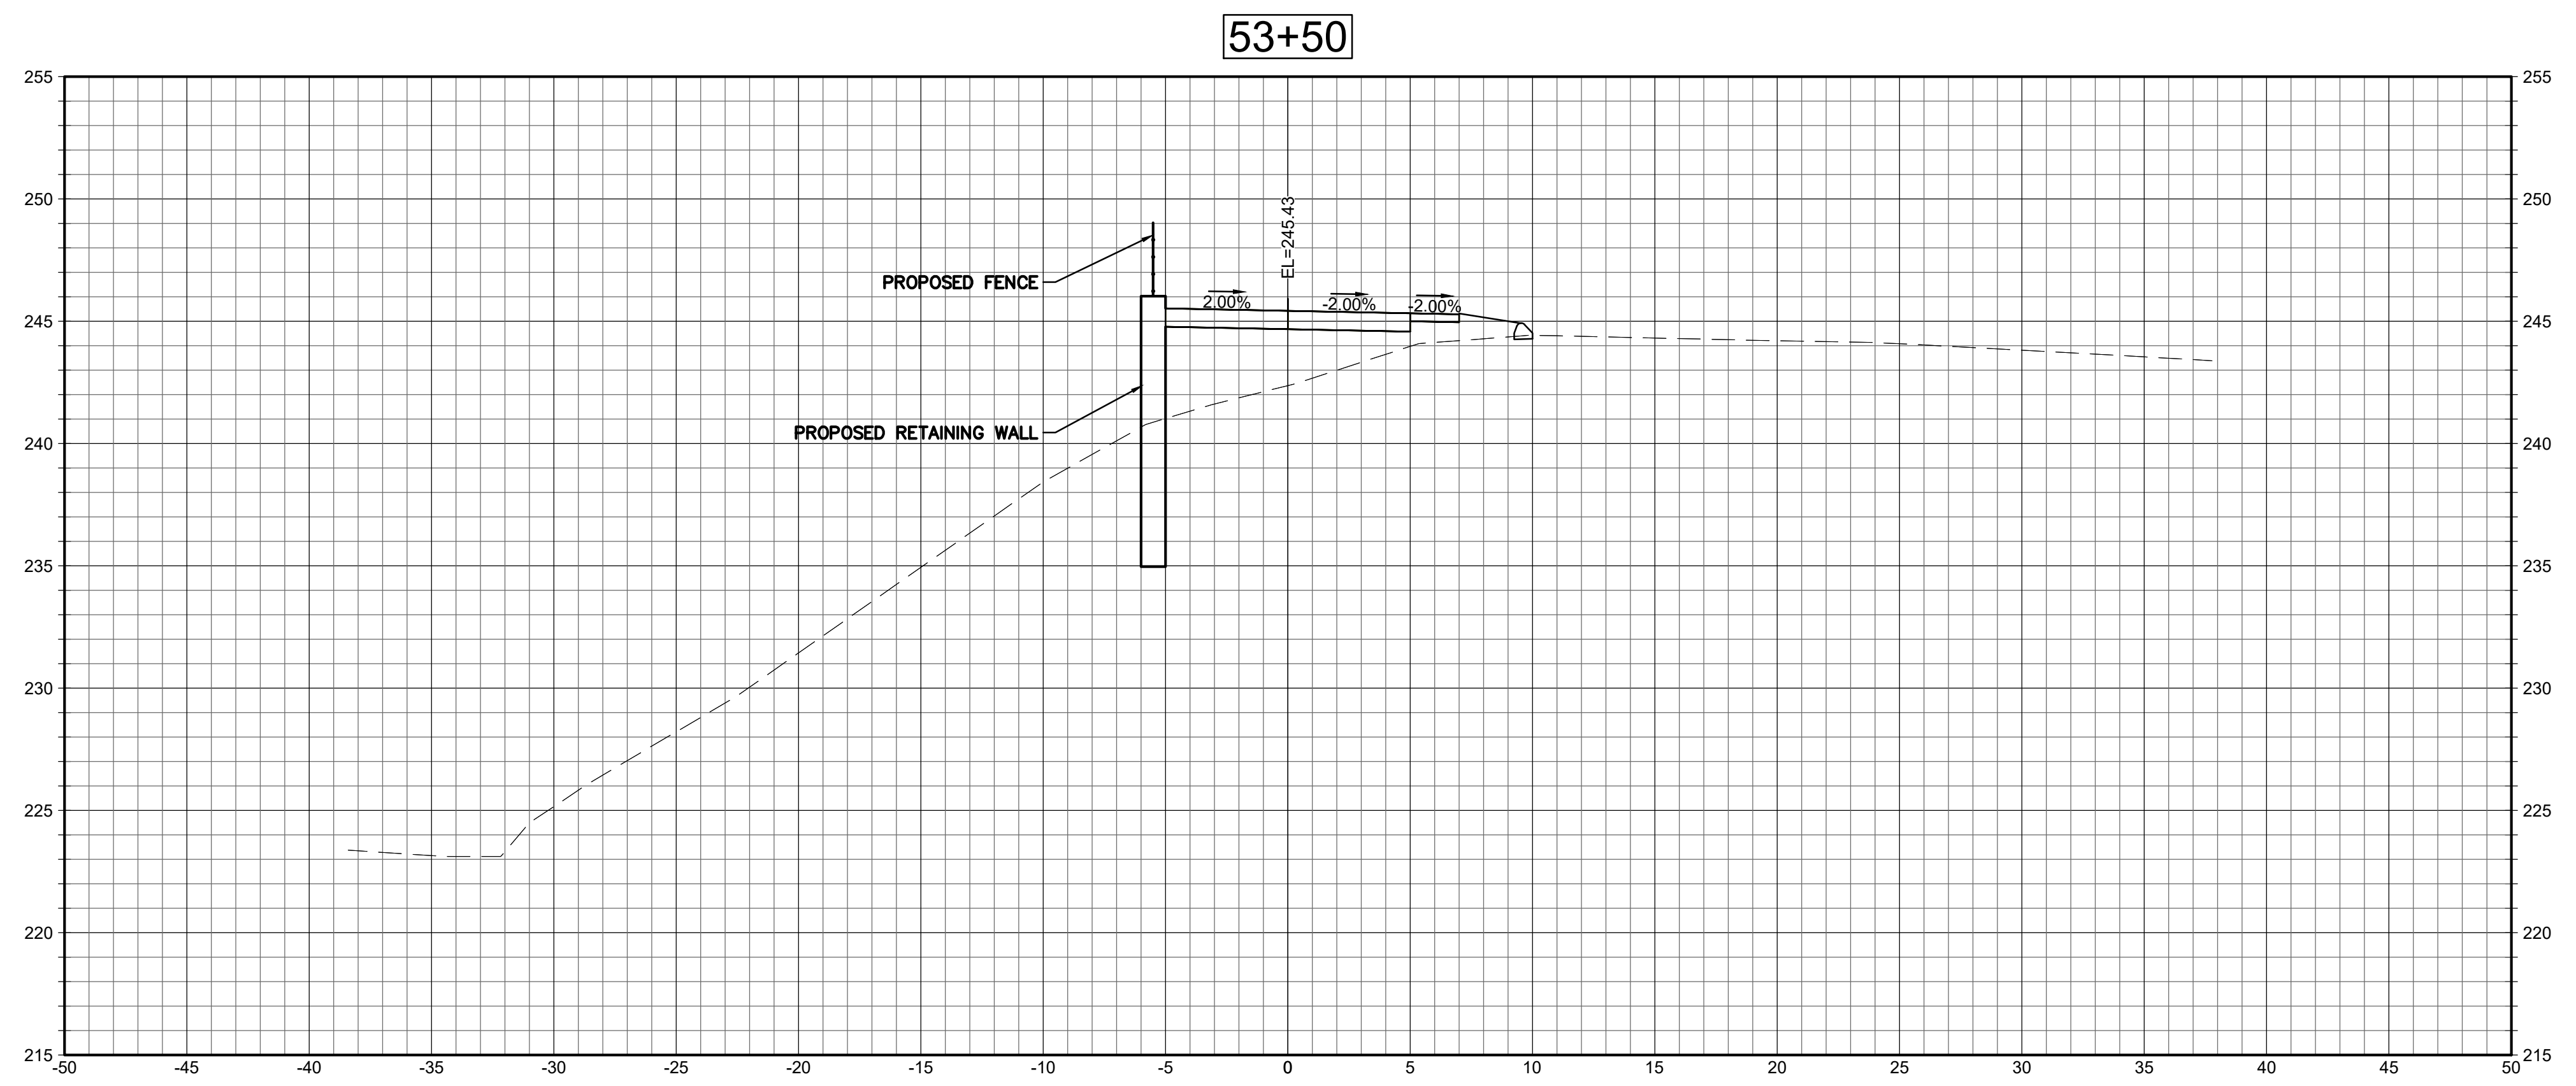
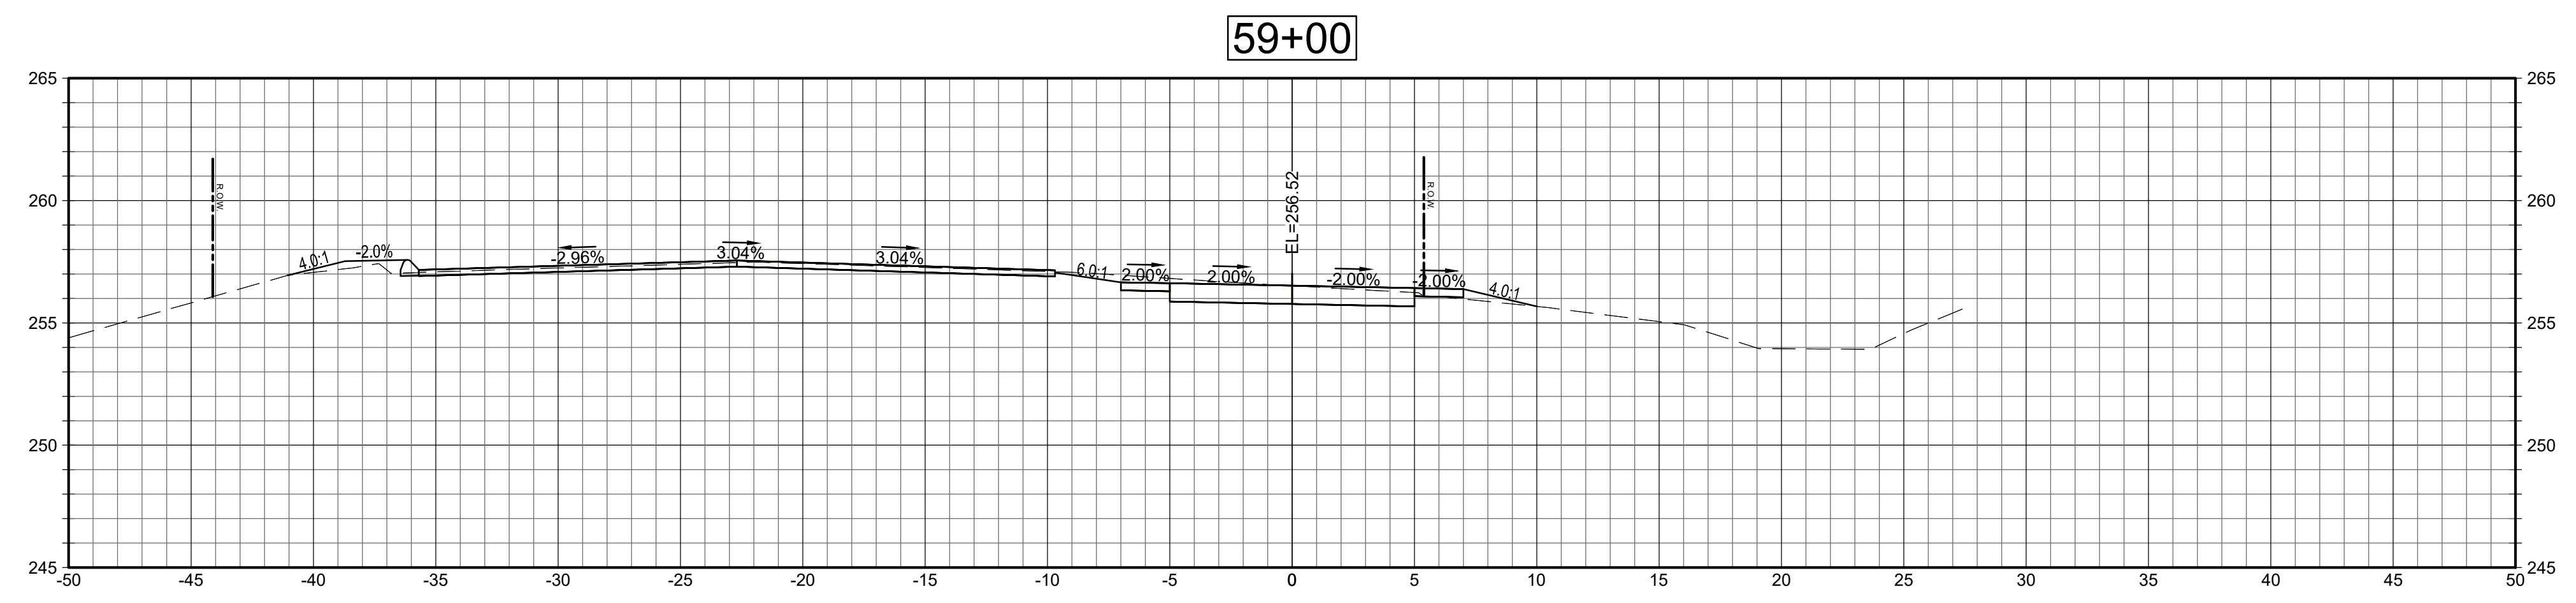
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CRITICAL CROSS SECTIONS

Sheet Number:
XSC-6



SECTIONS
SCALE: 1"=5'

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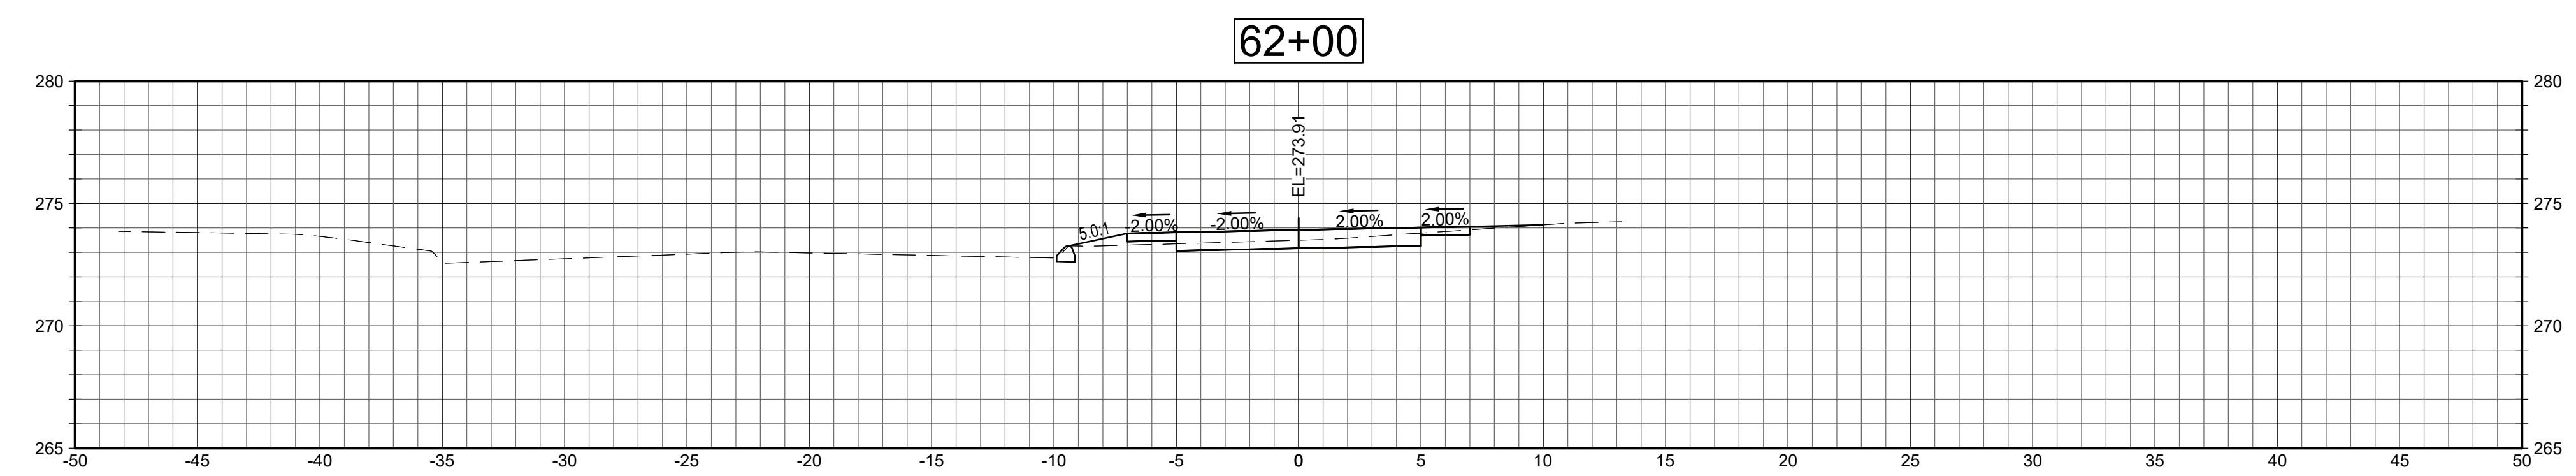
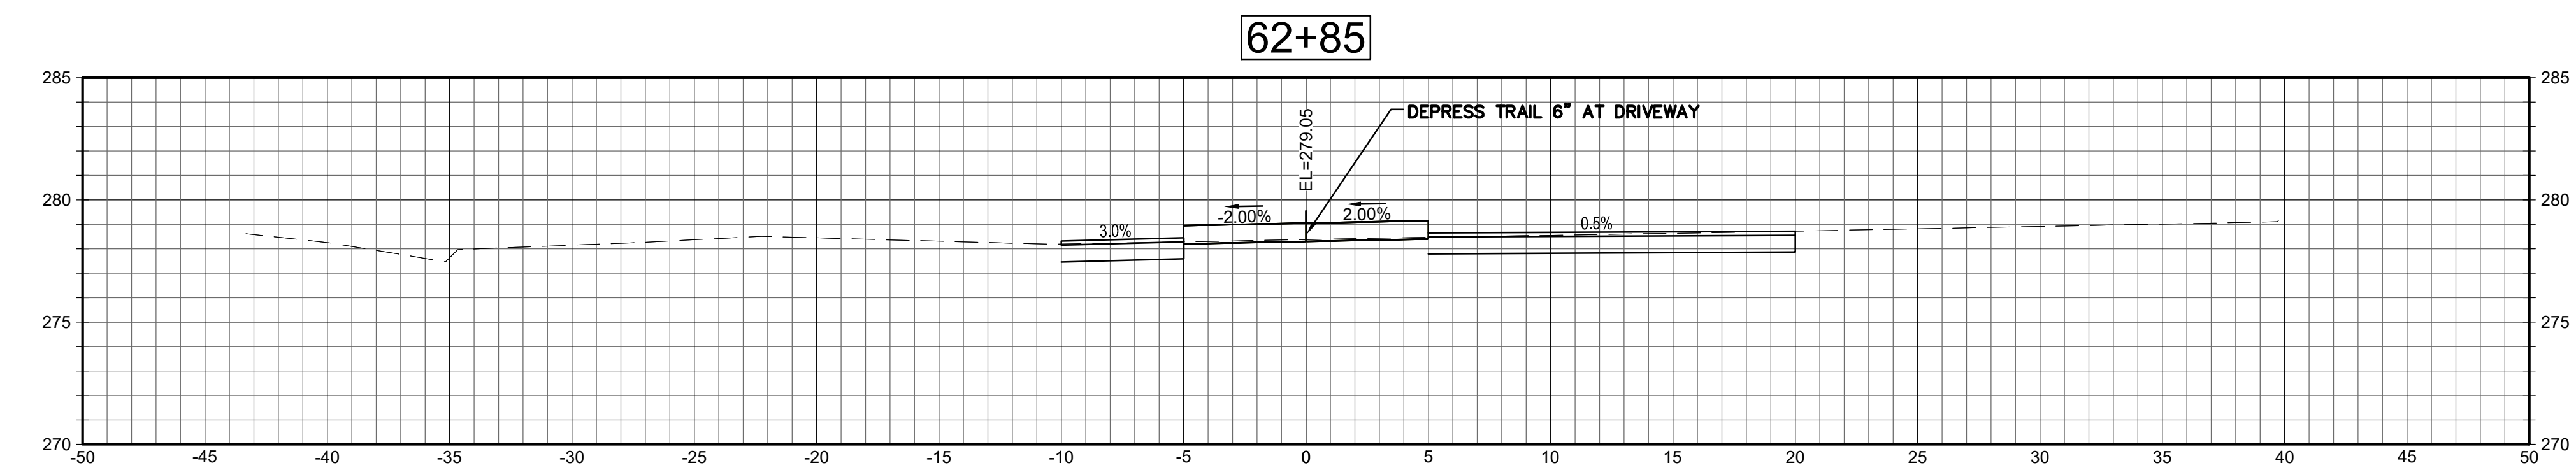
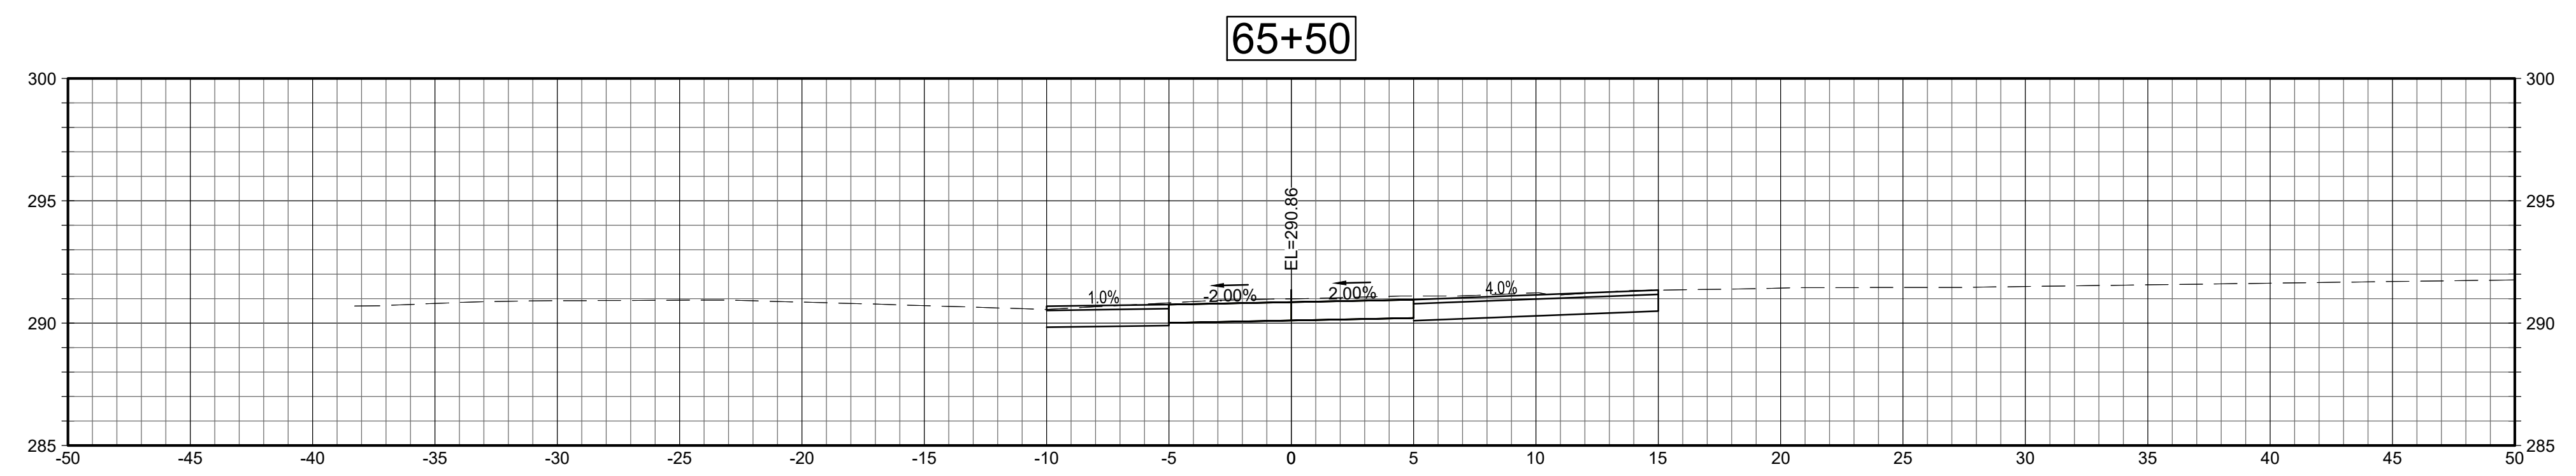
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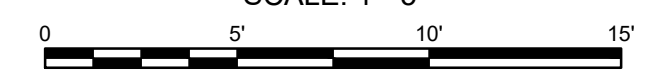
**CRITICAL CROSS
SECTIONS**

Sheet Number:

XSC-7



SECTIONS
SCALE: 1"=5'



Project: TOWN OF LEDYARD, CT



LEDYARD HIGH SCHOOL
MULTI-USE PATHWAY &
SIDEWALK EXTENSION
741 COLONEL LEDYARD HIGHWAY
LEDYARD, CT 06339



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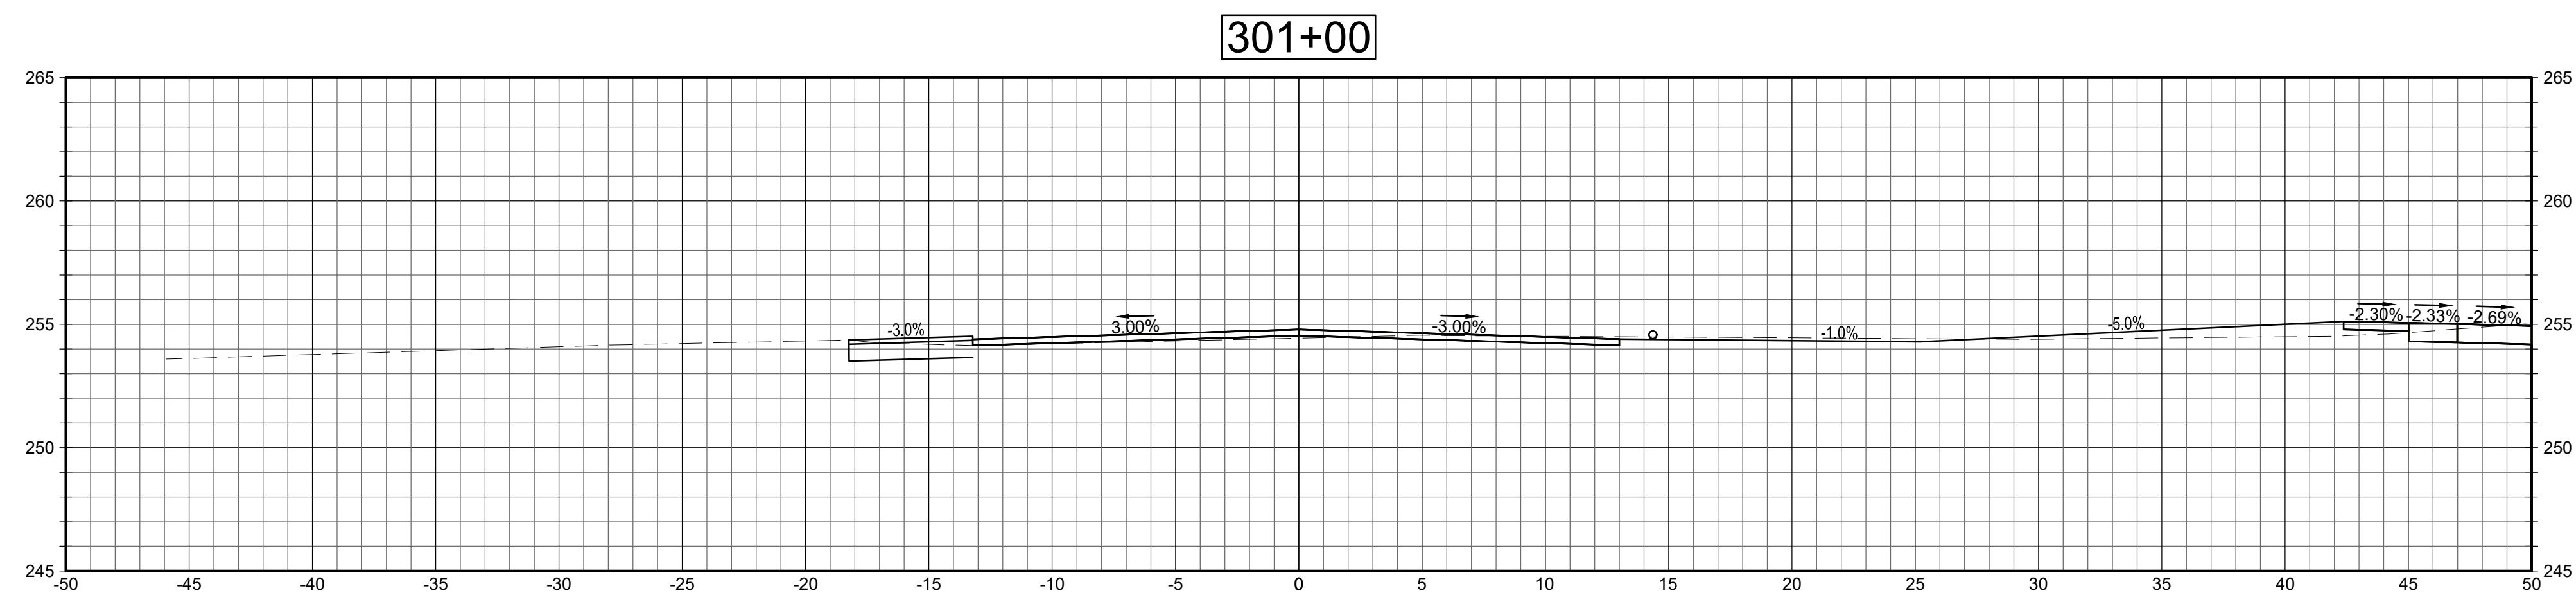
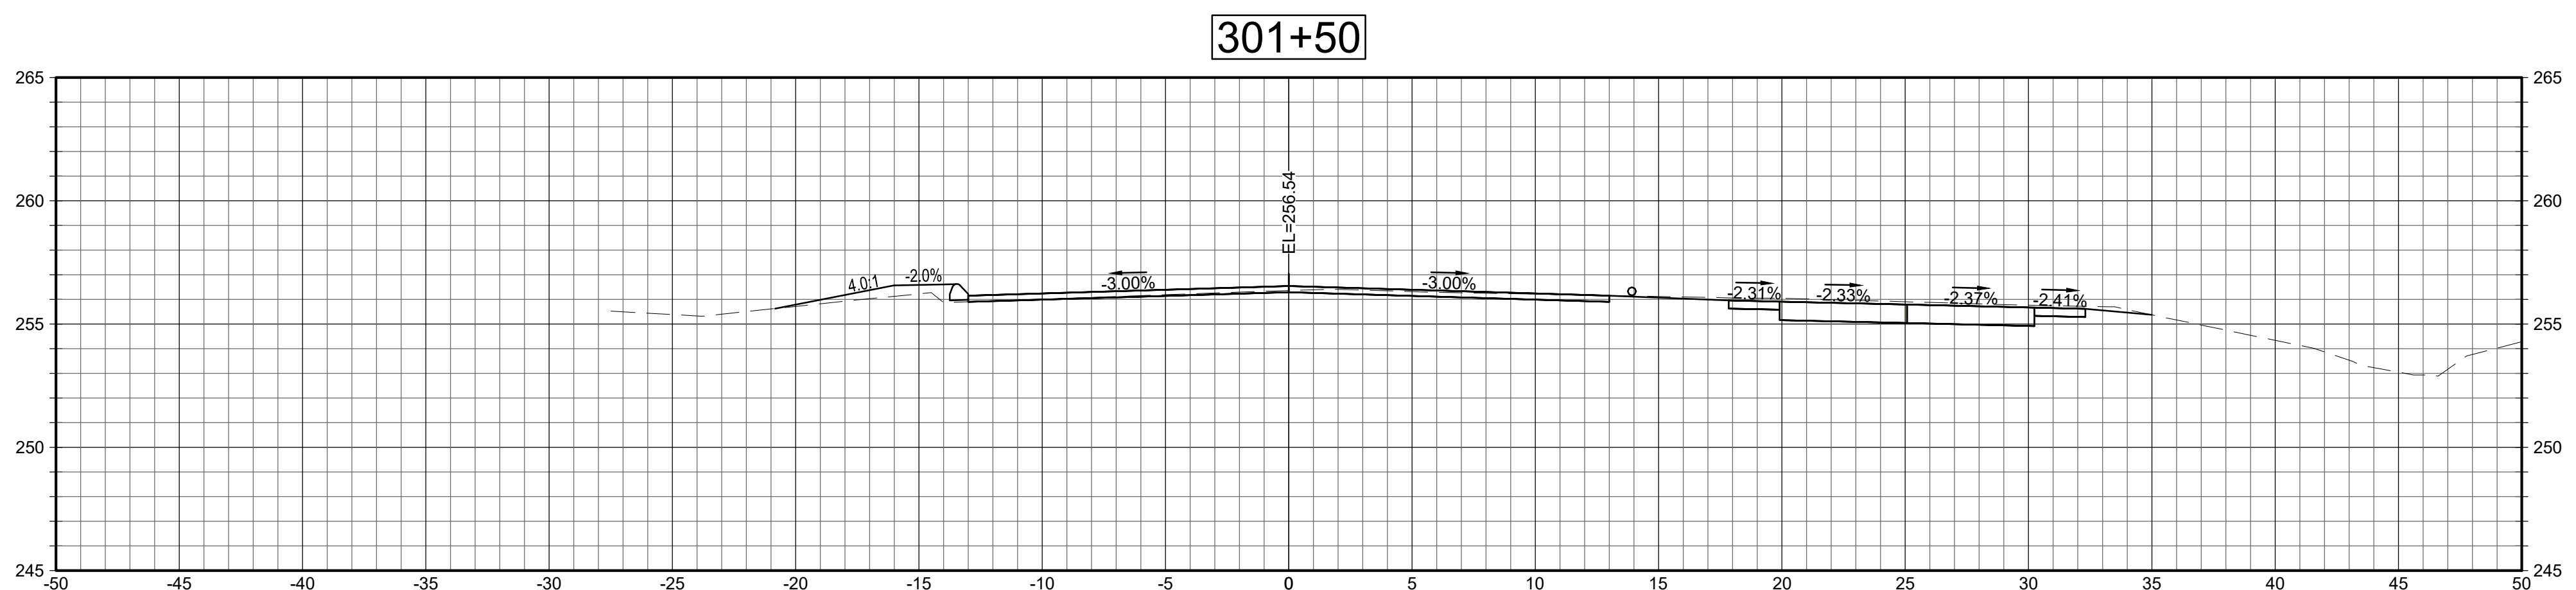
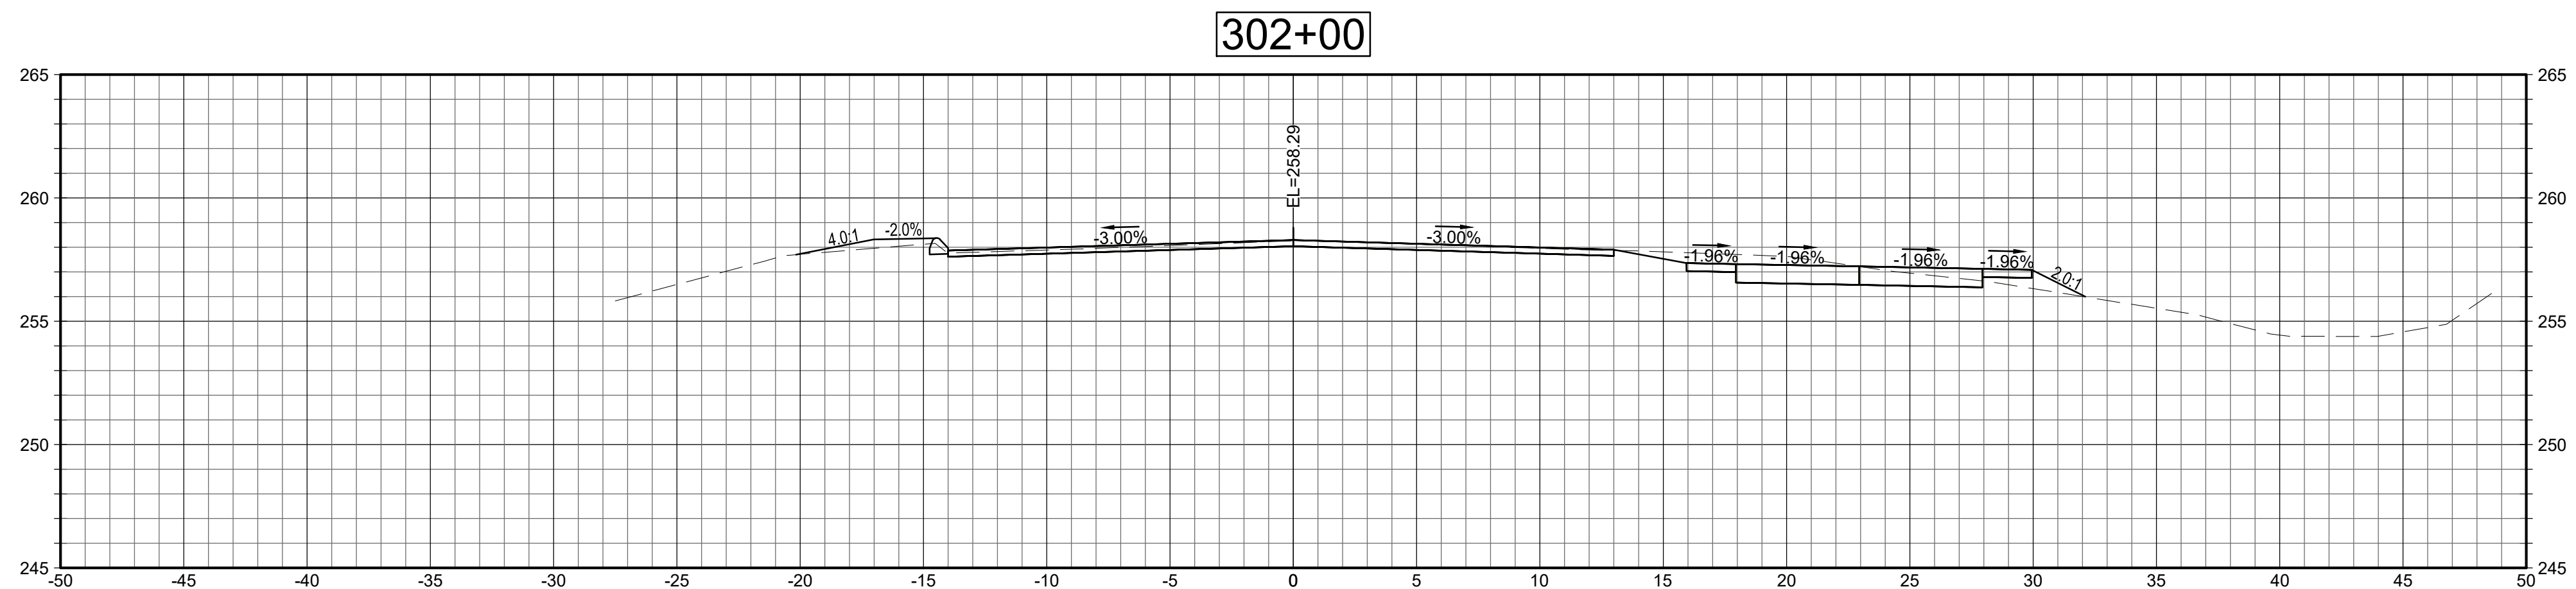
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SECTIONS

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